




VAMC-Sioux Falls: 2501 W 22nd St, Sioux Falls, SD 57105

SIOUX FALLS BOILER PLANT

VA PROJECT NUMBER: 438-22-900

100% CONSTRUCTION DOCUMENTS

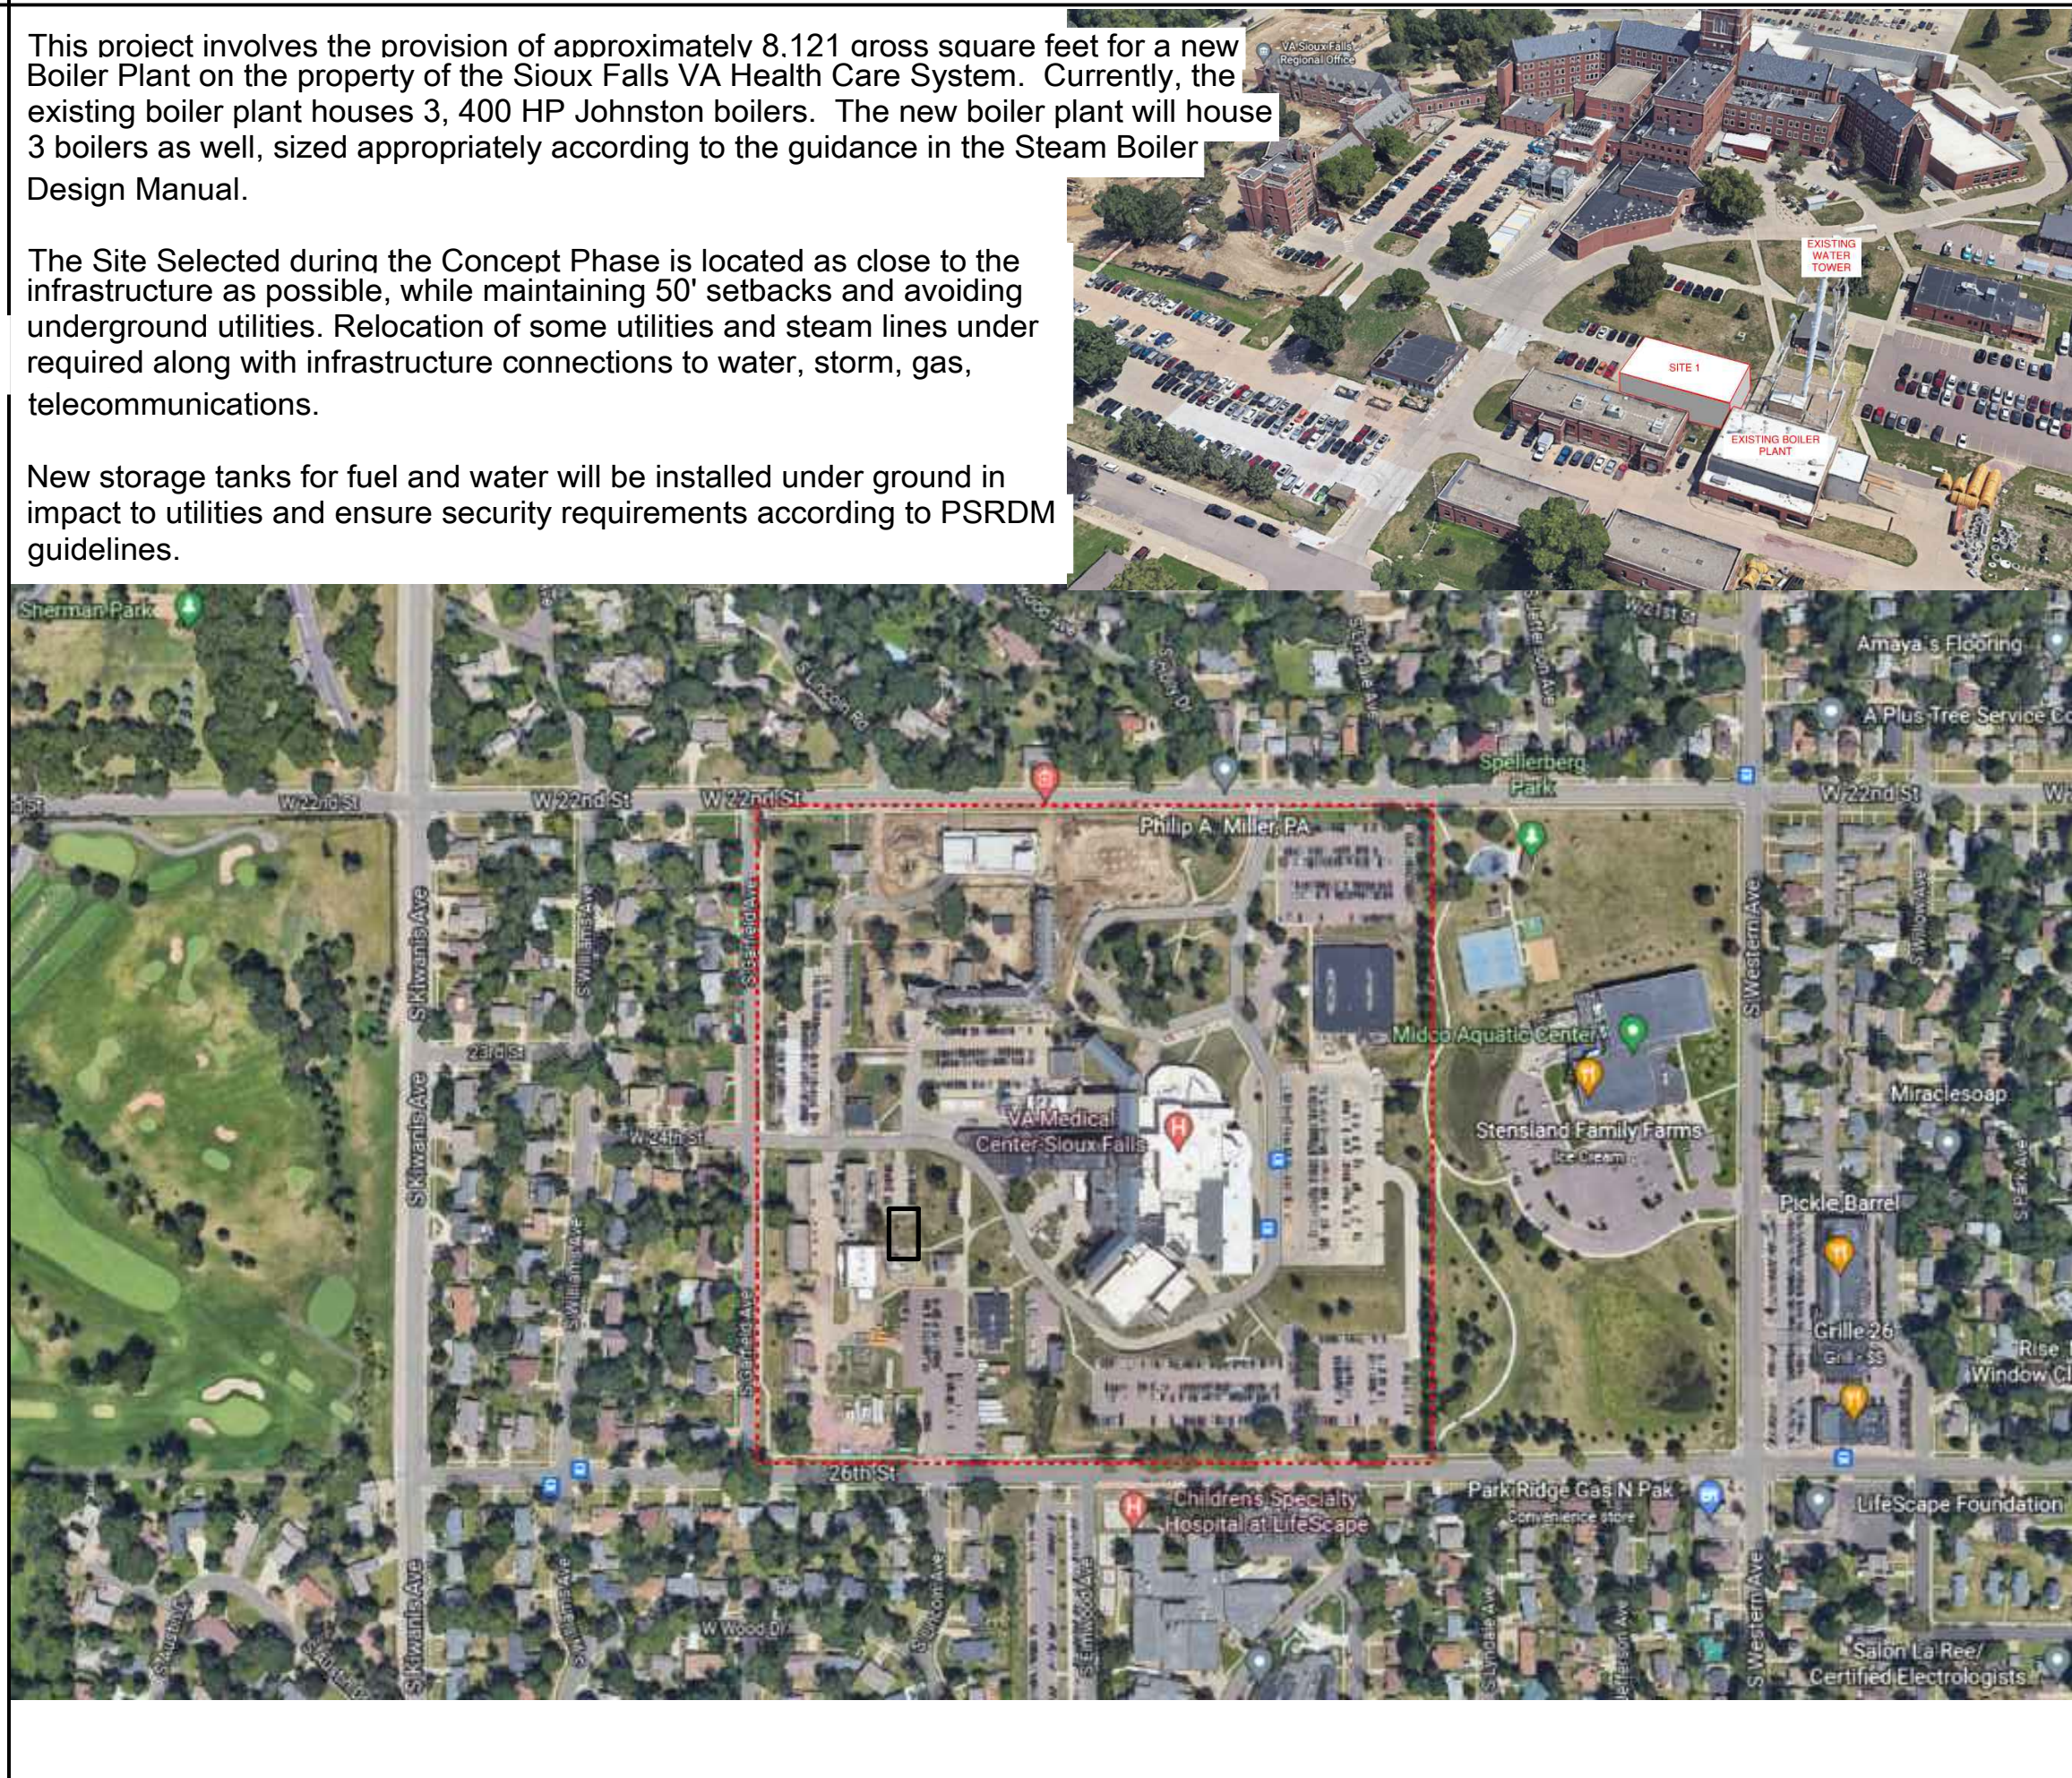
PROJECT TEAM	PROJECT SUMMARY AND VICINITY MAP	SHEET INDEX			
<p>OWNER + COR: Department of Veteran Sioux Falls VA Medical 2501 W 22nd St, Sioux Falls, Isaac Anderson, Isaac.Anderson@va.gov</p> <p>CIVIL: Mabette and Associates, 105 Central St # 4100, Stoneham, Robert B. Blanchette, Jr., PE blanchette@mabbett.com</p> <p>STRUCTURAL: Moon Tree Consulting, 1808 Deep Creek Rd, Oklahoma City, David R. Walton SEOR / Blast david@moontreelc.com</p> <p>ARCHITECTURAL: Paradigm Engineers & 9000 Wessex Pl, Suite 202, Louisville, John Slattery, COO john.slattery@paradigmusa.com</p> <p>FIRE PROTECTION: Paradigm Engineers & 9000 Wessex Pl, Suite 202, Louisville, Rick rick.ingham@paradigmusa.com</p> <p>PLUMBING: Burns & McDonnell 9400 Ward Parkway, Kansas City, Sean sfischbach@burnsmcd.com</p> <p>MECHANICAL: Burns & McDonnell 9400 Ward Parkway, Kansas City, Sean sfischbach@burnsmcd.com</p> <p>ELECTRICAL: Paradigm Engineers & 9000 Wessex Pl, Suite 202, Louisville, Wayne wayne.meyer@paradigmusa.com</p>	<p>This project involves the provision of approximately 8,121 gross square feet for a new Boiler Plant on the property of the Sioux Falls VA Health Care System. Currently, the existing boiler plant houses 3, 400 HP Johnston boilers. The new boiler plant will house 3 boilers as well, sized appropriately according to the guidance in the Steam Boiler Design Manual.</p> <p>The Site Selected during the Concept Phase is located as close to the infrastructure as possible, while maintaining 50' setbacks and avoiding underground utilities. Relocation of some utilities and steam lines under required along with infrastructure connections to water, storm, gas, telecommunications.</p> <p>New storage tanks for fuel and water will be installed under ground in impact to utilities and ensure security requirements according to PSRDM guidelines.</p> 	<p>00 GENERAL G001 COVER SHEET AND INDEX G101 LIFE SAFETY PLANS AND CODE INFORMATION G102 LIFE SAFETY - UL ASSEMBLIES G103 LIFE SAFETY - UL PENETRATIONS G104 PROJECT BOARD SIGN (X1) PLAN & DETAILS G105 PROJECT BOARD SIGN (X2) PLAN & DETAILS G106 PROJECT BOARD SIGN (X3) PLAN & DETAILS G107 PCRA, ICRA, & ISM FORMS G108 PCRA, ICRA, & ISM FORMS G109 PCRA, ICRA, & ISM FORMS</p> <p>02 CIVIL C001 CIVIL LEGEND, ABBREVIATIONS, AND GENERAL NOTES CD101 CIVIL EXISTING CONDITIONS/DEMOLITION PLAN CD102 CIVIL EXISTING CONDITIONS/DEMOLITION PLAN CS101 CIVIL SITE PLAN CS102 CIVIL SITE PLAN CG101 CIVIL GRADING PLAN CG102 CIVIL GRADING PLAN CG103 CIVIL EROSION CONTROL PLAN CG104 CIVIL EROSION CONTROL PLAN CU101 CIVIL UTILITIES PLAN CU102 CIVIL UTILITIES PLAN CU103 CIVIL UTILITIES PLAN-PHASING CU201 CIVIL UTILITY PROFILE CU302 CIVIL UTILITY PROFILE CK501 DETAILS CK502 DETAILS CK503 DETAILS</p> <p>R3 STRUCTURAL SG001 GENERAL STRUCTURAL NOTES SG002 GENERAL STRUCTURAL NOTES SG003 GENERAL STRUCTURAL DETAILS SG004 LIGHT GAGE FRAMING DETAILS SG005 GENERAL STRUCTURAL DETAILS SG006 EQUIPMENT BRACING AND ANCHORAGE DETAILS SB101 FOUNDATION AND SLAB PLANS SF102 MEZZANINE AND CATALK FRAMING PLANS SF103 ROOF FRAMING AND SLAB PLANS SF104 ROOF SLAB REINFORCING DIAGRAM SE201 WALL ELEVATION REINFORCING DIAGRAMS SB301 FOUNDATION DETAILS SB302 FOUNDATION DETAILS SF401 FRAMING DETAILS SF402 FRAMING DETAILS</p>	<p>04 ARCHITECTURAL ELEMENTS AE001 ARCHITECTURAL ABBREVIATIONS, SYMBOLS AND GENERAL NOTES AE101 FIRST FLOOR PLAN - DIMENSION ENLARGED FLOOR PLAN - DIMENSIONS, WALL TYPES AE102 FIRST FLOOR - NOTES, ENLARGED FLOOR PLAN - NOTES AE103 MEZZANINE FLOOR PLAN - NOTES, ENLARGED FLOOR PLAN - NOTES AE104 ROOF PLAN AND DETAILS AE111 REFLECTED CEILING PLAN AND DETAILS AE121 FINISH PLAN, SCHEDULES, AND DETAILS AE200 EXTERIOR ELEVATIONS - OVERALL AE300 BUILDING SECTIONS AE301 WALL SECTIONS & DETAILS AE302 EXTERIOR WALL DETAILS AE400 INTERIOR ELEVATIONS, CASEWORK SCHEDULE AE410 STAIR AND RAILING SECTIONS - DETAILS AE411 STAIR AND RAILING SECTIONS - DETAILS AE500 INTERIOR WALL DETAILS AE600 DOOR, WINDOW, AND FRAME SCHEDULES AND DETAILS A101 LOUVER SCHEDULE A102 FURNITURE PLAN A103 WAYFINDING PLAN A201 WAYFINDING SIGNAGE ELEVATIONS & DETAILS A202 WAYFINDING SIGNAGE ELEVATIONS & DETAILS A203 WAYFINDING SIGNAGE ELEVATIONS & DETAILS</p> <p>07 FIRE PROTECTION FX001 FIRE PROTECTION ABBREVIATIONS, SYMBOLS AND GENERAL NOTES FX101 FIRE PROTECTION FIRST FLOOR FX102 FIRE PROTECTION MEZZANINE FX501 FIRE PROTECTION DETAILS</p> <p>08 PLUMBING P1000 PLUMBING GENERAL NOTES, SYMBOLS, AND ABBREVIATIONS PL101 PLUMBING PLANS PL102 PLUMBING PLANS PL200 PLUMBING PLANS PL201 PLUMBING DISTRIBUTION PIPING PLAN PL300 PLUMBING SECTIONS PL500 PLUMBING DETAILS PL501 PIPING DETAILS PL600 PLUMBING SCHEDULES PL700 WATER FLOW DIAGRAM PL701 PLUMBING WATER RISER DIAGRAM PL702 PLUMBING DOMESTIC WATER RISER DIAGRAM PW703 PLUMBING WASTEVENT RISER DIAGRAM</p>	<p>09 MECHANICAL M-000 MECHANICAL GENERAL NOTES, SYMBOLS, AND ABBREVIATIONS MH101 MECHANICAL HVAC PLANS MH102 MECHANICAL HVAC PLANS-ROOF MH200 MECHANICAL HVAC PLANS MH300 MECHANICAL HVAC SECTIONS MH500 MECHANICAL HVAC DETAILS MH500 HVAC SCHEDULES MT000 MECHANICAL CONTROLS MQ100 MECHANICAL EQUIPMENT PLAN MD101 STEAM DISTRIBUTION DEMOLITION PIPING PLAN MP101 PIPING PLAN FIRST FLOOR MP102 STEAM DISTRIBUTION PIPING PLAN - SOUTH MP103 STEAM DISTRIBUTION PIPING PLAN - NORTH MP104 PIPING SUPPORT PLAN MP105 FUEL OIL DISTRIBUTION PIPING PLAN MP106 PIPING PLAN MEZZANINE FLOOR MP301 PIPING PLAN SECTIONS MP302 PIPING PLAN SECTIONS MP500 PIPING DETAILS MP501 PIPING DETAILS MP502 PIPING DETAILS MP503 PIPING DETAILS MP504 PIPING DETAILS MP505 PIPING DETAILS MP506 PIPING DETAILS MP600 STEAM GENERATION SCHEDULES MP700 STEAM FLOW DIAGRAM MP701 FUEL OIL FLOW DIAGRAM MP702 CAMPUS STEAM AND CONDENSATE DISTRIBUTION SCHEMATIC</p>	<p>10 ELECTRICAL (CONTINUED) EL503 LOW VOLTAGE LIGHTING DIAGRAM & DETAILS EL504 FIRST FLOOR LIGHTING CALCULATION EL505 FIRST FLOOR EGRESS LIGHTING CALCULATION EL506 MEZZANINE LIGHTING CALCULATION EL507 MEZZANINE EGRESS LIGHTING CALCULATION EL508 PARKING LOT LIGHTING CALCULATION EM101 MOTOR AND EQUIPMENT PLAN FIRST FLOOR EM102 ELECTRICAL POWER AND EQUIPMENT PLAN - MEZZANINE EM501 MOTOR AND EQUIPMENT SCHEDULE EM502 MOTOR AND EQUIPMENT SCHEDULE EP101 ELECTRICAL POWER PLAN FIRST FLOOR EP102 ENLARGED ELECTRICAL ROOM PLANS EP103 ELECTRICAL POWER PLAN MEZZANINE EP501 NORMAL POWER ONE-LINE DIAGRAM EP502 NORMAL POWER (STANDBY POWER ONE-LINE DIAGRAM EP503 NORMAL POWER ONE-LINE DIAGRAM EP504 POWER CUT SHEET INFORMATION AND ELECTRICAL SCHEDULES EP601 PANEL SCHEDULES EP602 PANEL SCHEDULES EP603 PANEL SCHEDULES EP604 PANEL SCHEDULES ES101 ELECTRICAL SITE PLAN ES102 BUILDING 11 - FIRST FLOOR ES103 BUILDING 5 GROUND FLOOR LOOP "A" & "B" ES104 BUILDING 5 FIRST FLOOR LOOP "A" & "B" EST05 NEW TUNNEL PLAN EST106 ELECTRICAL SECURITY GATE PLAN ET101 TELECOMMUNICATIONS PLAN FIRST FLOOR ET501 TELECOMMUNICATIONS DETAILS ET502 TELECOMMUNICATIONS DETAILS EY101 ELECTRICAL SYSTEMS PLAN FIRST FLOOR EY501 SYSTEM DETAILS FA001 FIRE ALARM LEGEND, GENERAL NOTES AND ABBREVIATIONS FA101 FIRE ALARM PLAN FIRST FLOOR FA102 FIRE ALARM PLAN MEZZANINE FA501 FIRE ALARM DETAILS FA502 FIRE ALARM DETAILS</p>

ADDENDUM 1	08-09-2024
ADDENDUM 2	09-12-2024

CONSULTANT

ARCHITECT/ENGINEER OF RECORD

paradigm
Architecture | Engineering | Design-Build
9000 Wessex Place, Louisville, KY 40222
www.paradigmusa.com

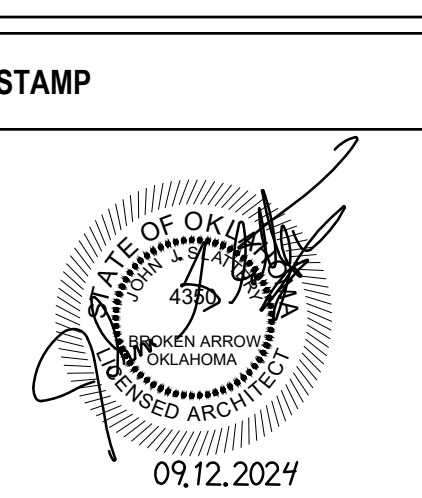

Office of Construction and Facilities Management

VA U.S. Department of Veterans Affairs

Drawing Title: COVER SHEET AND INDEX

Phase: 100% CONSTRUCTION DOCUMENTS

Project Title: SIOUX FALLS BOILER PLANT

Project Number: 438-22-900

Building Number: 12

Drawing Number: G1001

Location: VAMC-Sioux Falls: 2501 W 22nd St, Sioux Falls, SD 57105

Issue Date: 09-12-2024

Checked: MRP

Drawn: EB

Location: VAMC-Sioux Falls: 2501 W 22nd St, Sioux Falls, SD 57105

Issue Date: 09-12-2024

Checked: MRP

Drawn: EB

Project Number: 438-22-900

Building Number: 12

Drawing Number: G1001

CODE COMPLIANCE SUMMARY

GENERAL PROJECT INFORMATION

PROJECT LOCATION: VAMC-Sioux Falls: 2501 W 22nd St, Sioux Falls, SD 57105
 BUILDING CODE: NFPA 101 2022 edition - NFC (National Fire Code) 2022 edition, IBC 2021, NFPA 10 Fire Extinguishers 2022 edition, NFPA 58 2022 Liquefied Petroleum gas code, NFPA 220 2022 edition

PROJECT TYPE: NEW CONSTRUCTION
 FIRE PROTECTION: FULLY SPRINKLERED - ORDINARY HAZARD 2

USE AND OCCUPANCY CLASSIFICATION
 The following non-separated mixed

CLASSIFICATION	DESCRIPTION	LEVEL
F-1 (INDUSTRIAL)	STEAM BOILER	FIRST FLOOR
S-2 (STORAGE)	STORAGE	MEZZANINE
B (BUSINESS)	OFFICE	FIRST FLOOR

NFC (NFPA) CHAPTER 6.1 CLASSIFICATION OF OCCUPANCY
 NFPA-101 40.1.2.1.1 Special Industrial Occupancies

- Buildings and structures designed to house special industrial processes that require large areas and unusual building heights to accommodate cranes or special machinery and equipment, including, among others, rolling mills; structural metal fabrication shops and foundries; or the production and distribution of electric, gas or steam power, shall be exempt from the building height, number of stories and building area limitations specified in sections 504 and 506.

IBC BUILDING HEIGHTS, STORIES AND AREA LIMITATION-F-1	S-2
TABLE 504.3 - Allowable Building Height	75
TABLE 504.4 - Allowable Building Stories	4
TABLE 506.2 - Allowable Building Area (SF)	48,000
TABLE 506.3.3 - Frontage Increase Factor (0.75) - total area:	84,000
	182,000

BUILDING AREA = 8,155.21 SF; MEZZANINE AREA = 2,420.59 SF

IBC MEZZANINES - 505.2.1 AREA
 Type I or II construction for special industrial of the floor area of the room.
 505.1.1 shall be not greater than two-thirds
 The aggregate area of mezzanines in buildings and structures of

NFPA 220 TYPE II 000

FIRE-RESISTANCE RATING REQUIREMENTS FOR BUILDING ELEMENTS

Element	RATING
Primary structural frame	0
Bearing walls - Exterior	0
Interior	0
Nonbearing walls & partitions - Exterior	0
Nonbearing walls & partitions - Interior	0
Floor construction & associated secondary	0
Roof construction & associated secondary members	0
Corridors (1020)	0
Stairs (1023.2 - Mezzanines)	0
Elevator shafts & other shafts (713.4 - Mezzanines)	n/a

NFPA 101 CHAPTER 7 MEANS OF EGRESS SIZING

STAIRWAYS
 NFPA 101 Table 7.3.3.1 Capacity factor of 0.3 for stairs.
OTHER EGRESS COMPONENTS
 NFPA 101 Table 7.3.3.1 capacity factor of 0.2 for Level Components.
 NFPA 101 TABLE 40.2.3.1 ARRANGEMENT OF MEANS OF EGRESS
 DEAD END CORRIDOR 50'
 COMMON PATH OF TRAVEL 100'
 MAXIMUM TRAVEL DISTANCE TO EXIT 300'
 Unoccupied mechanical rooms and penthouses are not required to comply
STAIRWAY TO ROOF
 Exception: An un-occupied roof is allowed a permanent ladder, ship's ladder, or

OCCUPANCY LOAD FACTOR

NFC (NFPA1) TABLE 14.8.1.2
 Assembly Use without fixed seating 15 net
 Business 150
 Collaboration rooms 30
 Industrial Use General & high hazard 100
 Special purpose industrial Maximum Probable

Egress Capacity
 Level components and ramps = 2" per person
 Stairways = 3" per person

Total Occupants - 1st Level = 67; Mezzanine = 5
 Total exits required - 2; exits provided = 8
 Total egress width required = 14.48 inches
 Total egress width provided = 336 inches
 Total stair width required = 9" inches
 Total stair width provided = 76 inches
 Minimum door width = 32 inches

NOTE: FIRE EXTINGUISHERS SHALL COMPLY WITH NFPA 10 TABLE 6.3.1.1 FOR CLASS B EXTRA HAZARD REQUIREMENTS.

LIFE SAFETY SYMBOLS WALLS

- SMOKE TIGHT BARRIER
- 30 MINUTE FIRE-RATED/SMOKE BARRIER
- 1 HOUR FIRE-RATED/SMOKE BARRIER
- 2 HOUR FIRE-RATED/SMOKE BARRIER
- 1 HOUR FIRE-RATED/SMOKE BARRIER
- 1 HOUR FIRE-RATED
- 2 HOUR FIRE-RATED
- 3-HOUR FIRE-RATED

- DOORS**
- 20 MINUTE FIRE RATED, SMOKE RESISTANT
 - 45 MINUTE FIRE RATED
 - 60 MINUTE FIRE RATED
 - 90 MINUTE FIRE RATED

MEANS OF EGRESS

- EMERGENCY LIGHT, BATTERY-POWERED
- ILLUMINATED EXIT SIGN, SINGLE FACE
- ILLUMINATED EXIT SIGN, DOUBLE FACE
- EMERGENCY LIGHT, EMERGENCY POWER CIRCUIT

UTILITIES & MEDICAL GAS CONTROLS

- ELECTRIC SHUTOFF
- DOMESTIC WATER
- NATURAL GAS
- OXYGEN SHUTOFF
- MEDICAL AIR SHUTOFF
- VACUUM SHUTOFF
- SPRINKLER SHUTOFF

FIRE ALARMS, DEVICES AND RELATED EQUIPMENT

- FIRE ALARM, PULL STATION
- FIRE ALARM, HORN WITH STROBE
- FIRE ALARM, STROBE
- SMOKE DETECTOR
- FIRE EXTINGUISHERS & FIRE FIGHTING
- DRY CHEMICAL EXTINGUISHER, BC TYPE
- DRY CHEMICAL EXTINGUISHER, ABC TYPE
- CO2 EXTINGUISHER
- HALON OR CLEAN AGENT EXTINGUISHER
- HOSE STATION, DRY STANDPIPE

CONTROL PANELS

- FIRE ALARM CONTROL PANEL
- FIRE SYSTEM ANNUNCIATOR
- HVAC

SUPPLEMENTARY SYMBOLS

- FULLY SPRINKLERED SPACE
- PARTIALLY SPRINKLERED SPACE
- NONSPRINKLERED SPACE
- SECURITY CARD READER
- SUITE BOUNDARY LINE
- SUITE AREA AND OCCUPANT LOAD
- SMOKE COMPARTMENT AND OCCUPANT LOAD
- 2 HOUR CEILING ASSEMBLY UL N708 FOR COLUMNS LOCATED WITH-IN THIS DESIGNATED SPACE COLUMN ASSEMBLY UL X790

FOR COLUMNS LOCATED WITH-IN THIS DESIGNATED SPACE

SUITE AREA AND OCCUPANT LOAD

SMOKE COMPARTMENT AND OCCUPANT LOAD

2 HOUR CEILING ASSEMBLY UL N708 FOR COLUMNS LOCATED WITH-IN THIS DESIGNATED SPACE COLUMN ASSEMBLY UL X790

OCCUPANT CONTRIBUTION TO EXIT FLOW

SIM OPERATIONS

CELLS MOUNTED EXIT SIGN (DASHED AREA INDICATES FACETS) PROVIDE SECTIONAL ARROWS AS REQUIRED (OR PLANS)


EGRESS WITH (INCHES)

WITH PROVIDED


WITH REQUIRED (OCCUPANT LOAD > 27 PERSONS)

LIFE SAFETY SYMBOLS

NO SCALE

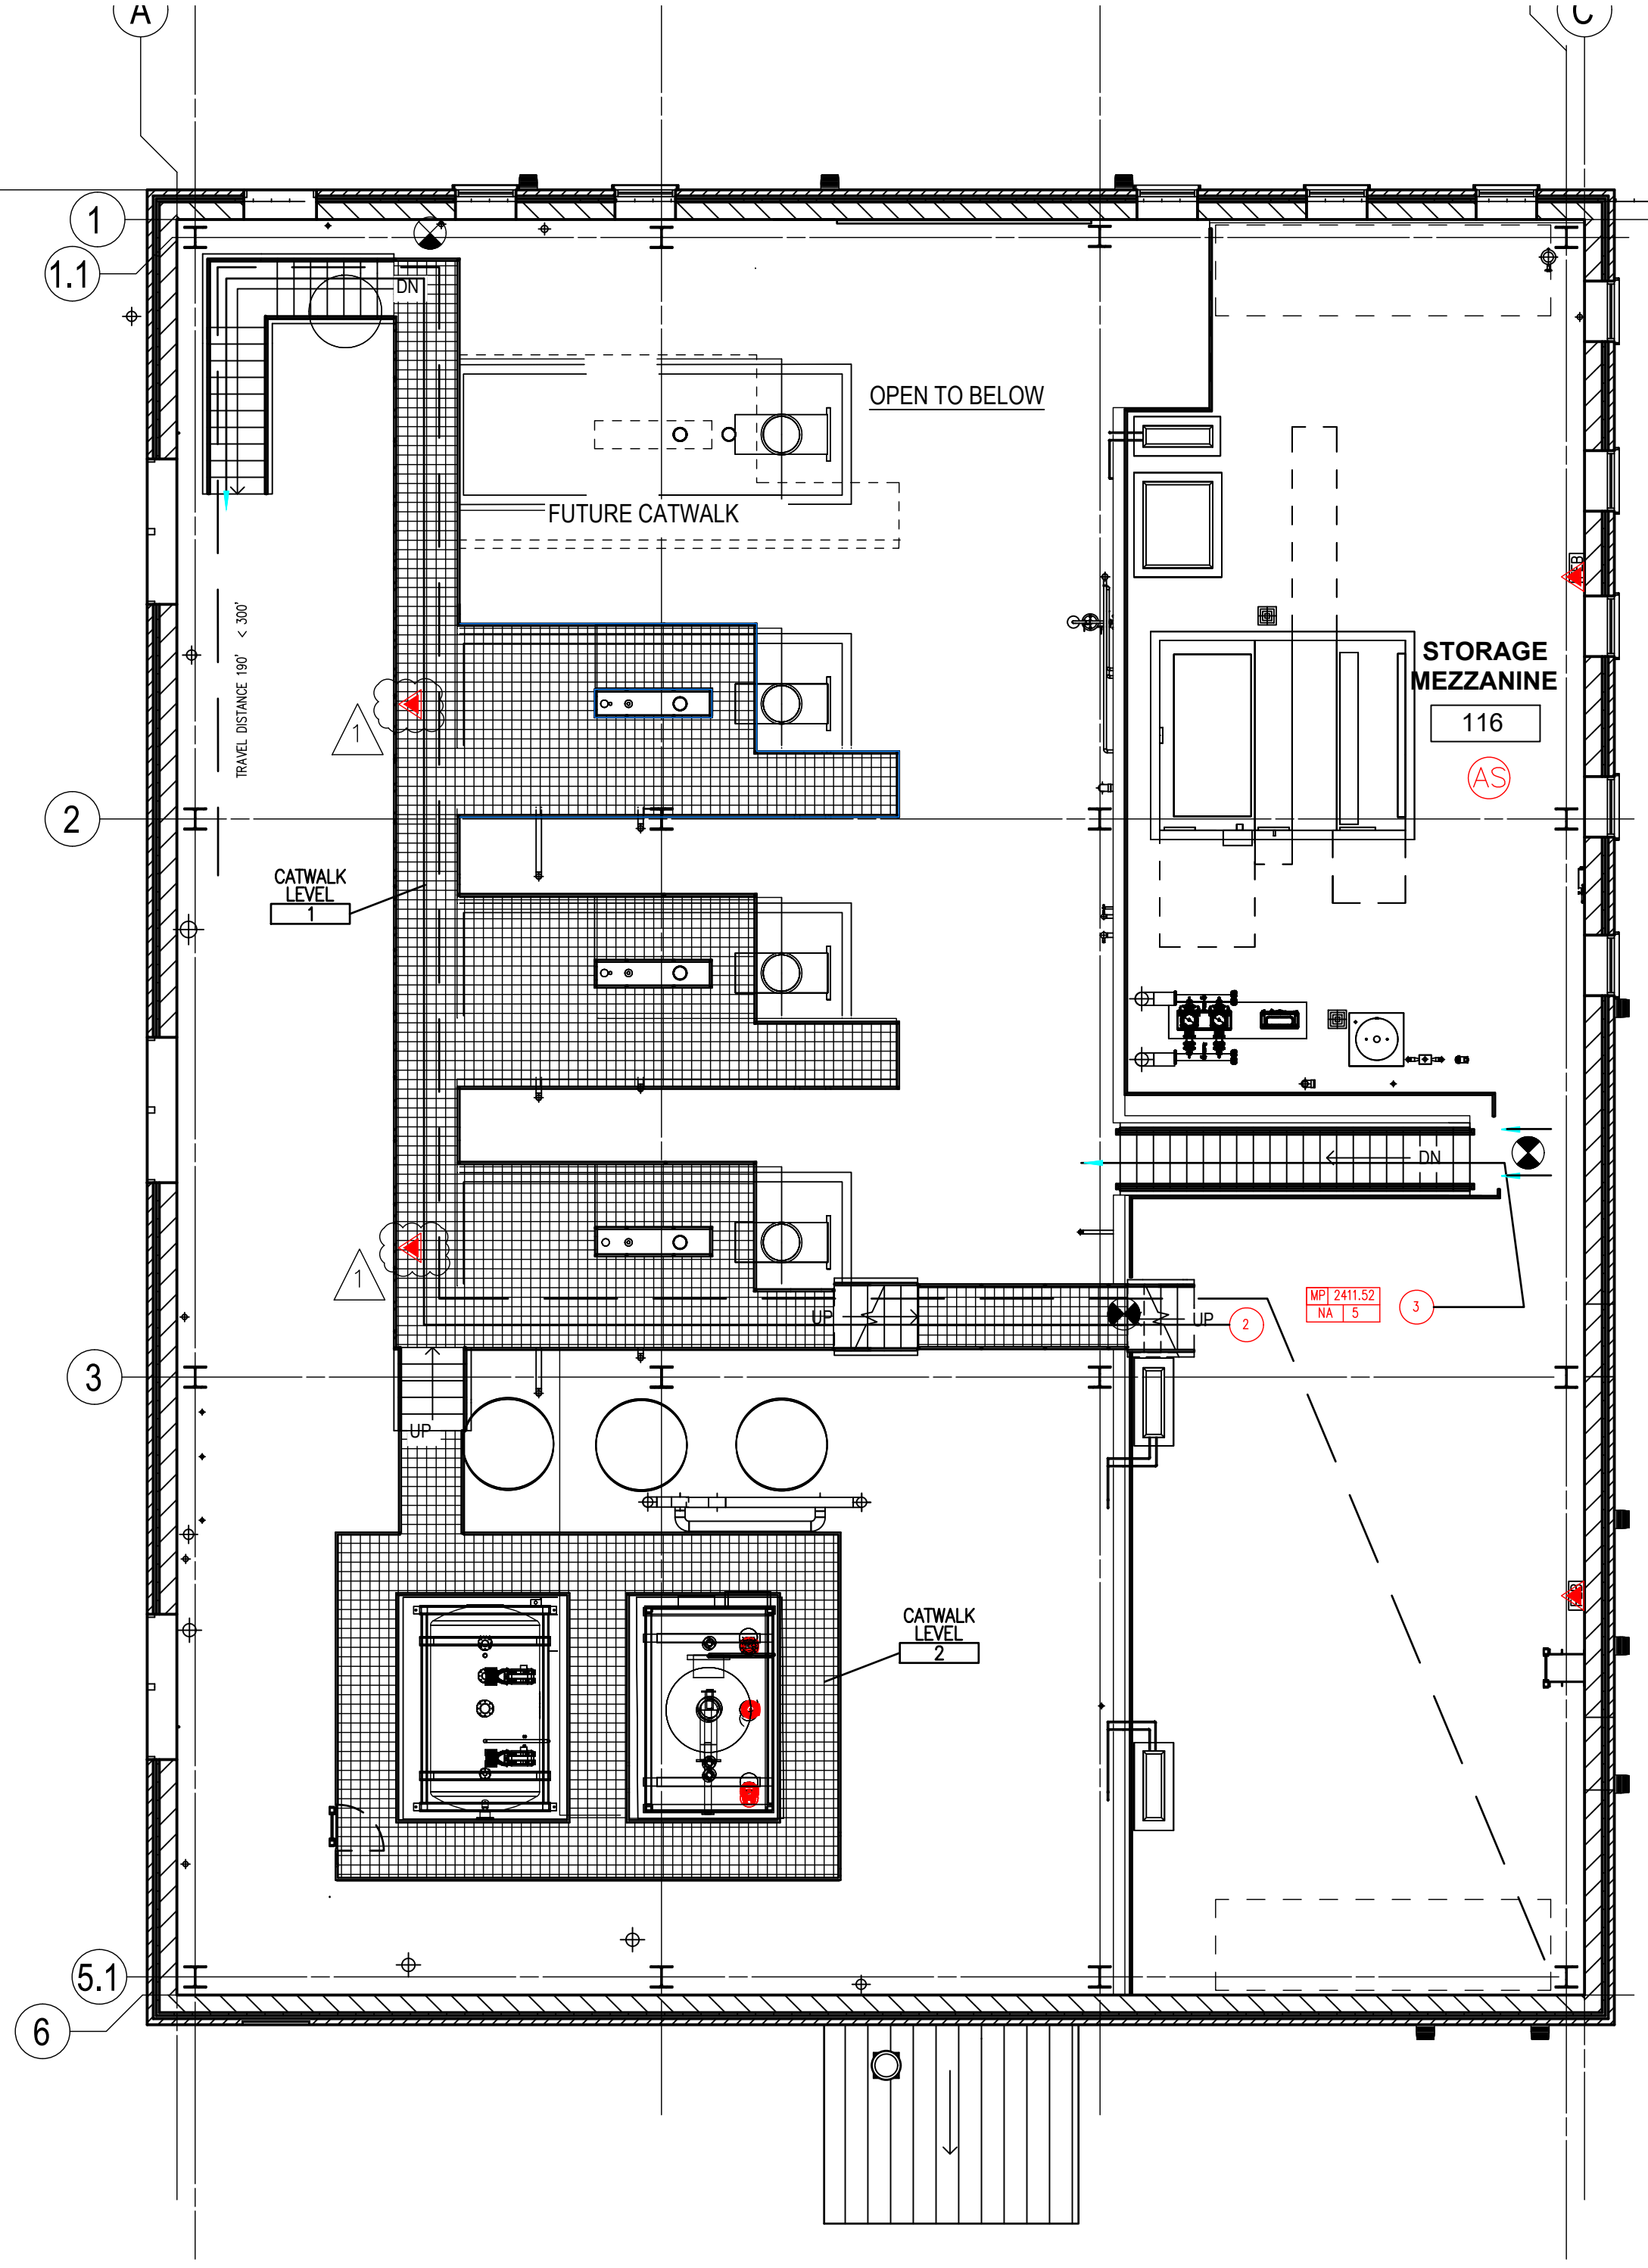


F1 CATWALK LEVEL 1 & 2 PLAN - LIFE SAFETY
 FLOOR AREA: 8,155.21 GSF
 Scale: 1/8" = 1'-0"
 TRUE PLAN

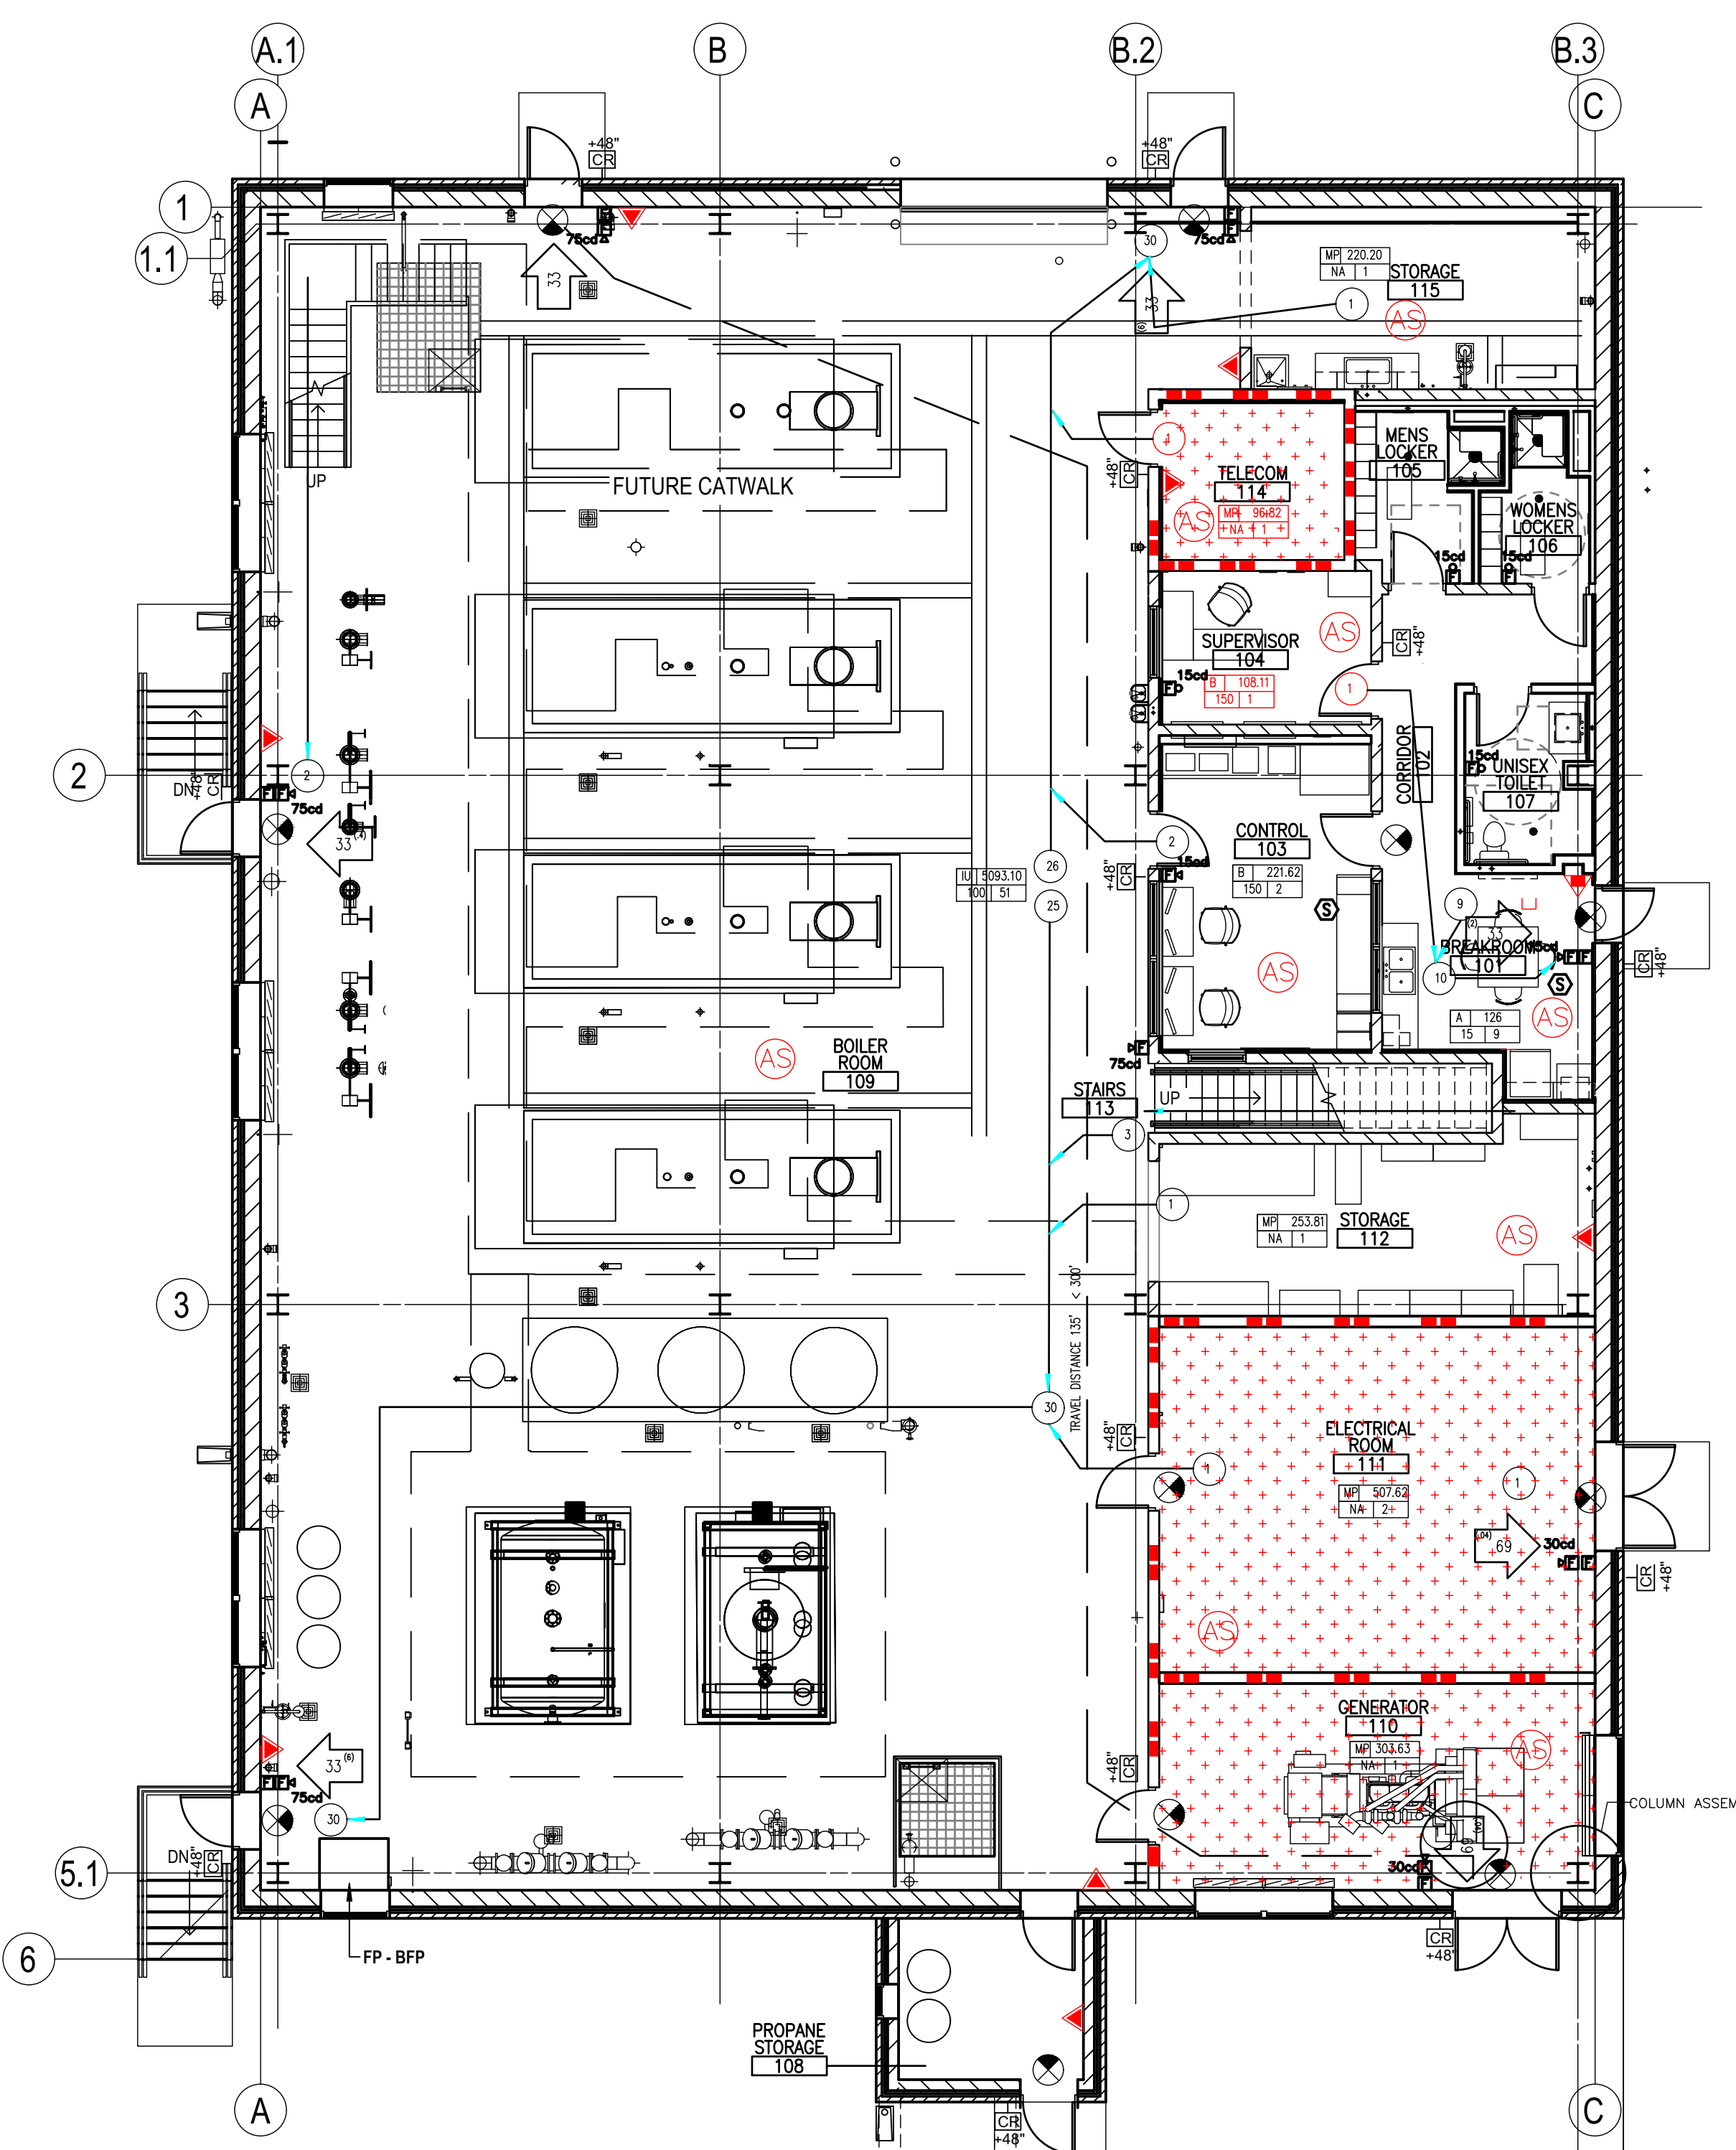

F5 FIRST FLOOR PLAN - LIFE SAFETY
 MEZZANINE FLOOR AREA: 2,420.59 GSF
 Scale: 1/8" = 1'-0"
 TRUE PLAN

F9 LIFE SAFETY SYMBOLS
 NO SCALE

<table border="1"> <tr> <td>ADDENDUM 1</td> <td>08-09-2024</td> </tr> <tr> <td>ADDENDUM 2</td> <td>09-12-2024</td> </tr> </table>	ADDENDUM 1	08-09-2024	ADDENDUM 2	09-12-2024	CONSULTANT	ARCHITECT/ENGINEER OF RECORD	STAMP	Office of Construction and Facilities Management	Drawing Title LIFE SAFETY PLANS AND CODE INFORMATION	Phase 100% CONSTRUCTION DOCUMENTS	Project Title SIOUX FALLS BOILER PLANT	Project Number 438-22-900
ADDENDUM 1	08-09-2024											
ADDENDUM 2	09-12-2024											
		 Architecture Engineering Design-Build 9000 Westexx Place, Louisville, KY 40222 www.paradigmusa.com		VA U.S. Department of Veterans Affairs	Approved: Project Director	FULLY SPRINKLERED	Location VAMC-Sioux Falls: 2501 W 22nd St, Sioux Falls, SD 57105	Building Number 12				
							Issue Date 09-12-2024	Checked EB				
							Drawn EB	Drawing Number G1101				

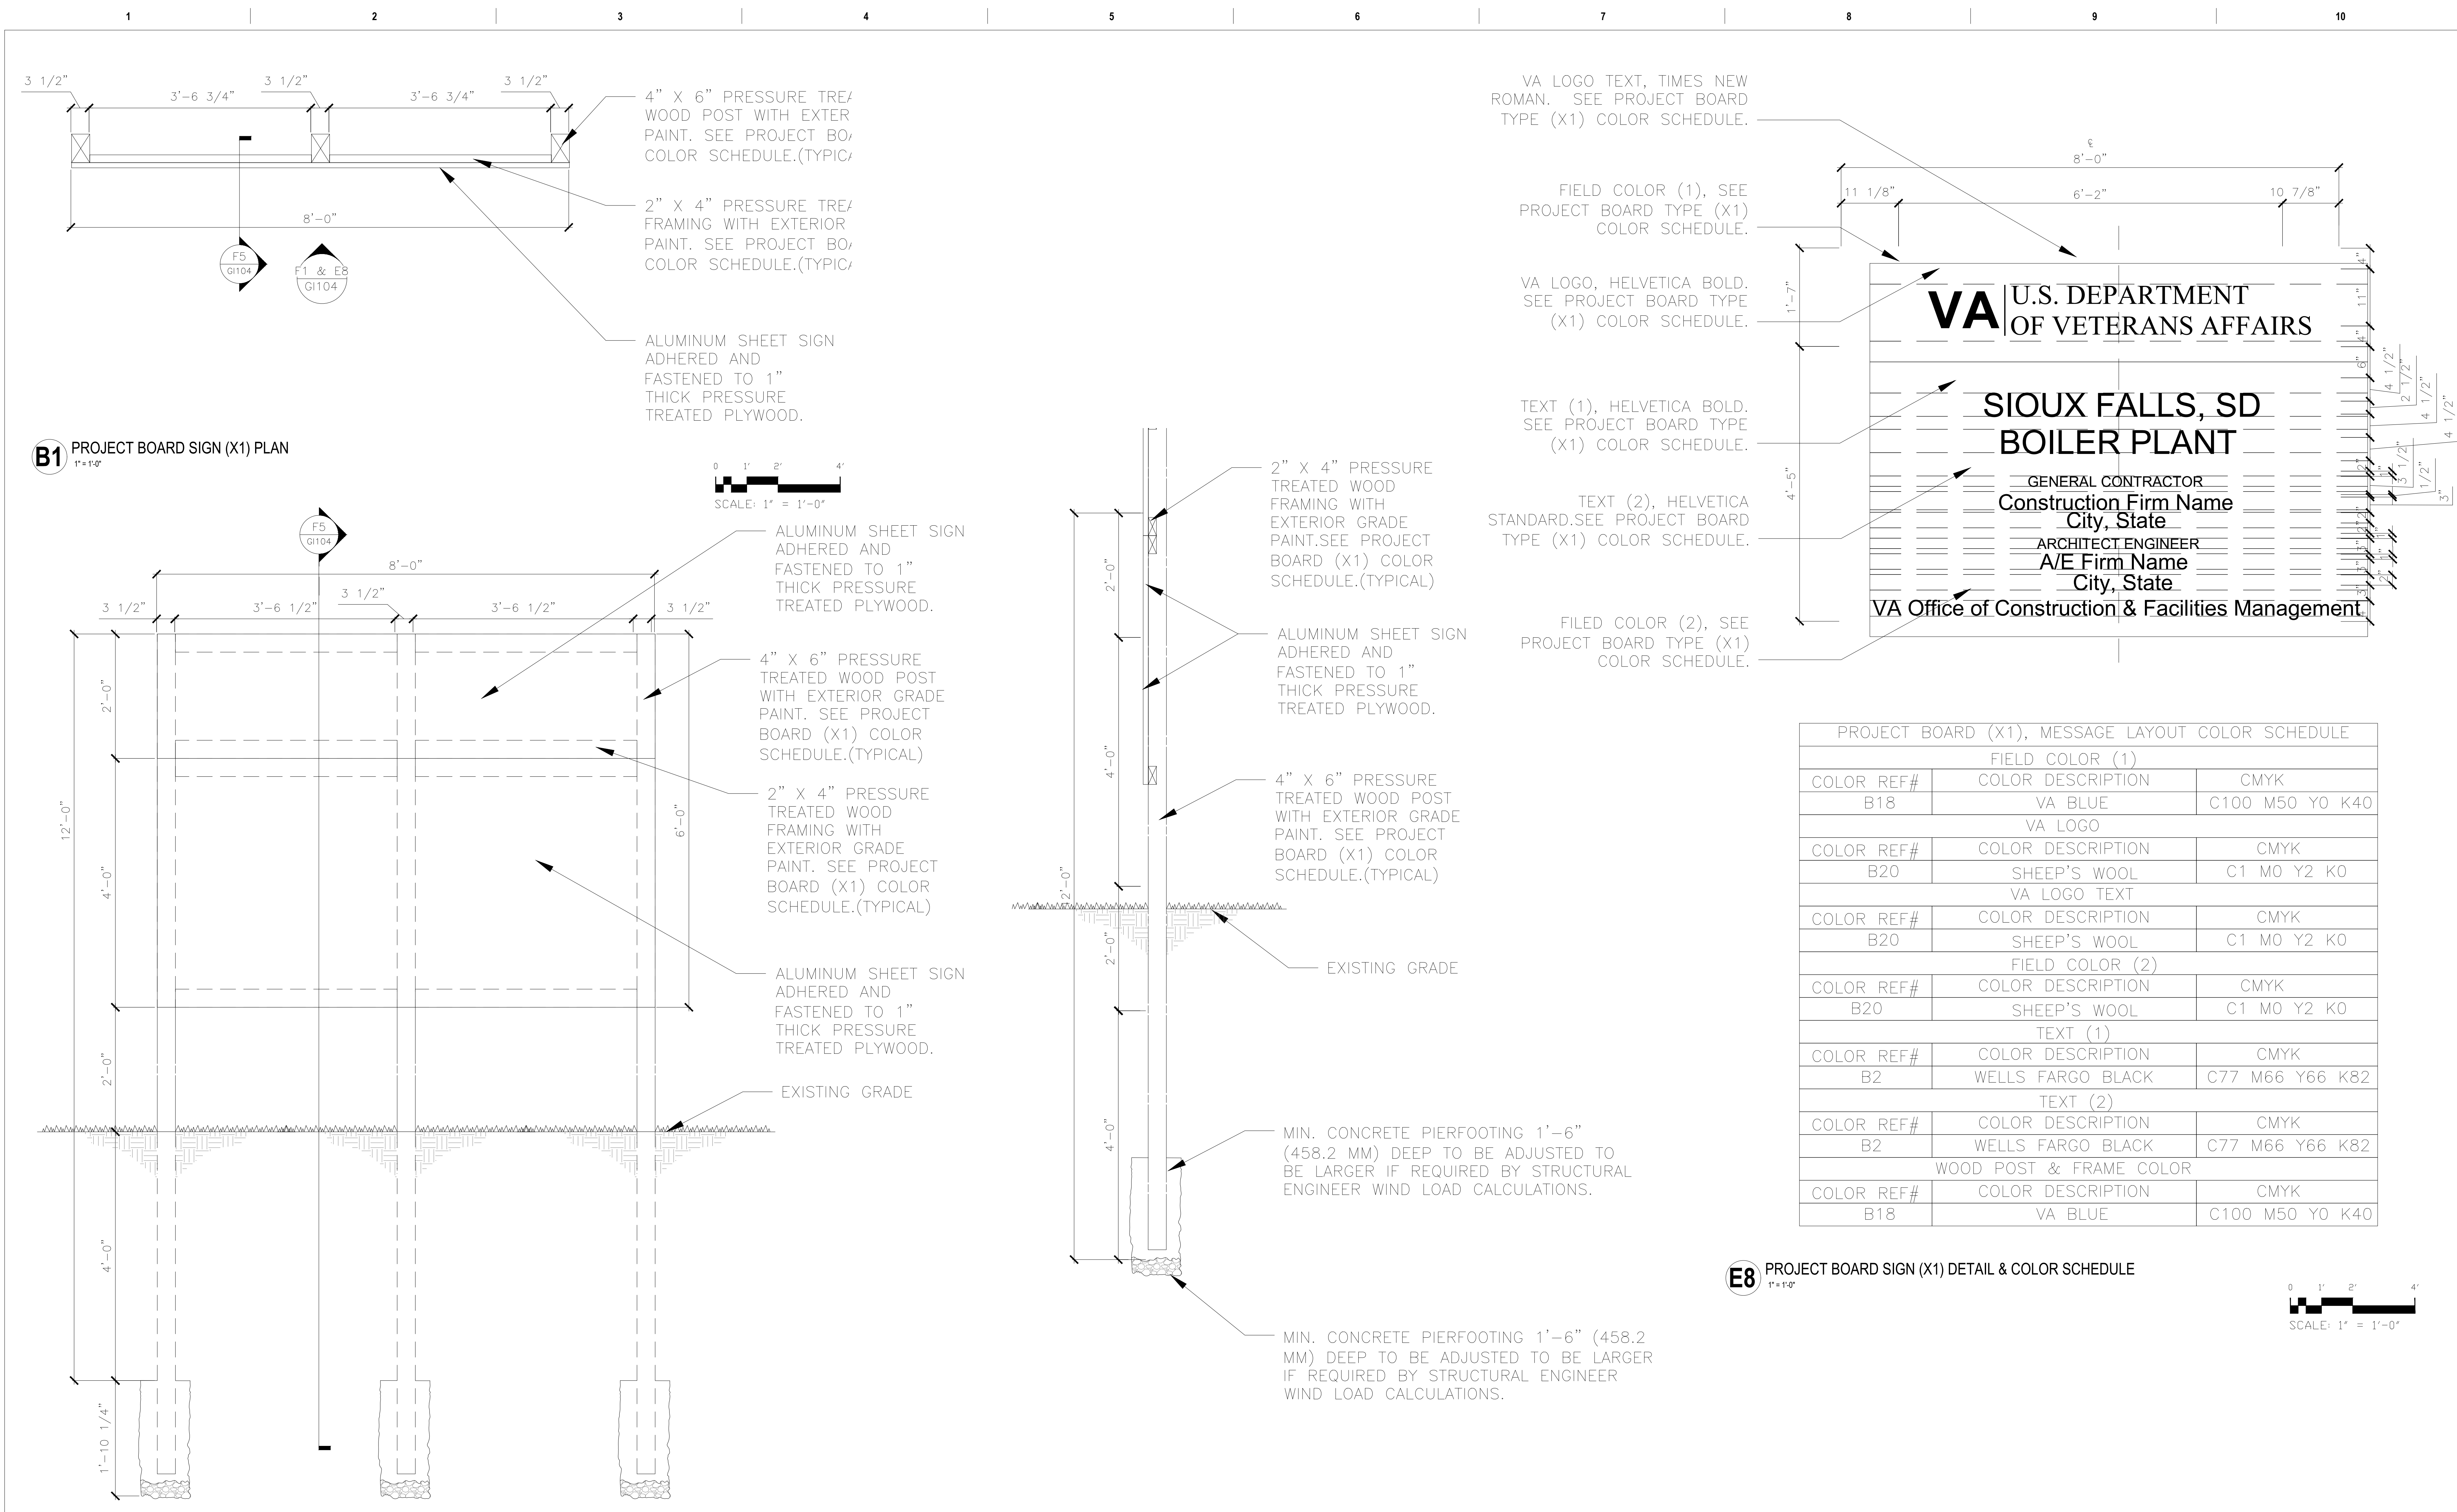

VA LOGO TEXT, TIMES NEW ROMAN. SEE PROJECT BOARD TYPE (X1) COLOR SCHEDULE.

FIELD COLOR (1), SEE PROJECT BOARD TYPE (X1) COLOR SCHEDULE.

VA LOGO, HELVETICA BOLD. SEE PROJECT BOARD TYPE (X1) COLOR SCHEDULE.

TEXT (1), HELVETICA BOLD. SEE PROJECT BOARD TYPE (X1) COLOR SCHEDULE.

TEXT (2), HELVETICA STANDARD. SEE PROJECT BOARD TYPE (X1) COLOR SCHEDULE.

FIELD COLOR (2), SEE PROJECT BOARD TYPE (X1) COLOR SCHEDULE.

PROJECT BOARD (X1), MESSAGE LAYOUT COLOR SCHEDULE

FIELD COLOR (1)		
COLOR REF#	COLOR DESCRIPTION	CMYK
B18	VA BLUE	C100 M50 Y0 K40
VA LOGO		
COLOR REF#	COLOR DESCRIPTION	CMYK
B20	SHEEP'S WOOL	C1 M0 Y2 K0
VA LOGO TEXT		
COLOR REF#	COLOR DESCRIPTION	CMYK
B20	SHEEP'S WOOL	C1 M0 Y2 K0
FIELD COLOR (2)		
COLOR REF#	COLOR DESCRIPTION	CMYK
B20	SHEEP'S WOOL	C1 M0 Y2 K0
TEXT (1)		
COLOR REF#	COLOR DESCRIPTION	CMYK
B2	WELLS FARGO BLACK	C77 M66 Y66 K82
TEXT (2)		
COLOR REF#	COLOR DESCRIPTION	CMYK
B2	WELLS FARGO BLACK	C77 M66 Y66 K82
WOOD POST & FRAME COLOR		
COLOR REF#	COLOR DESCRIPTION	CMYK
B18	VA BLUE	C100 M50 Y0 K40


B1 PROJECT BOARD SIGN (X1) PLAN
1" = 1'-0"

F1 PROJECT BOARD SIGN (X1) PLAN
1" = 1'-0"


F5 PROJECT BOARD SIGN (X1) SECTION
1" = 1'-0"

E8 PROJECT BOARD SIGN (X1) DETAIL & COLOR SCHEDULE
1" = 1'-0"


		CONSULTANT	ARCHITECT/ENGINEER OF RECORD	STAMP	Office of Construction and Facilities Management	Drawing Title PROJECT BOARD SIGN (X1) PLAN & DETAILS	Phase 100% CONSTRUCTION DOCUMENTS	Project Title SIOUX FALLS BOILER PLANT	Project Number 438-22-900
						Approved: Project Director		Location VAMC-Sioux Falls: 2501 W 22nd St, Sioux Falls, SD 57105	Building Number 12
			9000 Wesley Place, Louisville, KY 40222 www.paradigmusa.com	09.12.2024	U.S. Department of Veterans Affairs			Issue Date 09-12-2024	Checked EB
								Checked	Drawing Number G1104

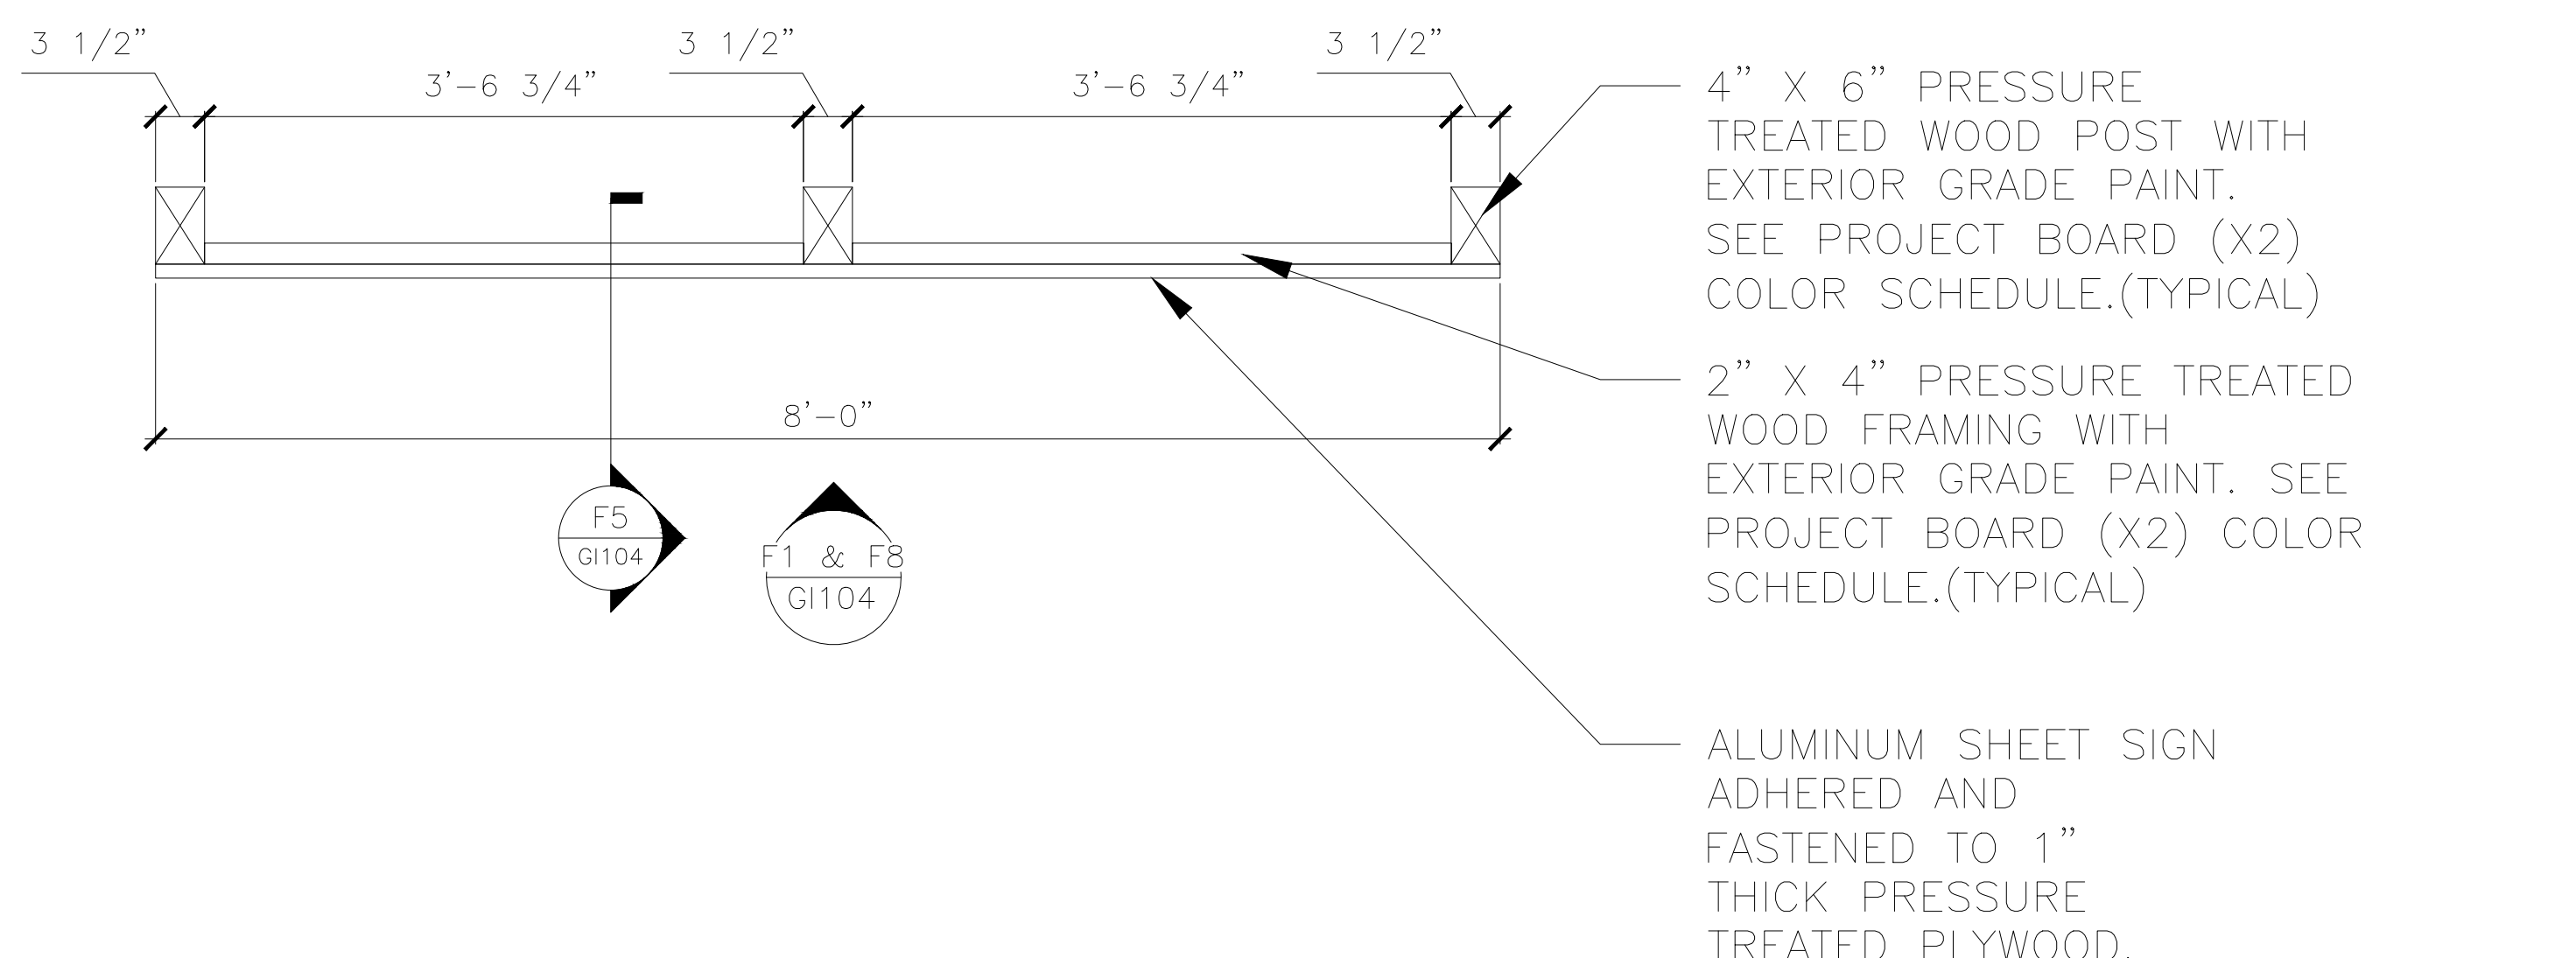


B1 PROJECT BOARD SIGN (X2) PLAN
1" = 1'-0"

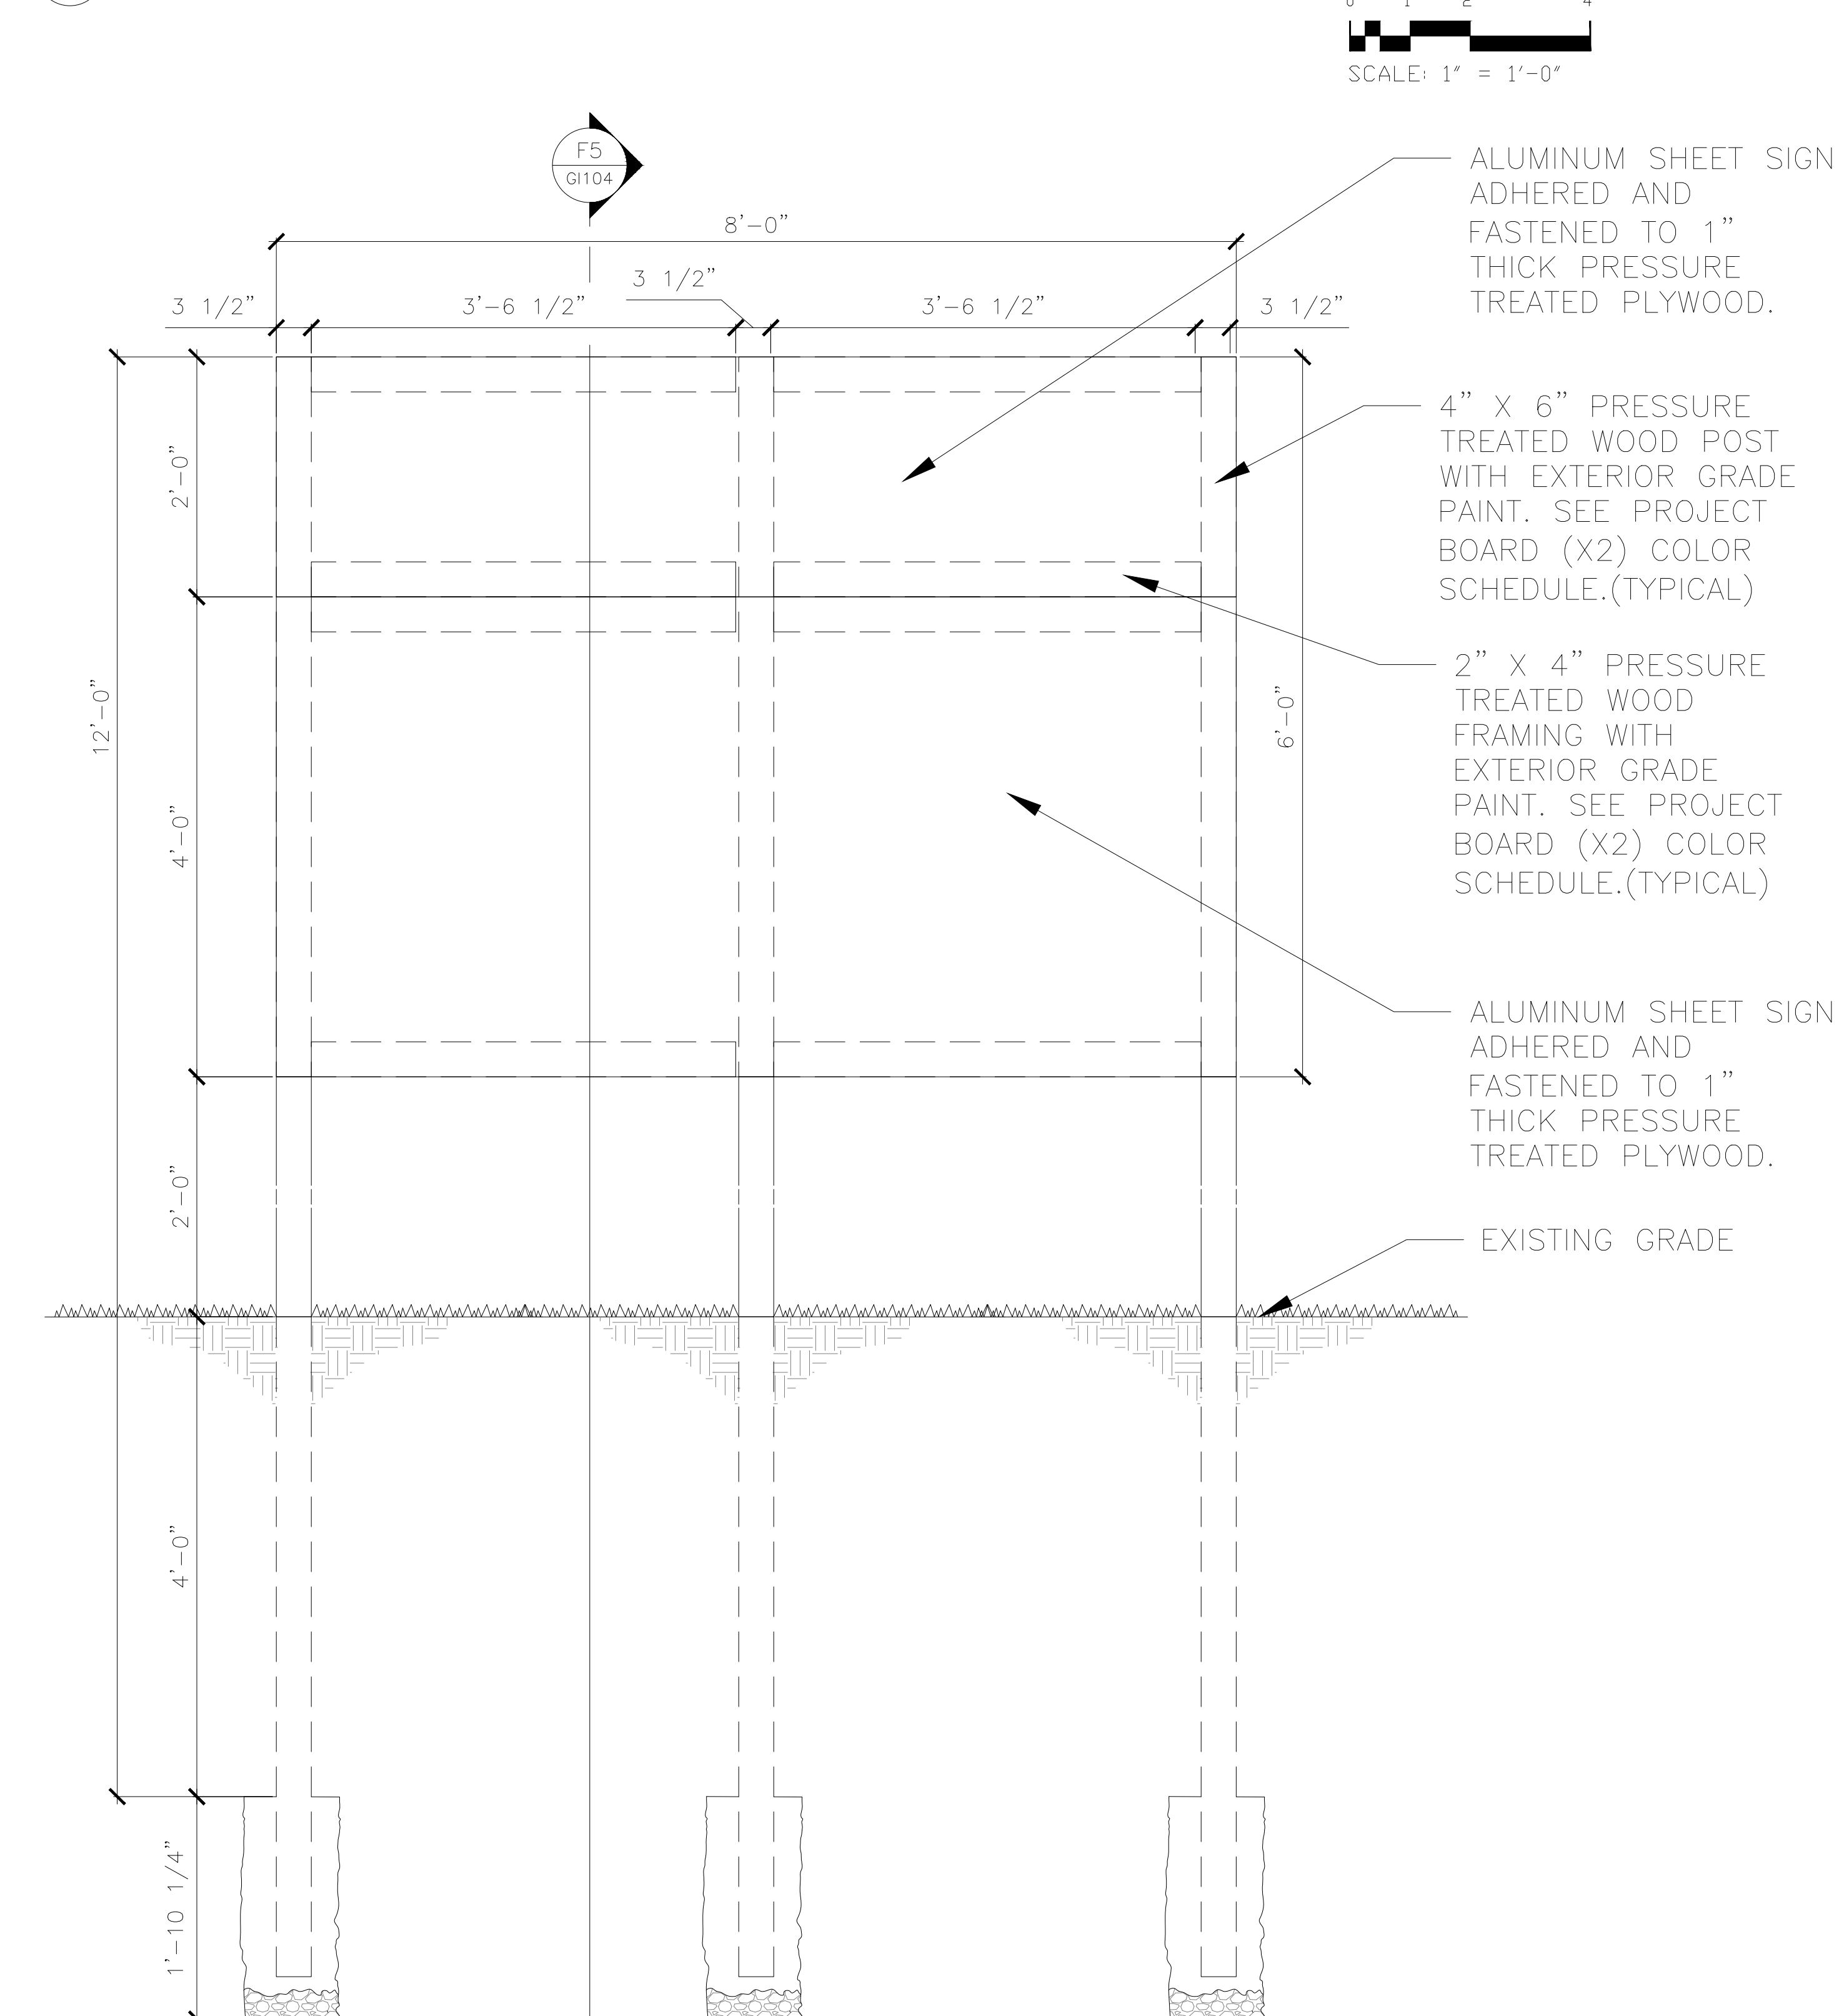

F1 PROJECT BOARD SIGN (X2) ELEVATION
1" = 1'-0"

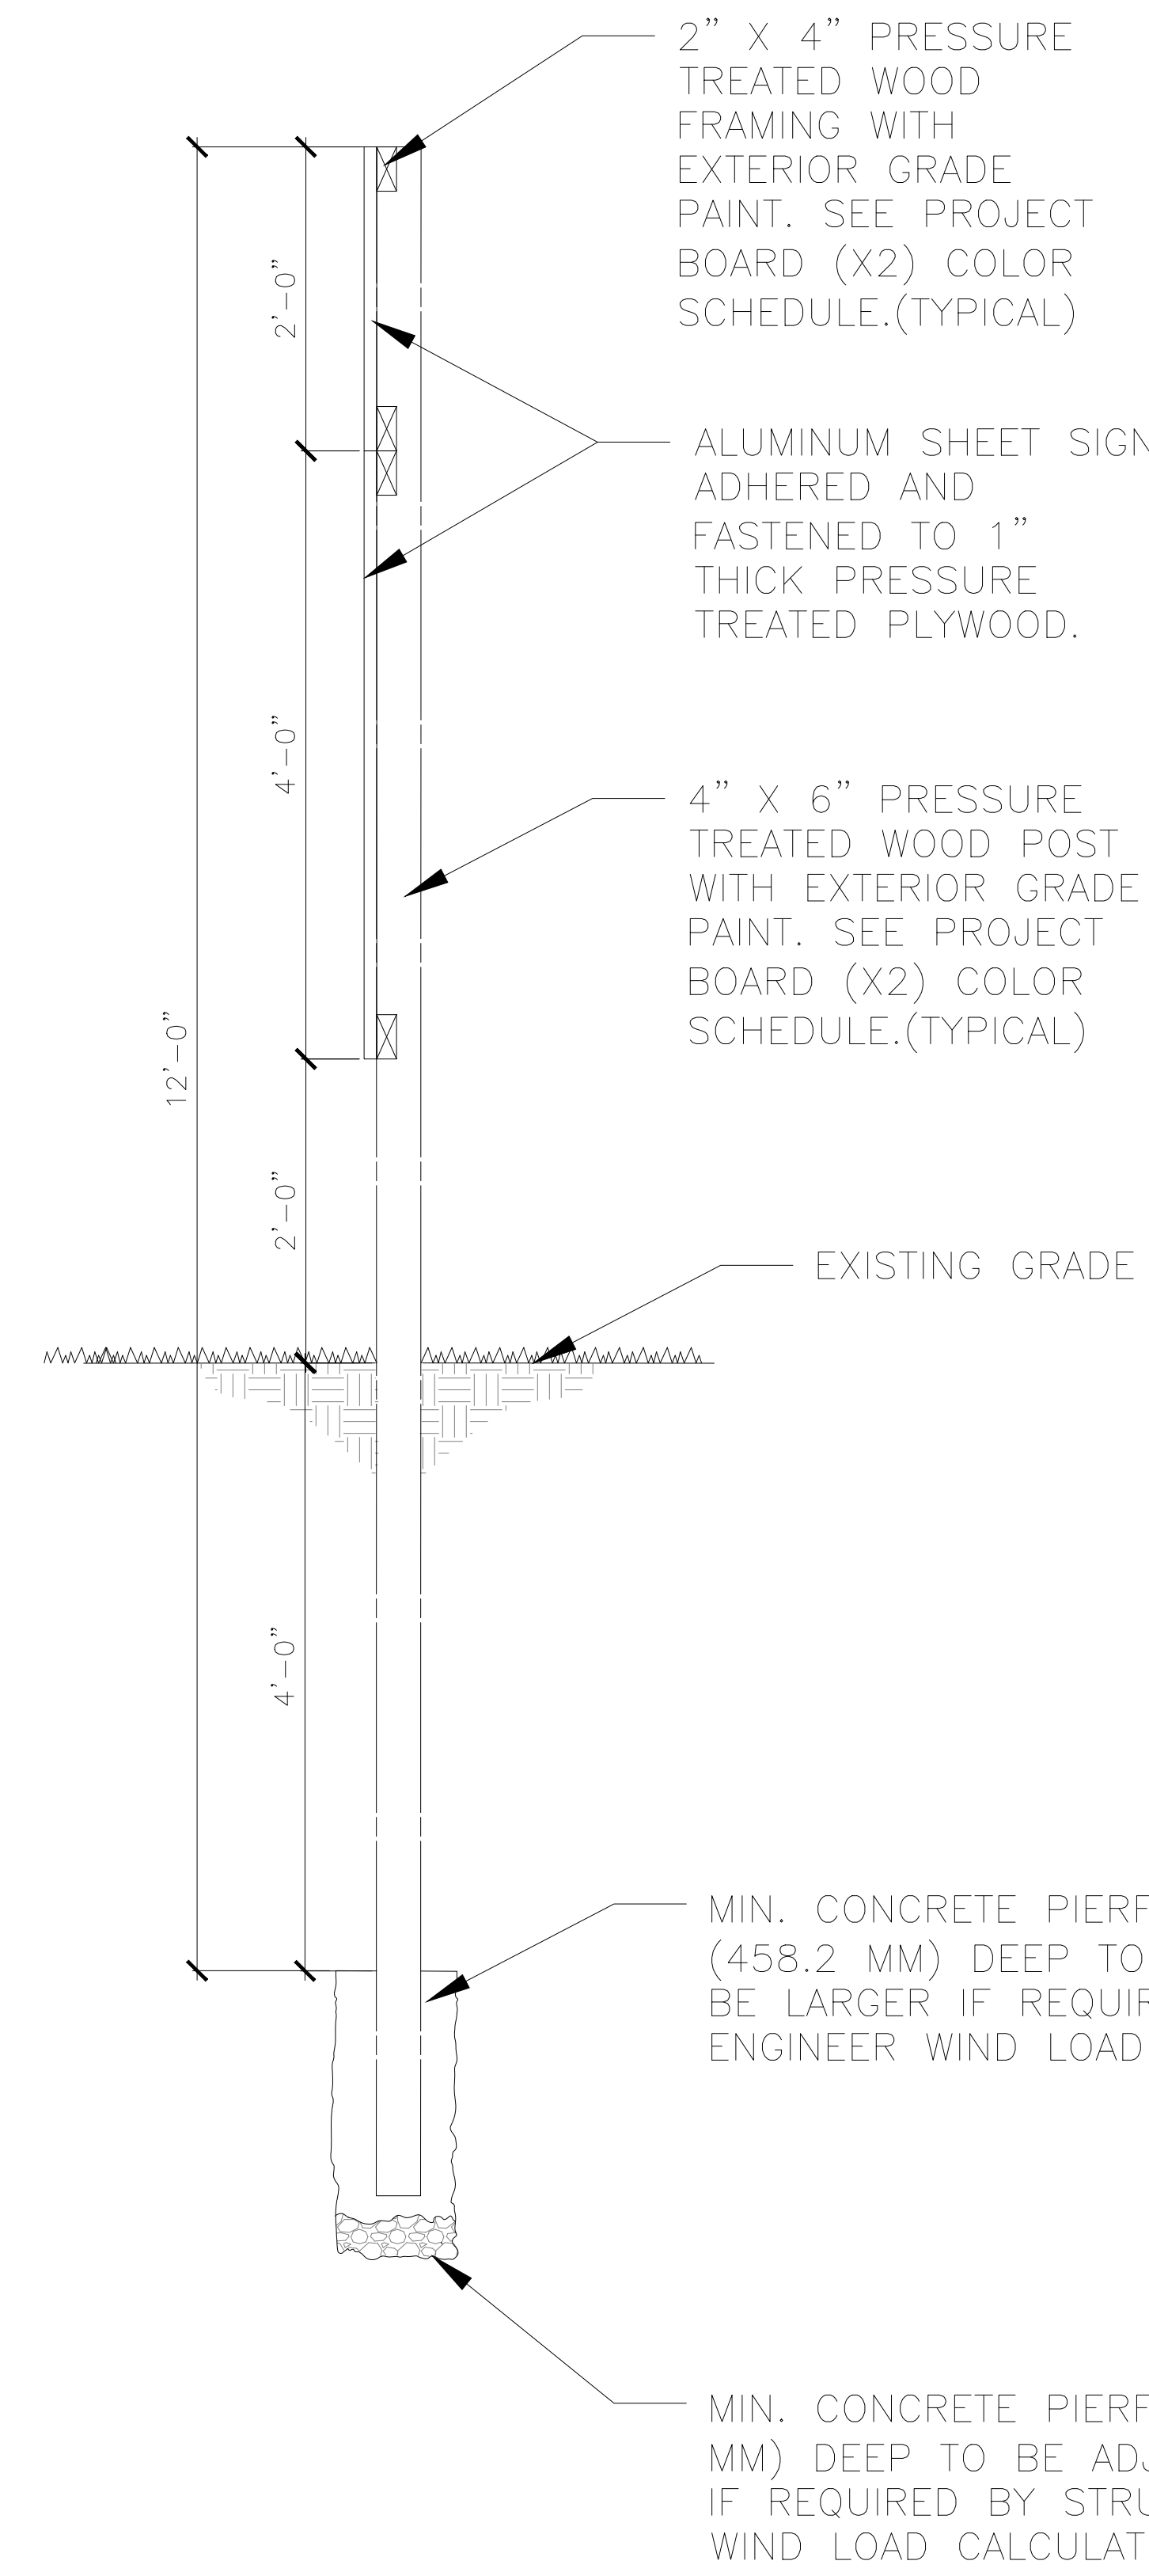


F5 PROJECT BOARD SIGN (X2) SECTION
1" = 1'-0"

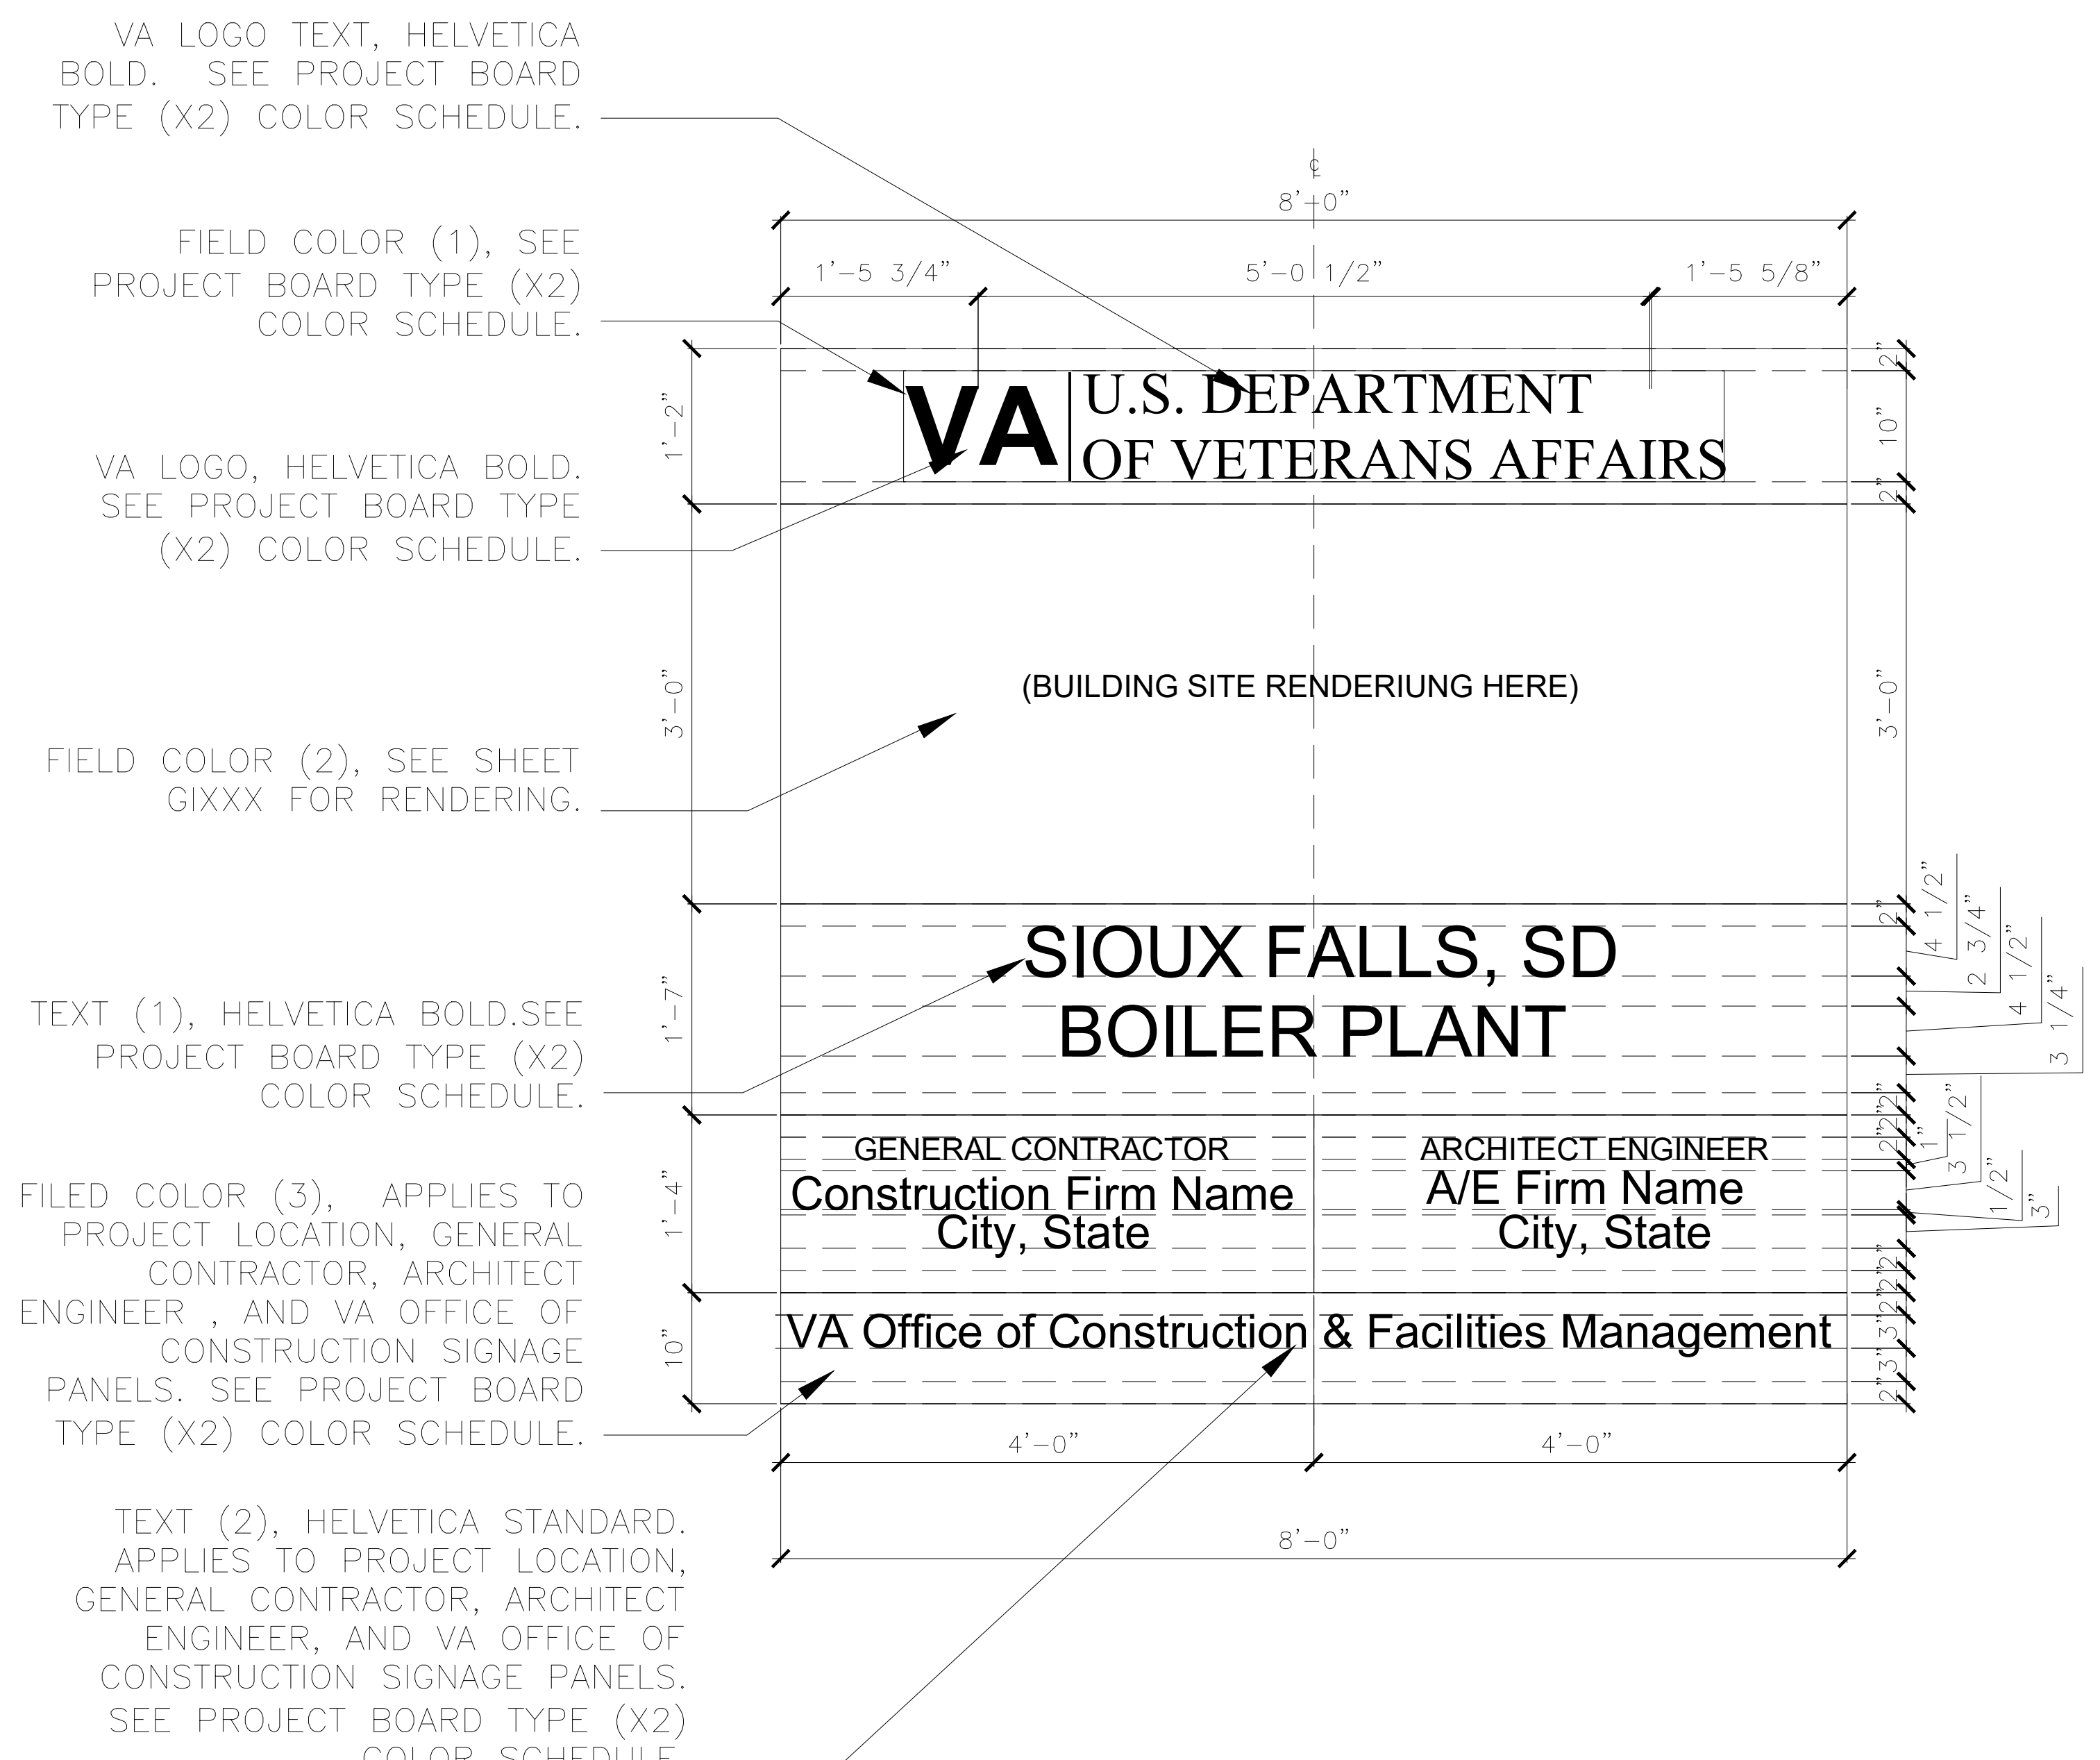



F8 PROJECT BOARD SIGN (X2) DETAIL & COLOR SCHEDULE
1" = 1'-0"

PROJECT BOARD (X2), MESSAGE LAYOUT COLOR SCHEDULE		
FIELD COLOR (1)		
COLOR REF#	COLOR DESCRIPTION	CMYK
B18	VA BLUE	C100 M50 Y0 K40
VA LOGO		
COLOR REF#	COLOR DESCRIPTION	CMYK
B20	SHEEP'S WOOL	C1 M0 Y2 K0
VA LOGO TEXT		
COLOR REF#	COLOR DESCRIPTION	CMYK
B20	SHEEP'S WOOL	C1 M0 Y2 K0
FIELD COLOR (3)		
COLOR REF#	COLOR DESCRIPTION	CMYK
B20	SHEEP'S WOOL	C1 M0 Y2 K0
TEXT (1)		
COLOR REF#	COLOR DESCRIPTION	CMYK
B2	WELLS FARGO BLACK	C77 M66 Y66 K82
TEXT (2)		
COLOR REF#	COLOR DESCRIPTION	CMYK
B2	WELLS FARGO BLACK	C77 M66 Y66 K82
WOOD POST & FRAME COLOR		
COLOR REF#	COLOR DESCRIPTION	CMYK
B18	VA BLUE	C100 M50 Y0 K40



CONSULTANT		ARCHITECT/ENGINEER OF RECORD		Office of Construction and Facilities Management		Drawing Title		Phase		Project Title		Project Number	
		paradigm Architecture Engineering Design-Build 9000 Wesley Place, Louisville, KY 40222 www.paradigmusa.com		U.S. Department of Veterans Affairs		PROJECT BOARD SIGN (X2) PLAN & DETAILS		100% CONSTRUCTION DOCUMENTS		SIoux FALLS BOILER PLANT		438-22-900	
		STAMP		VA		Approved: Project Director		FULLY SPRINKLERED		Location		Building Number	
		09.12.2024								VAMC-Sioux Falls: 2501 W 22nd St, Sioux Falls, SD 57105		12	
										Issue Date		Drawing Number	
										09-12-2024		G1105	
										Checked		Drawn	
												EB	

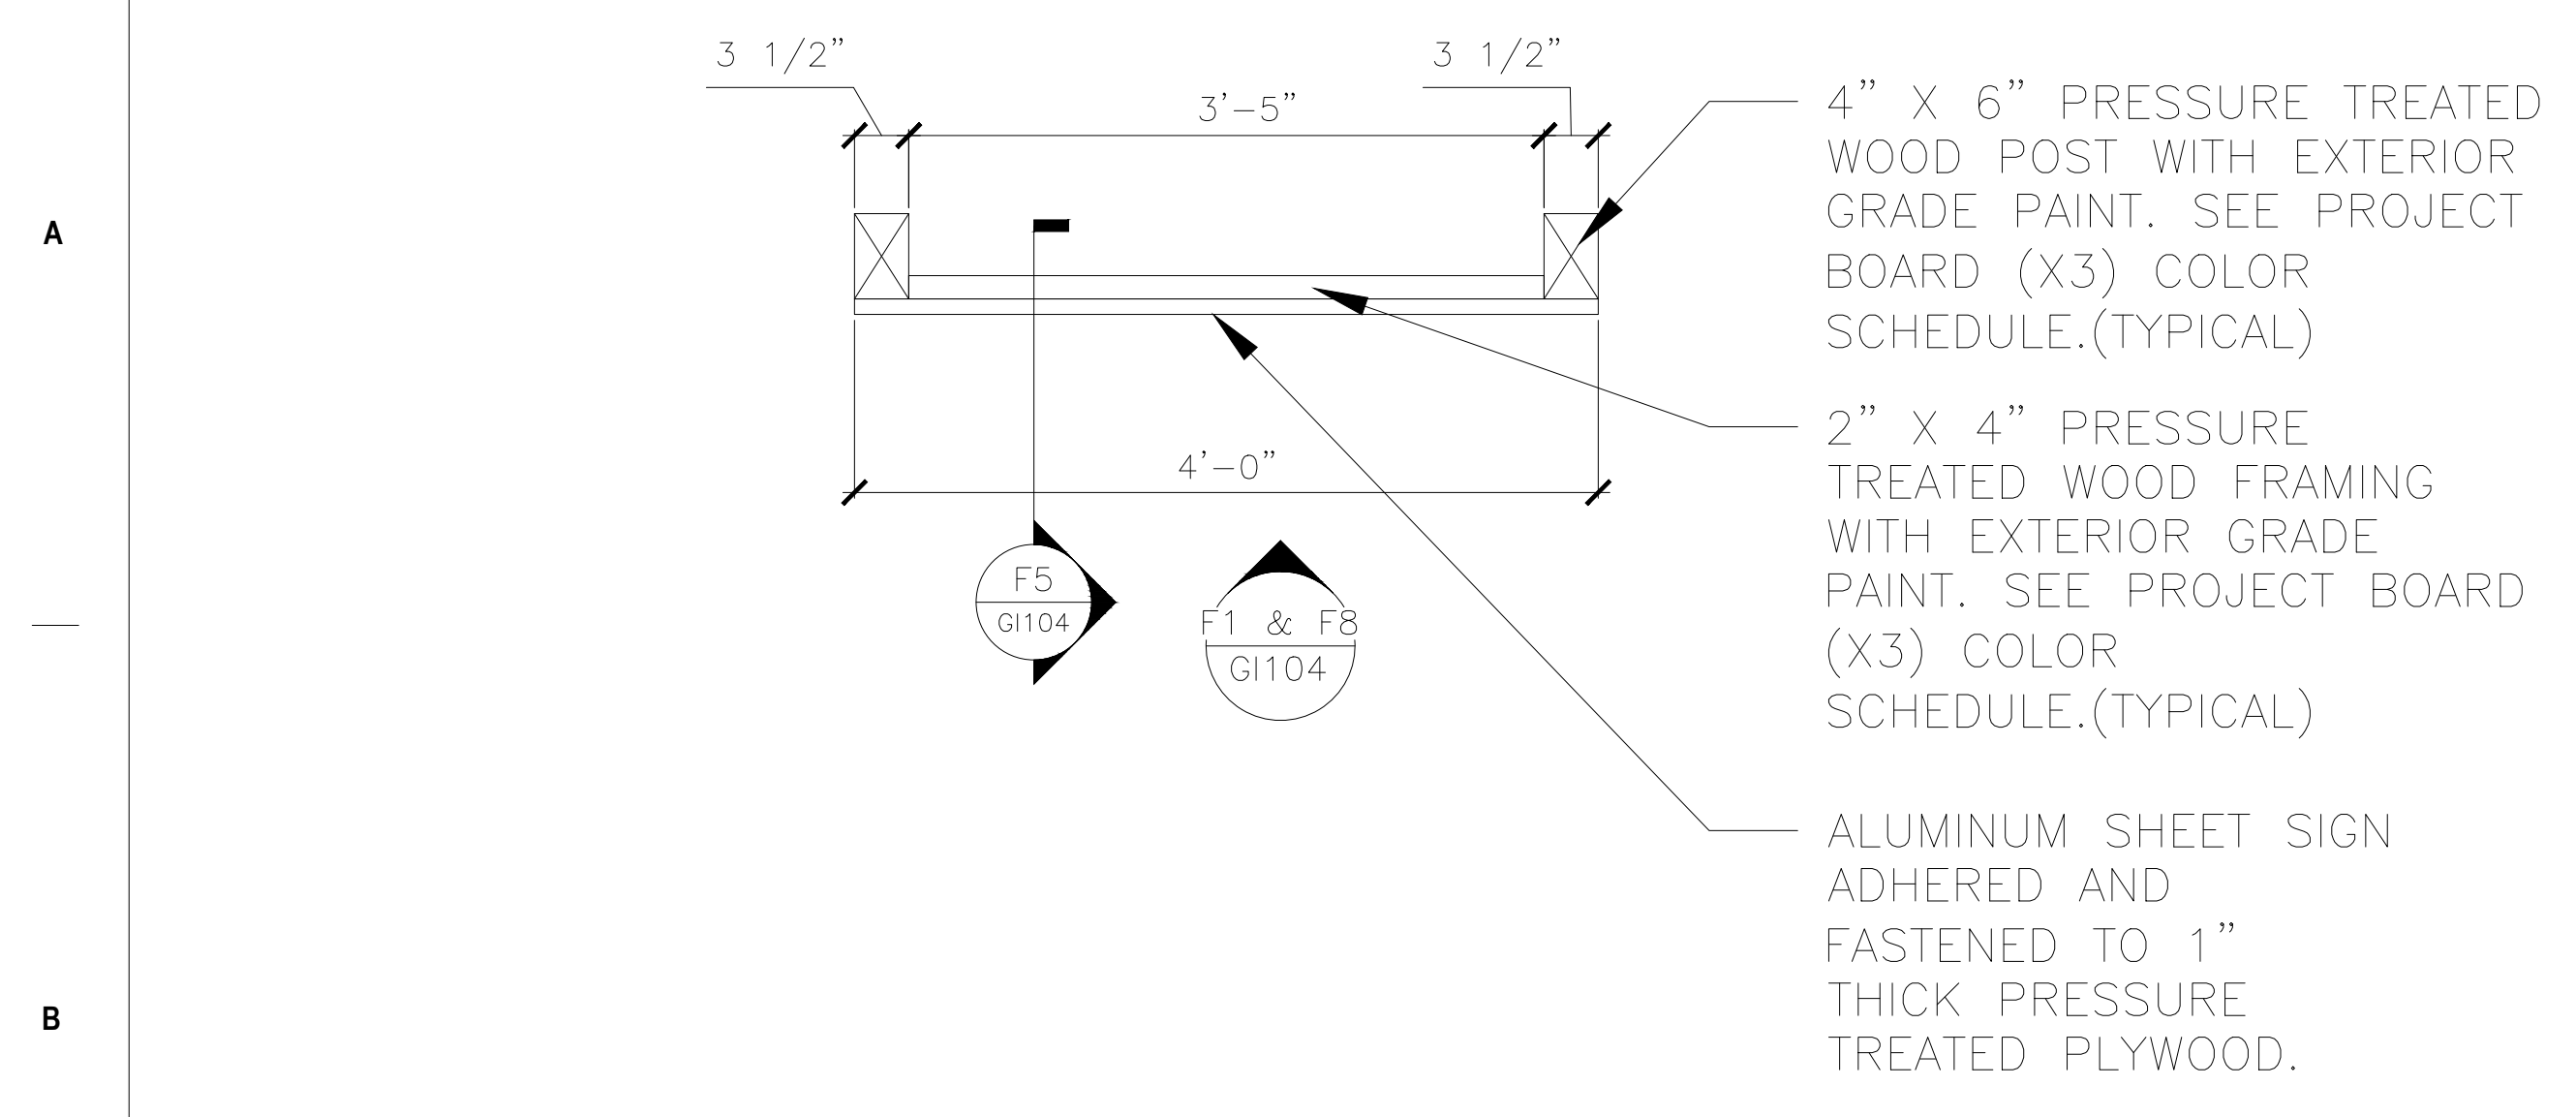


B1 PROJECT BOARD SAFETY SIGN (X3) PLAN
1" = 1'-0"

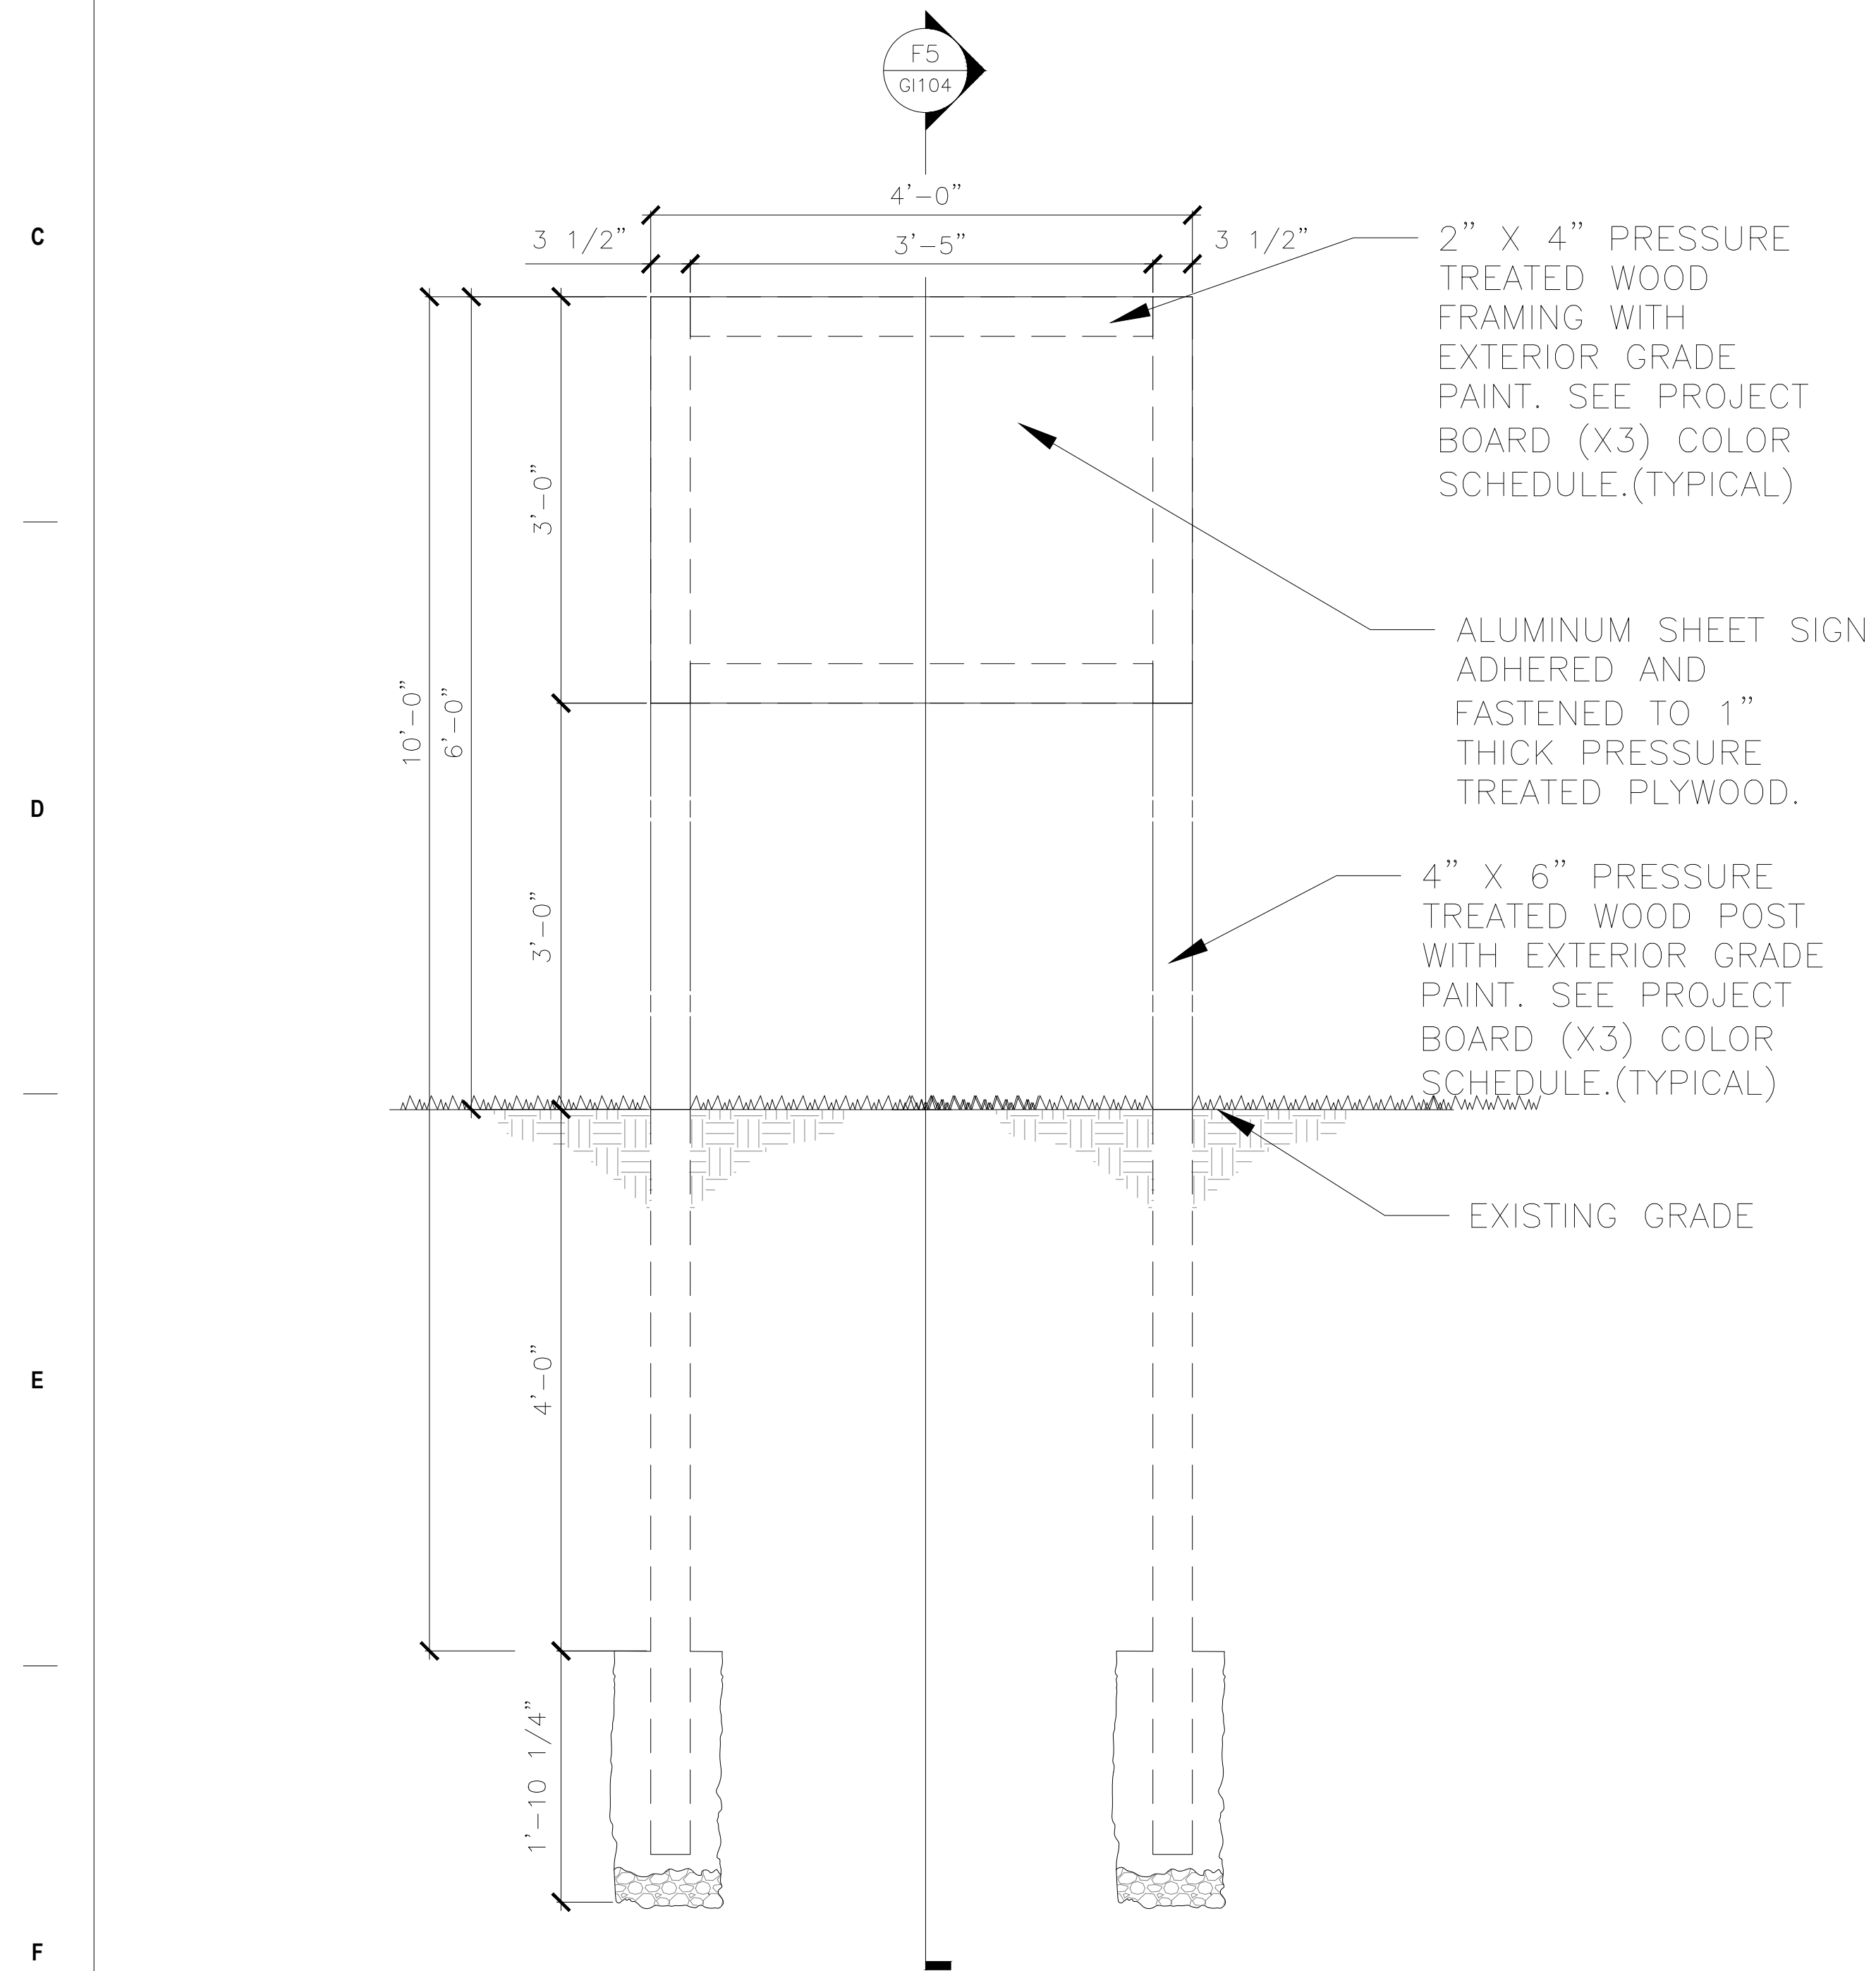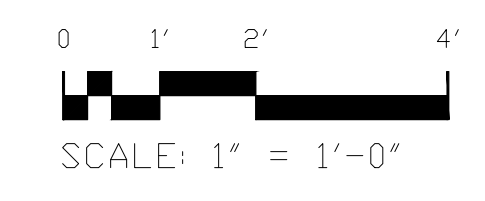

F1 PROJECT SAFETY BOARD SIGN (X2) ELEVATION
1" = 1'-0"

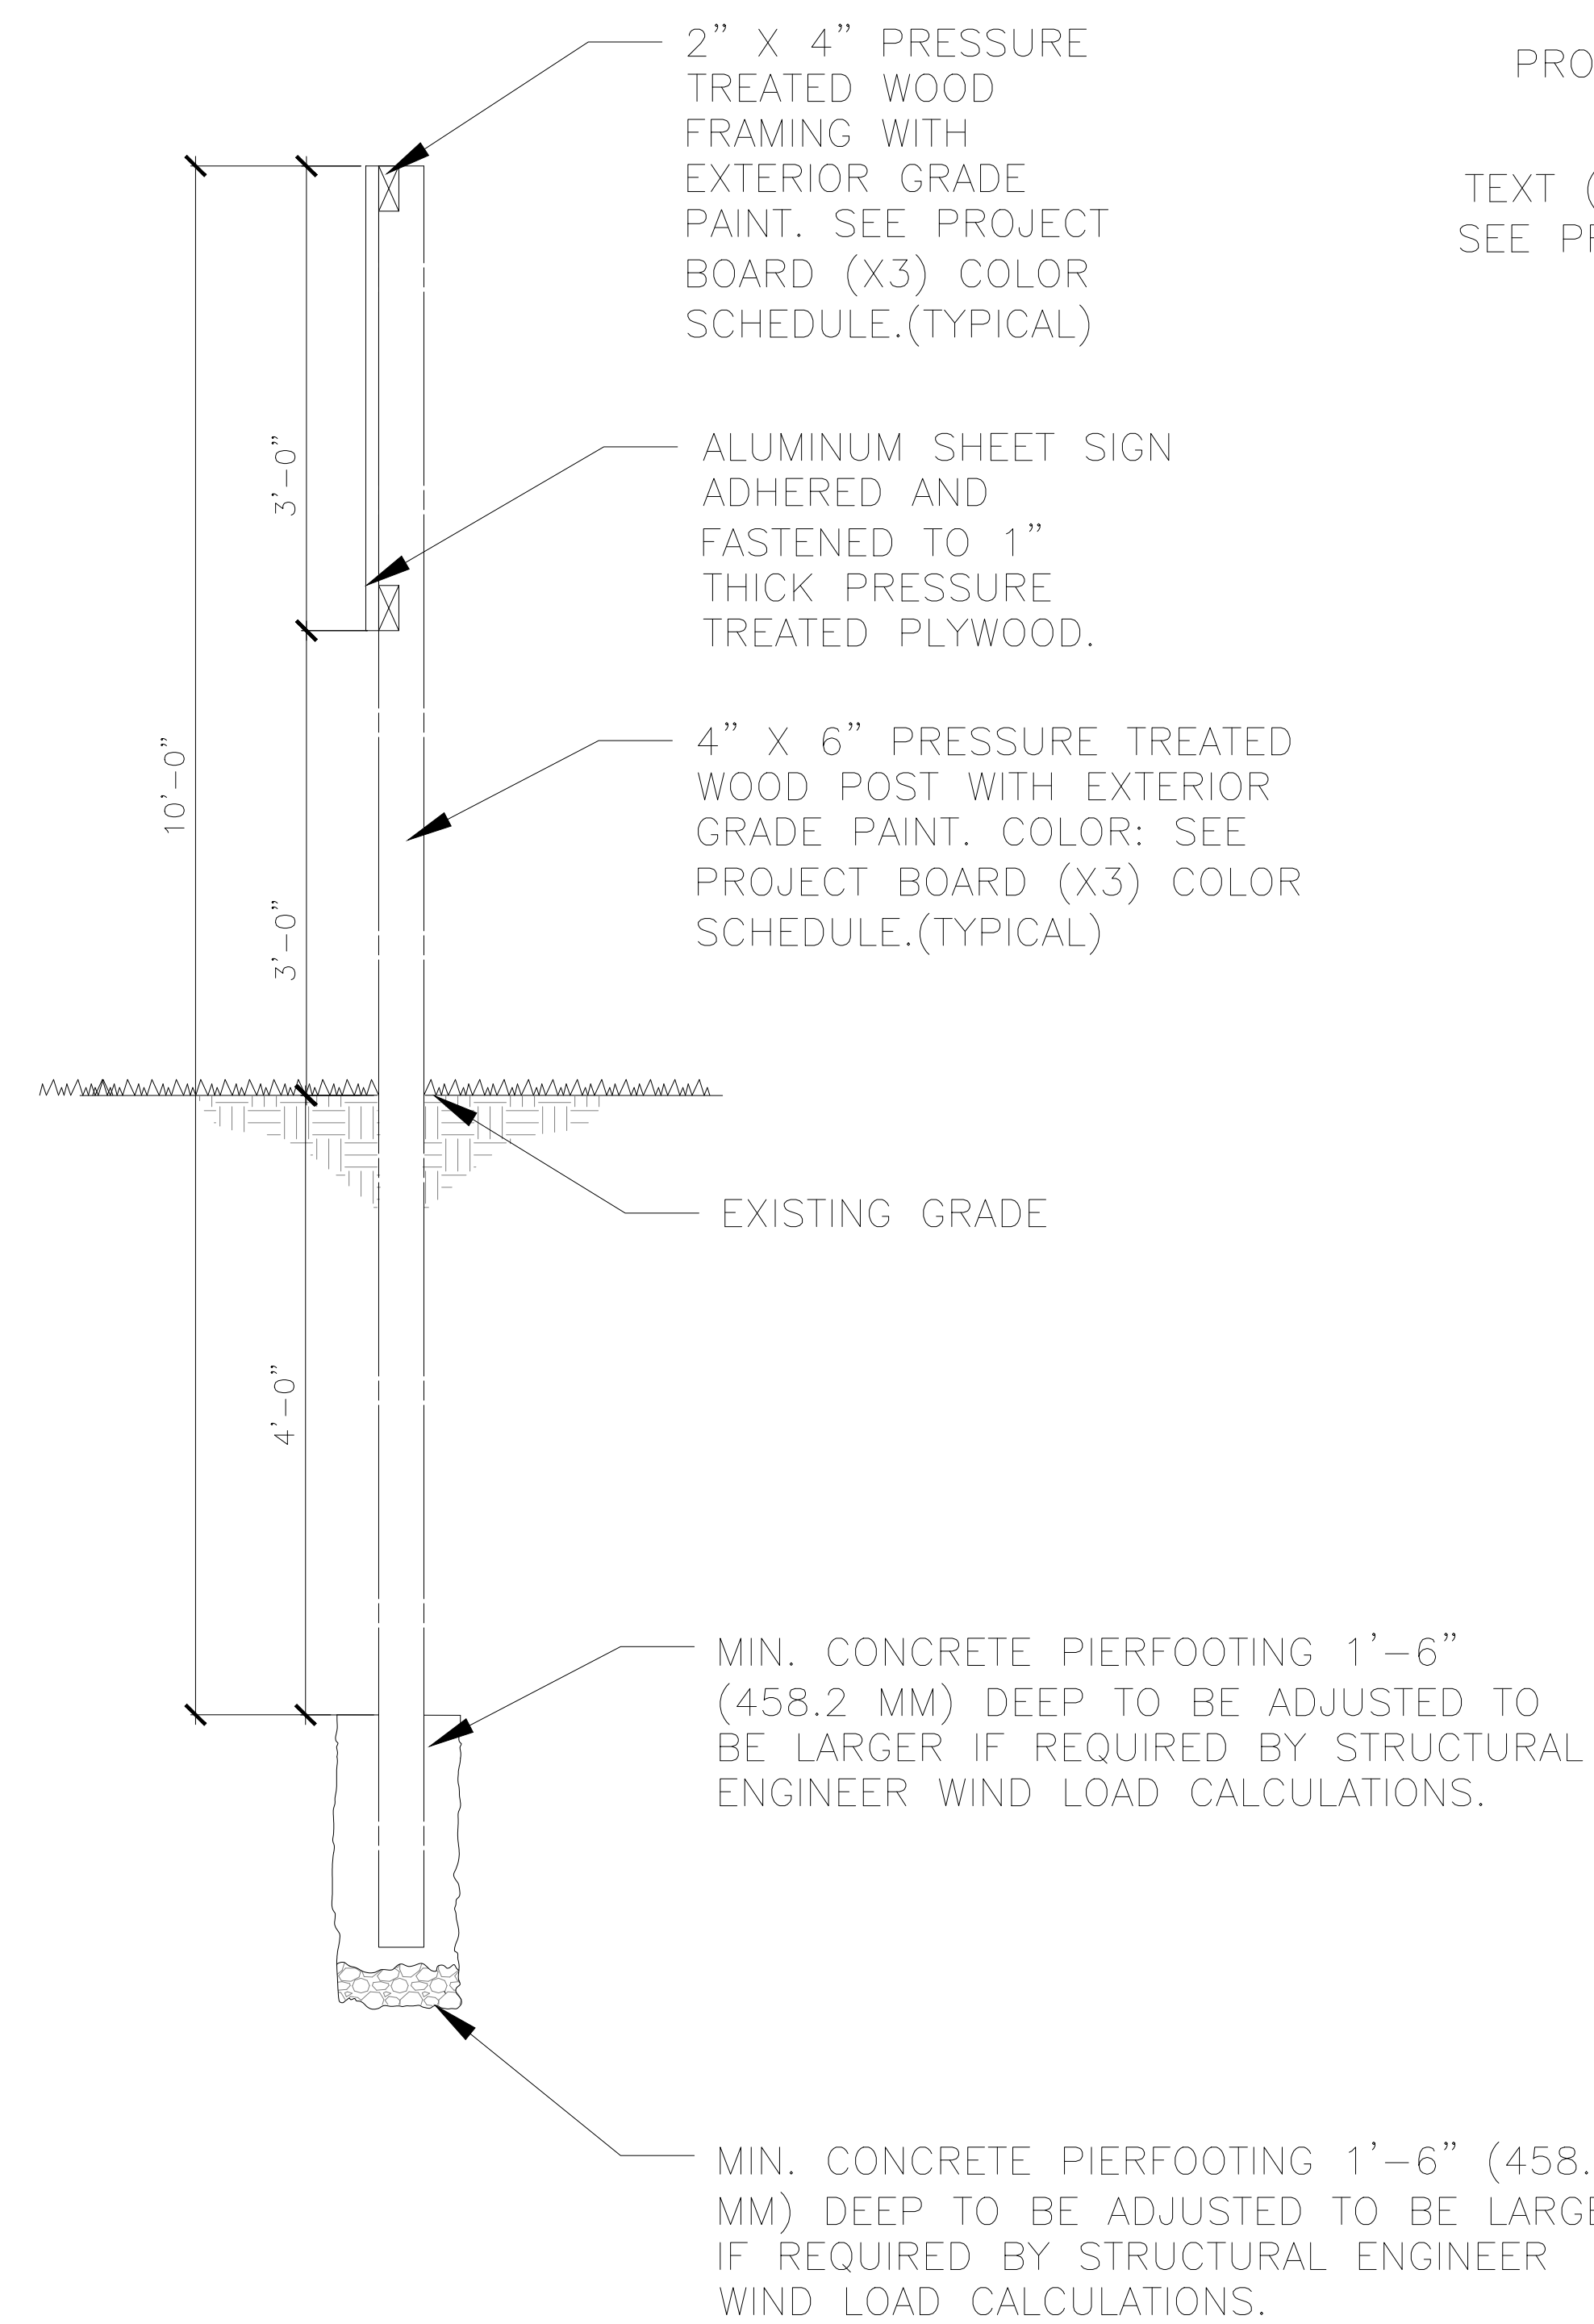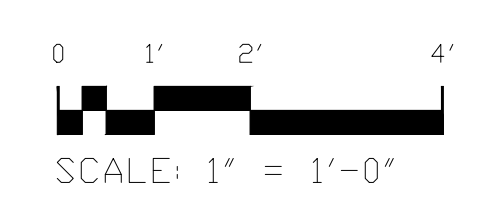



F5 PROJECT SAFETY BOARD SIGN (X2) SECTION
1" = 1'-0"

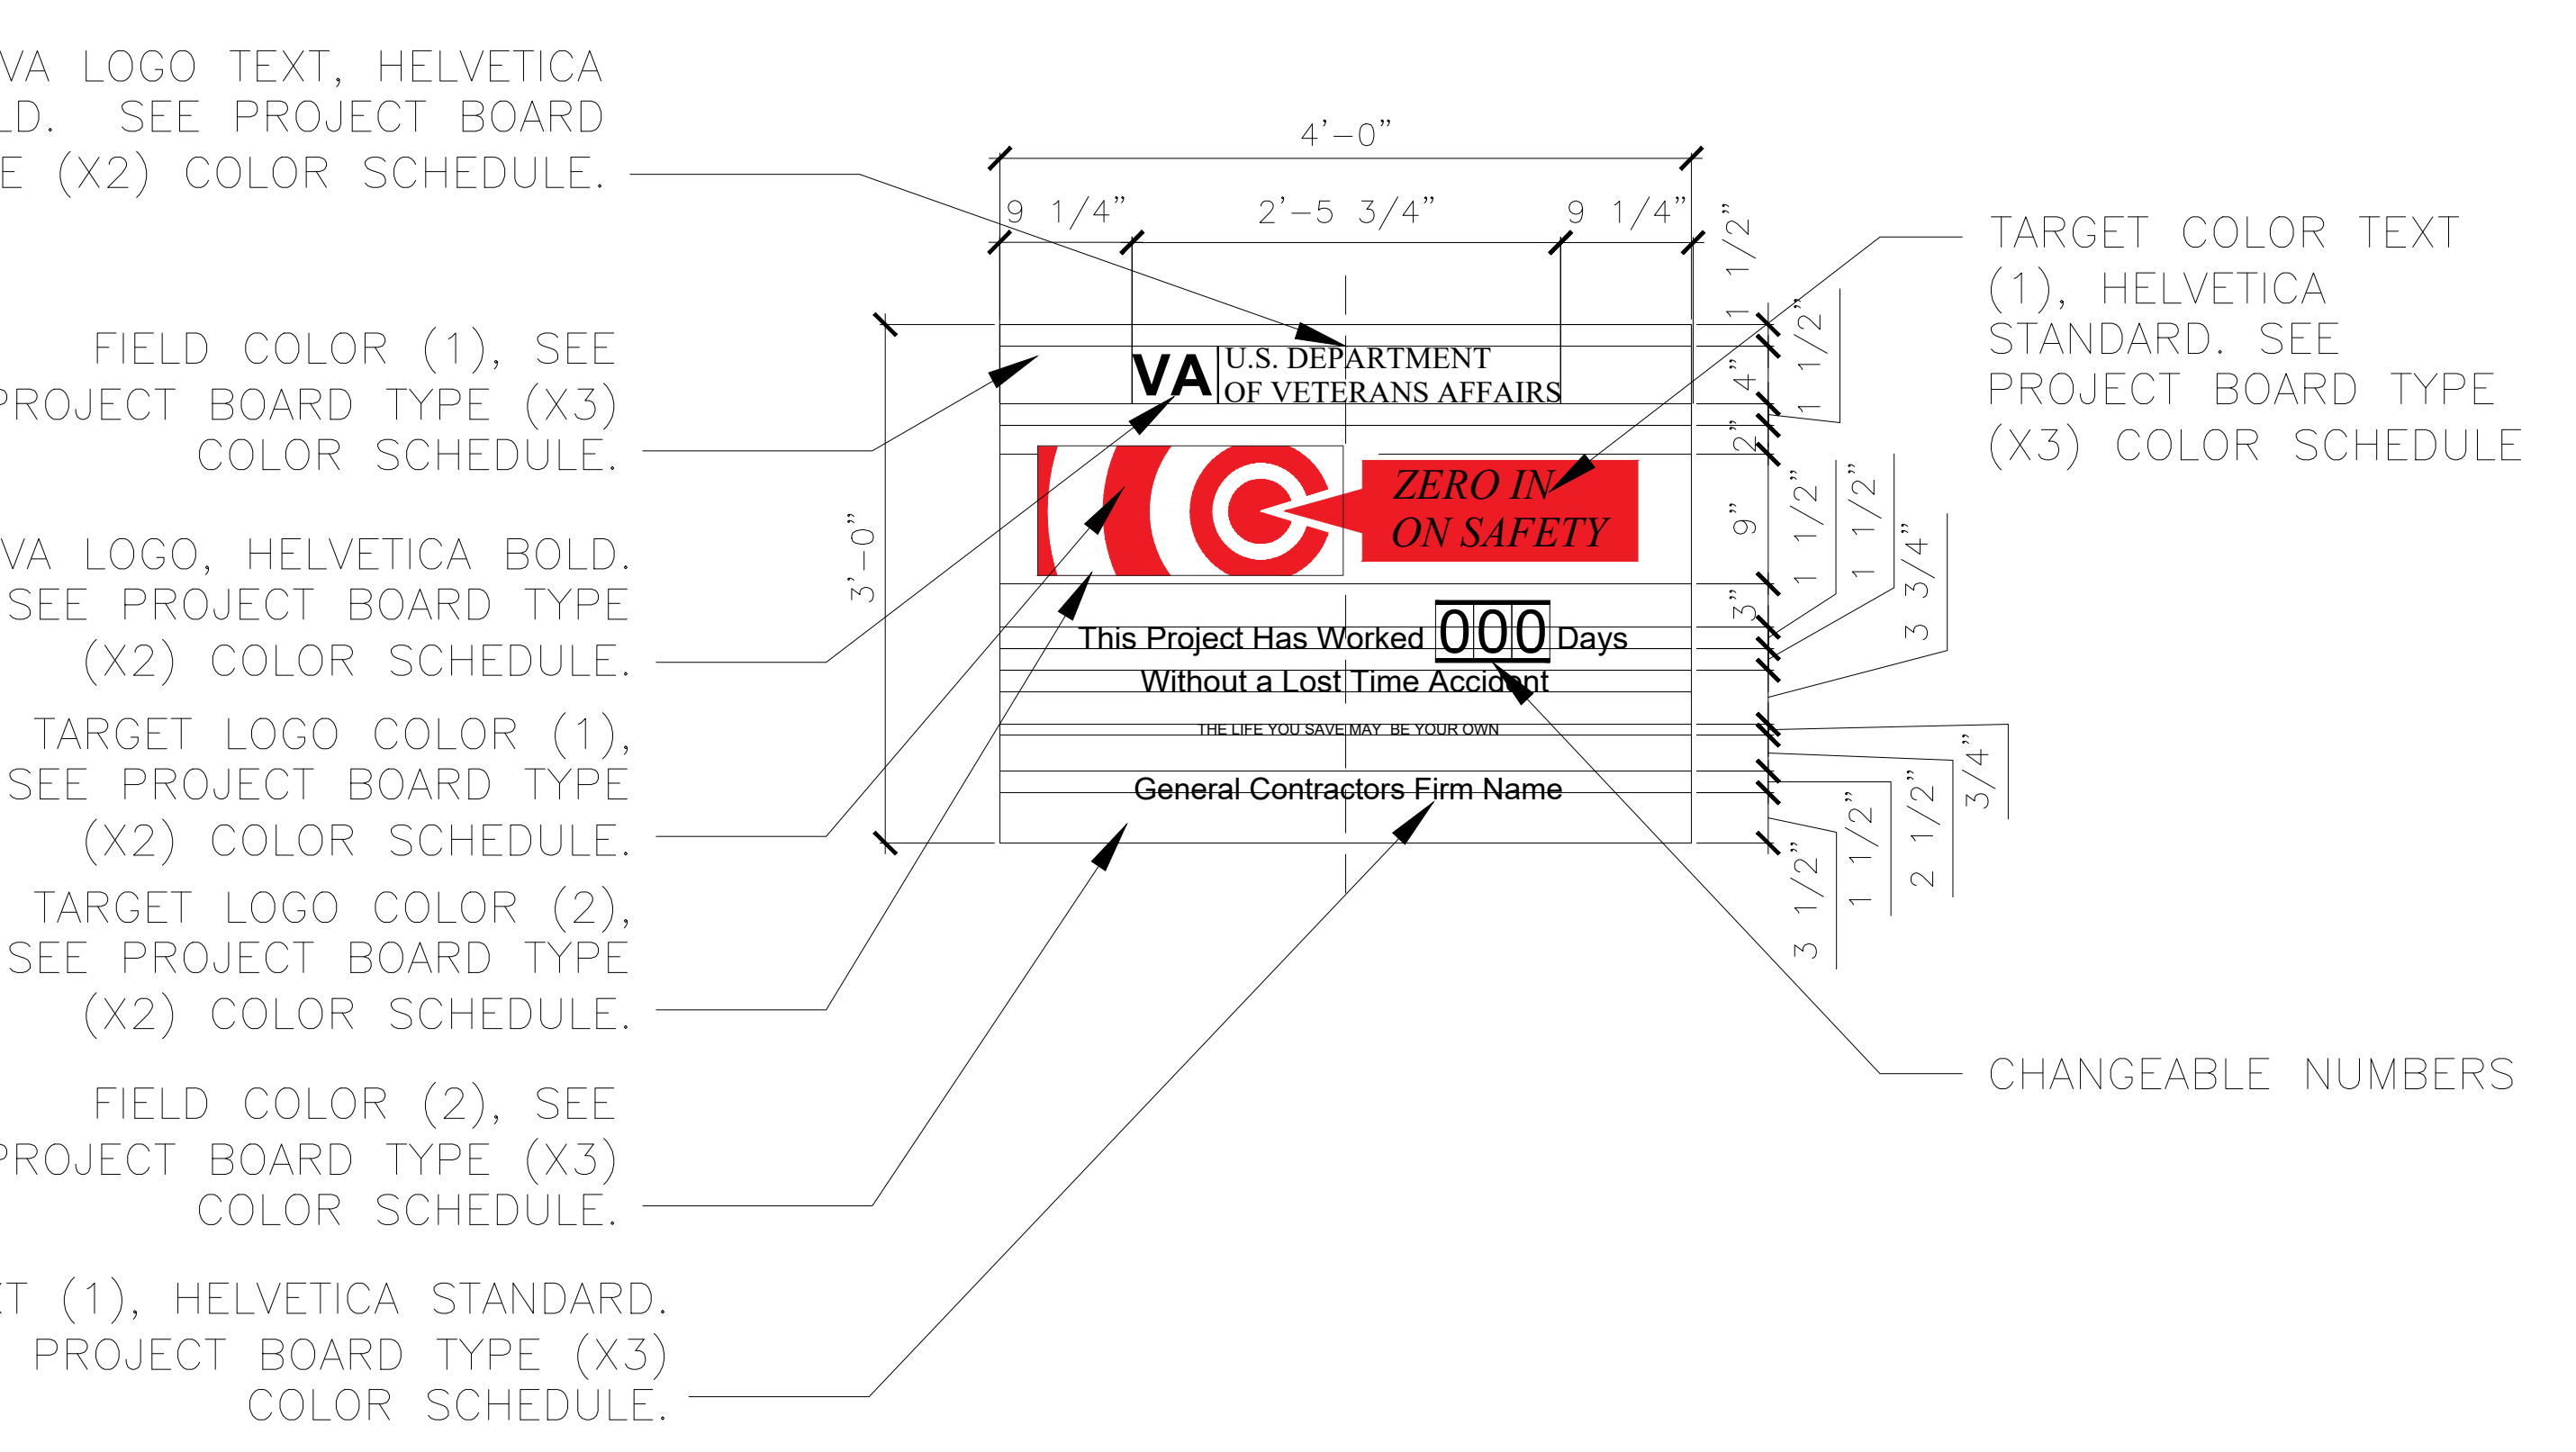

PROJECT BOARD (X3), MESSAGE LAYOUT COLOR SCHEDULE

FIELD COLOR (1)		
COLOR REF#	COLOR DESCRIPTION	CMYK
B18	VA BLUE	C100 M50 Y0 K40
VA LOGO		
COLOR REF#	COLOR DESCRIPTION	CMYK
B20	SHEEP'S WOOL	C1 M0 Y2 K0
VA LOGO TEXT		
COLOR REF#	COLOR DESCRIPTION	CMYK
B20	SHEEP'S WOOL	C1 M0 Y2 K0
FIELD COLOR (2)		
COLOR REF#	COLOR DESCRIPTION	CMYK
B20	SHEEP'S WOOL	C1 M0 Y2 K0
TEXT (1)		
COLOR REF#	COLOR DESCRIPTION	CMYK
B2	WELLS FARGO BLACK	C77 M66 Y66 K82
TARGET COLOR TEXT OUTLINE (1)		
COLOR REF#	COLOR DESCRIPTION	CMYK
B2	WELLS FARGO BLACK	C77 M66 Y66 K82
TARGET COLOR TEXT (1)		
COLOR REF#	COLOR DESCRIPTION	CMYK
B20	SHEEP'S WOOL	C1 M0 Y2 K0
TARGET COLOR (1)		
COLOR REF#	COLOR DESCRIPTION	CMYK
B17	SAFETY RED	C0 M54 Y56 K15
TARGET COLOR (2)		
COLOR REF#	COLOR DESCRIPTION	CMYK
B20	SHEEP'S WOOL	C1 M0 Y2 K0
TARGET OUTLINE COLOR		
COLOR REF#	COLOR DESCRIPTION	CMYK
B2	WELLS FARGO BLACK	C77 M66 Y66 K82
WOOD POST & FRAME COLOR		
COLOR REF#	COLOR DESCRIPTION	CMYK
B18	VA BLUE	C100 M50 Y0 K40

F8 PROJECT SAFETY BOARD SIGN (X2) DETAIL & COLOR SCHEDULE
1" = 1'-0"

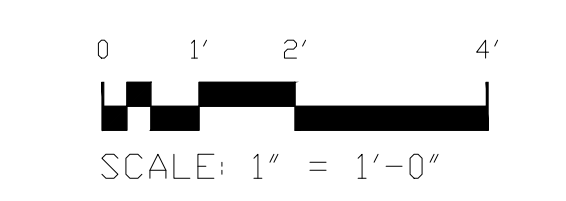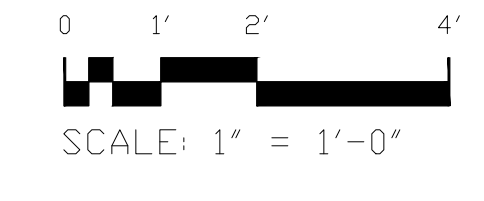

CONSULTANT	ARCHITECT/ENGINEER OF RECORD	STAMP	Office of Construction and Facilities Management	Drawing Title	Phase	Project Title	Project Number		
				PROJECT SAFETY BOARD SIGN (X3) PLAN & DETAILS	100% CONSTRUCTION DOCUMENTS	SIoux FALLS BOILER PLANT	438-22-900		
	paradigm Architecture Engineering Design-Build 9000 Wesley Place, Louisville, KY 40222 www.paradigmusa.com	U.S. DEPARTMENT OF VETERANS AFFAIRS	VA	Approved: Project Director	FULLY SPRINKLERED	Location	Building Number		
						VAMC-SIoux Falls: 2501 W 22nd St, Sioux Falls, SD 57105	12		
						Issue Date	Checked	Drawn	G1106
						09-12-2024		EB	