		LEGEND	
A			
			EXISTING
		LIMIT OF DEMOLITION (APPROXIMATE) KEYED NOTE, "X" INDICATES NUMBER	
			W
			S
		UNDERGROUND STEAM	ST
			C
			—— E ——
		UNDERGROUND GAS UNDERGROUND FUEL	G
			OH
		STORMWATER PIPE	D
В		CATCH BASIN	
		STORMWATER MANHOLE	
		STEAM MANHOLE SANITARY MANHOLE	5) S
		YARD DRAIN	
		ELECTRIC MANHOLE	Ē
		ELECTRIC HANDHOLE	ΩE
		GATE VALVE	⊠gv
		POST INDICATOR VALVE	opiv <i>FH</i>
		FIRE HYDRANT CONTOUR	FH <sub>Q</sub> -
		SPOT ELEVATION	× 1498.6
		INDEX CONTOUR	- 1490
C		INTERMEDIATE CONTOUR	1491
		LIGHT POLE	☆ ヽ/ ヽ/ ヽ/
		FENCE GUARDRAIL	$ \begin{array}{c} \times  \times  \times \\ - \Box  \Box  \Box  \end{array} $
		SIGNS	
		ROOF DRAIN	
		TREE LINE AND SINGLE TREE	
		COMPOST SOCK	
		PARKING STALLS VENT	
		PUMP	
D			
Е			
F			
			CONSULTAN
			Scientists I
			Ma 105 Central
		ADDENDUM 2 (NO CHANGES TO THIS SHEET) ADDENDUM 1 (NO CHANGES TO THIS SHEET)	09-12-2024 08-09-2024
		Revisions:	Date:
	VA FORM 08-6231		

3


2

3

- 1



4

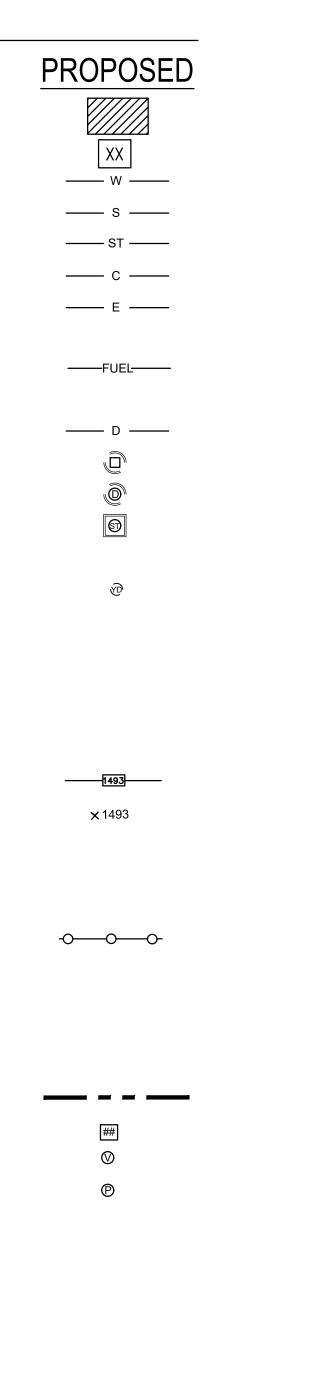

### ABBREVIATIONS

AC	AIR CONDITIONING UNITS
BC	BOTTOM CURB
BIT	BITUMINOUS
BOW	BOTTOM OF WALKWAY
COR	CONTRACTING OFFICER'S REPRESENTATIVE
СВ	CATCH BASIN
CC	CONCRETE CURB
CI	CAST IRON
CJ	CONTROL JOINT
CO	CLEAN OUT
CONC	CONCRETE
CMP	CORRUGATED METAL PIPE
CPP	CONCRETE PRESSURE PIPE
DMH	DRAIN MANHOLE
ELEV	ELEVATION
EJ	EXPANSION JOINT
EOP	EDGE OF PAVEMENT
FFE	FINISHED FLOOR ELEVATION
FH	FIRE HYDRANT
GV	GATE VALVE
HDPE	HIGH DENSITY POLYETHYLENE
HP	HIGH PRESSURE
HVAC	HEATING, VENTILATION, AND AIR CONDITIONING EQUIPMENT
I.D.	INSIDE DIAMETER
INV.	PIPE INVERT
L	LENGTH
LP	LOW PRESSURE
LSA	LANDSCAPED AREA
MIN	MINIMUM
0.P.	ON CENTER
PIV	POST INDICATOR VALVE
PSI	POUNDS PER SQUARE INCH
PVC	POLYVINYL CHLORIDE
R	RADIUS
(R)	RECORD INFORMATION
RCP	REINFORCED CONCRETE PIPE
RD	ROOF DRAIN
RFI	REQUEST FOR INFORMATION
S	PIPE SLOPE
SMH	SEWER MANHOLE
TC	TOP CURB
T.G.	TOP GRATE
TYP	TYPICAL
VA	VETERANS AFFAIRS
VGC	VERTICAL GRANITE CURB
VGC V.I.F.	VERIFY IN FIELD
V.I.F. WWF	WELDED WIRE FABRIC
W/	WELDED WIRE FABRIC
vv/ YD	YARD DRAIN
й Ø	DIAMETER
<u>ل</u> ع	





### **GENERAL NOTES:**

7

THE CONTRACTOR SHALL FIELD VERIFY ALL EXISTING CONDITIONS AND DIMENSIONS PRIOR TO CONSTRUCTION AND REPORT DISCREPANCIES VIA THE REQUEST FOR INFORMATION (RFI) PROCESS. THE CONTRACTOR SHALL PROCEED WITH THE WORK ONLY AFTER THE DISCREPANCIES HAVE BEEN RESOLVED BY THE CONTRACTING OFFICER'S REPRESENTATIVE (COR)

8

- IT IS NOT THE INTENT OF THESE DRAWINGS TO SHOW EVERY DETAIL AND CONDITION. CONTRACTOR SHALL INCLUDE ALL WORK REQUIRED TO COMPLETE THE PROJECT BASED ON ALL THE INFORMATION PROVIDED AND INFORMATION OBTAINED DURING A THOROUGH SITE VISIT PRIOR TO SUBMISSION OF BID.
- 3. CARE SHALL BE TAKEN BY THE CONTRACTOR TO PROTECT EXISTING SYSTEMS AND SURFACES TO REMAIN. ALL DAMAGE RESULTING FROM THE CONTRACTOR'S OPERATIONS SHALL BE REPAIRED OR REPLACED AS APPROVED BY THE COR AT NO ADDITIONAL COST TO THE VA.
- 4. THE CONTRACTOR SHALL TAKE ALL PRECAUTIONS AS REQUIRED TO CONTROL DUST AND NOT DISRUPT BASE OPERATIONS.
- 5. THE CONTRACTOR SHALL PROTECT ALL ADJACENT CONSTRUCTION AND FINISHES THAT ARE TO REMAIN.
- THE CONTRACTOR SHALL PROVIDE BARRICADES AT ALL WORK AREAS TO PREVENT UNAUTHORIZED PERSONNEL FROM ENTERING AREAS OF WORK. 6.
- 7. ALL DIMENSIONS ARE IN DECIMAL FEET UNLESS NOTED OTHERWISE.
- THE CONTRACTOR SHALL COORDINATE THE TIMING AND SEQUENCE OF THE WORK WITH THE
- 9. THE CONTRACTOR SHALL BE RESPONSIBLE FOR THE REMOVAL AND DISPOSAL OF ALL DEMOLITION MATERIALS, UNLESS NOTED OTHERWISE.
- 10. COORDINATE CLEANING OF THE WORK AREA WITH ALL APPLICABLE CITY, STATE, AND FEDERAL REGULATIONS.
- 11. EXECUTE WORK IN A CAREFUL AND ORDERLY MANNER WITH LEAST POSSIBLE DISTURBANCE TO THE PUBLIC AND OTHER OCCUPANTS OF THE FACILITY.
- 12. "PROVIDE" MEANS FURNISH AND INSTALL.
- 13. REFER TO THE SPECIFICATIONS FOR ADDITIONAL INFORMATION.
- THE CONTRACTOR AND ALL TRADES SHALL NOTE REQUIREMENTS OF GENERAL NOTES HERE AS WELL AS NOTES ON ALL OTHER SHEETS.
- 15. REFER TO ALL CONSTRUCTION DOCUMENTS FOR REQUIREMENTS WHICH MAY AFFECT THE WORK.
- 16. THE CONTRACTOR SHALL BE RESPONSIBLE FOR PROVIDING ALL MATERIALS (UNLESS NOTED OTHERWISE) AND WORKMANSHIP IN ACCORDANCE WITH FEDERAL, STATE, CITY, AND LOCAL BUILDING CODES AND THEIR REQUIREMENTS. ANY DISCREPANCIES OR INCONSISTENCIES BETWEEN THE CODE AND THE CONSTRUCTION DOCUMENTS SHALL BE BROUGHT TO THE ATTENTION OF THE COR PRIOR TO PROCEEDING WITH ANY ASSOCIATED WORK.
- 17. WHERE DRAWINGS DO NOT ADDRESS INSTALLATION METHODOLOGY, THE CONTRACTOR SHALL BE BOUND TO PERFORM IN STRICT COMPLIANCE WITH THE MANUFACTURER'S SPECIFICATIONS, AND INDUSTRY STANDARDS.
- 18. UTILITY INTERRUPTIONS SHALL BE SCHEDULED 10-WORKING DAYS BEFORE DATE OF INTERRUPTION. COORDINATE WITH COR.
- 19. CONTRACTOR SHALL NOT OPERATE GAS OR DIESEL EQUIPMENT WITHIN 75 FEET OF BUILDING AIR INTAKES.
- 20. CONTRACTOR SHALL COMPLY WITH BID DOCUMENTS FOR ALL EROSION CONTROL AND SITE SAFETY REQUIREMENTS.
- 21. A CERTIFIED SWPPP INSPECTOR SHALL BE RESPONSIBLE FOR ALL EROSION CONTROL INSPECTIONS THROUGHOUT CONSTRUCTION ACTIVITIES.

### SURVEY AND UTILITY NOTES

- 1. HORIZONTAL DATUM: NAD83 (2011)(EPOCH:2010.0000) SOUTH DAKOTA SOUTH ZONE GRID.
- 2. VERTICAL DATUM: NAVD88 (GEOID18)
- 3. UNDERGROUND UTILITY LOCATIONS SHOWN ON THIS SURVEY ARE THE RESULT OF QUALITY LEVEL B SUBSURFACE UTILITY ENGINEERING BY SUMMIT ENVIRONMENTAL SERVICES IN DECEMBER 2022, AND FROM INFORMATION PROVIDED BY OTHERS, ALONG WITH FIELD OBSERVATION AND LOCATION OF UNDERGROUND UTILITY EVIDENCE.
- 4. CONTOURS ARE SHOWN AT 1 FOOT INTERVALS FROM REMOTE SENSING SURVEY BY T3 GLOBAL STRATEGIES AND SUPPLEMENTED BY FIELD SURVEY LOCATIONS PERFORMED BY HONOR ENGINEER CO. IN DECEMBER 2022 WITH ADDITIONAL SURVEY PROVIDED IN MARCH 2024.
- 5. AREAS SHOWN UNDER CONSTRUCTION ARE SUBJECT TO CHANGES DUE TO ON-GOING EARTH MOVING ACTIVITIES AND CONSTRUCTION IMPROVEMENTS. CONTOURS, FEATURES AND UTILITIES SHOWN IN THESE AREAS SHOULD BE FIELD VERIFIED PRIOR TO ANY DESIGN ACTIVITY.
- 6. ALL UNDERGROUND UTILITIES SHOWN ON THIS PLAN ARE A COMPILATION OF ACTUAL FIELD LOCATIONS AND DATA FURNISHED FROM INFORMATION SUPPLIED BY OTHERS. HONOR ENGINEER COMPANY ASSUMES NO RESPONSIBILITY FOR THE LOCATION OF ANY UNDERGROUND UTILITIES AS DEPICTED ON THIS DRAWING. ANY REQUESTS FOR ADDITIONAL UNDERGROUND UTILITY INFORMATION SHOULD BE DIRECTED TO THAT RESPECTIVE UTILITY COMPANY.
- 7. SOUTH DAKOTA 811 LOCATE REQUEST TICKET NUMBER: #2233123760 VAMC-SIOUX FALLS AND #2407425961 - VAMC-SIOUX FALLS.
- 8. THE APPROXIMATE UTILITY LINES AS DEPICTED IN DASHED GRAY SCALE LINE TYPES ON CS101 AND CS102 ARE SHOWN BASED ON INFORMATION PROVIDED BY THE VAMC. THESE LINES WERE UNABLE TO BE LOCATED VIA SUE INVESTIGATION. HONOR ENGINEER CO. ASSUMES NO RESPONSIBILITY FOR THE EXACT LOCATION OR EXISTENCE OF THESE LINES. CHANGES TO UTILITIES AFTER THE DATE OF SUE INVESTIGATION (12-01-2022 THRU 12-03-2022 FOR THE PRIMARY SURVEY LIMITS AND 03-19-2024 FOR THE ADDITIONAL SUPPLEMENTAL SURVEY LIMITS) MAY HAVE OCCURRED AND THEREFORE MAY RESULT IN VARIANCES FROM THIS PLAN. CONSIDERATION SHOULD BE GIVEN TO UPDATING THIS PLAN IF DEEMED ADVISABLE PRIOR TO FINAL DESIGN AND CONSTRUCTION.

	Drawing Title	Phase	Project Title	
of ction ilities	CIVIL LEGEND, ABBREVIATIONS, AND GENERAL NOTES	100% CONSTRUCTION DOCUMENT SUBMISSION	SIOUX FALLS BOILER PLANT	
ment	Approved: Project Director		Location VAMC-Sioux Falls: 2501 W	22nd St
epartment		FULLY SPRINKLERED	Issue Date	hecked
erans S			08-09-2024	RBI
	7	8	9	

		Project Number	
		438-22-900	
		Building Number	
		12	
		Drawing Number	
St, Sioux	Falls, SD 57105		
d	Drawn	C-001	
BB	EG	1 OF 17	
		10	

\_\_\_\_

С


\_\_\_\_

D

\_\_\_\_

Ε

F

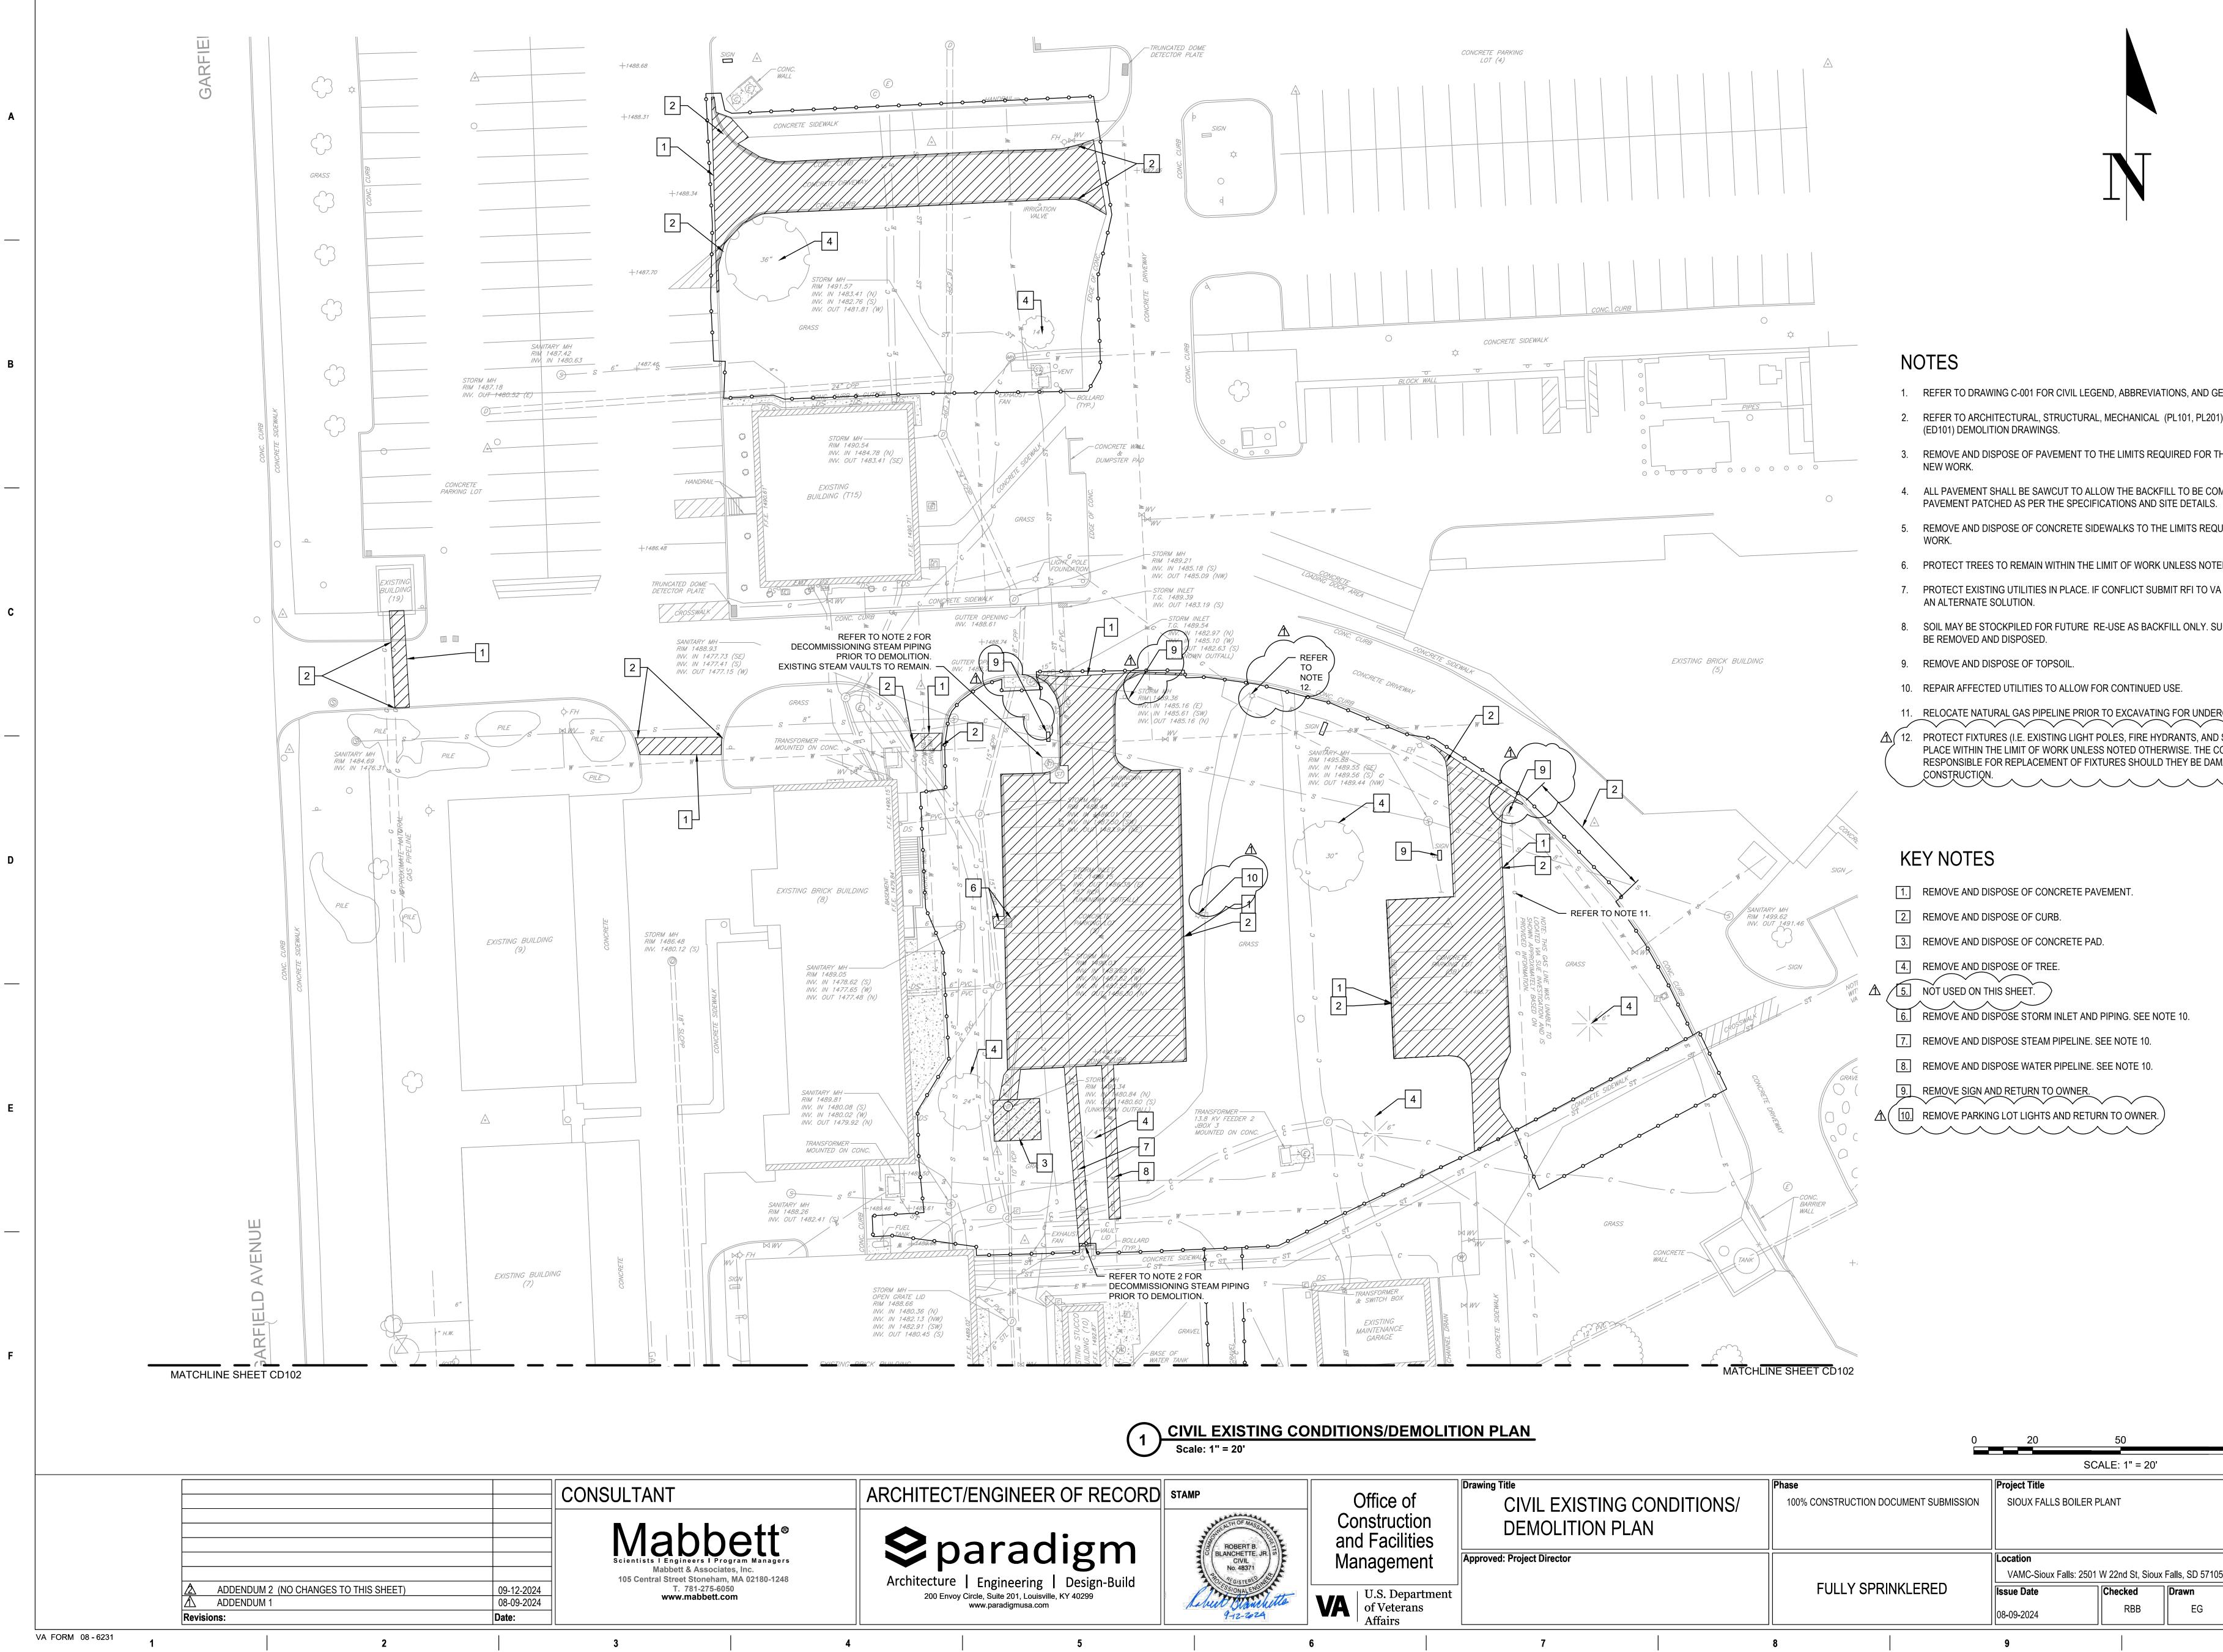

2

3

4

### 5 CONTROLLED UNCLASSIFIED INFORMATION

7

CUI

# NOTES

8

1. REFER TO DRAWING C-001 FOR CIVIL LEGEND, ABBRE

9


- 2. REFER TO ARCHITECTURAL, STRUCTURAL, MECHANIC (ED101) DEMOLITION DRAWINGS.
- 3. REMOVE AND DISPOSE OF PAVEMENT TO THE LIMITS NEW WORK.
- 4. ALL PAVEMENT SHALL BE SAWCUT TO ALLOW THE BA PAVEMENT PATCHED AS PER THE SPECIFICATIONS A
- 5. REMOVE AND DISPOSE OF CONCRETE SIDEWALKS TO WORK.
- 6. PROTECT TREES TO REMAIN WITHIN THE LIMIT OF WC
- 7. PROTECT EXISTING UTILITIES IN PLACE. IF CONFLICT AN ALTERNATE SOLUTION.
- 8. SOIL MAY BE STOCKPILED FOR FUTURE RE-USE AS B BE REMOVED AND DISPOSED.
- 9. REMOVE AND DISPOSE OF TOPSOIL.
- 10. REPAIR AFFECTED UTILITIES TO ALLOW FOR CONTINU
- 11. RELOCATE NATURAL GAS PIPELINE PRIOR TO EXCAVA 介(12. PROTECT FIXTURES (I.E. EXISTING LIGHT POLES, FIRE PLACE WITHIN THE LIMIT OF WORK UNLESS NOTED C RESPONSIBLE FOR REPLACEMENT OF FIXTURES SHO CONSTRUCTION.

# **KEY NOTES**

- 1. REMOVE AND DISPOSE OF CONCRETE PAVEMENT.
- 2. REMOVE AND DISPOSE OF CURB.
- 3. REMOVE AND DISPOSE OF CONCRETE PAD.
- 4. REMOVE AND DISPOSE OF TREE.
- ▲ / 5. NOT USED ON THIS SHEET.
  - 6. REMOVE AND DISPOSE STORM INLET AND PIPING. SEE
  - 7. REMOVE AND DISPOSE STEAM PIPELINE. SEE NOTE
  - 8. REMOVE AND DISPOSE WATER PIPELINE. SEE NOTE 1
  - REMOVE SIGN AND RETURN TO OWNER
- REMOVE PARKING LOT LIGHTS AND RETURN TO OWN  $\overline{\phantom{a}}$

EMOLIT	ON PLAN	0	20	50
			SC	ALE: 1" = 2
of ction lities	Drawing Title CIVIL EXISTING CONDITIONS/ DEMOLITION PLAN	Phase 100% CONSTRUCTION DOCUMENT SUBMISSION	Project Title SIOUX FALLS BOILER F	PLANT
nent epartment rans	Approved: Project Director	FULLY SPRINKLERED	Location VAMC-Sioux Falls: 2501 Issue Date 08-09-2024	W 22nd St, S Checked RBB

Γ		
EVIATIONS, AND GENI	ERAL NOTES.	
ICAL (PL101, PL201), A		
S REQUIRED FOR THE	INSTALLATION OF	
ACKFILL TO BE COMP. AND SITE DETAILS.	ACTED AND	
O THE LIMITS REQUIR	ED FOR NEW	
ORK UNLESS NOTED	OTHERWISE.	
r Submit RFI to va co	OR TO DETERMINE	
BACKFILL ONLY. SURF	PLUS SOIL SHALL	
IUED USE. /ATING FOR UNDERGF		
E HYDRANTS, AND SIG	GNS) TO REMAIN IN	
OTHERWISE. THE CON OULD THEY BE DAMAC		
		I
EE NOTE 10.		
10.		
10.		
NER.		
	100	
20'		
	Project Number 438-22-900	
	Building Number 12	
Sioux Falls, SD 57105	Drawing Number	
Drawn EG	2 OF 17	
		l

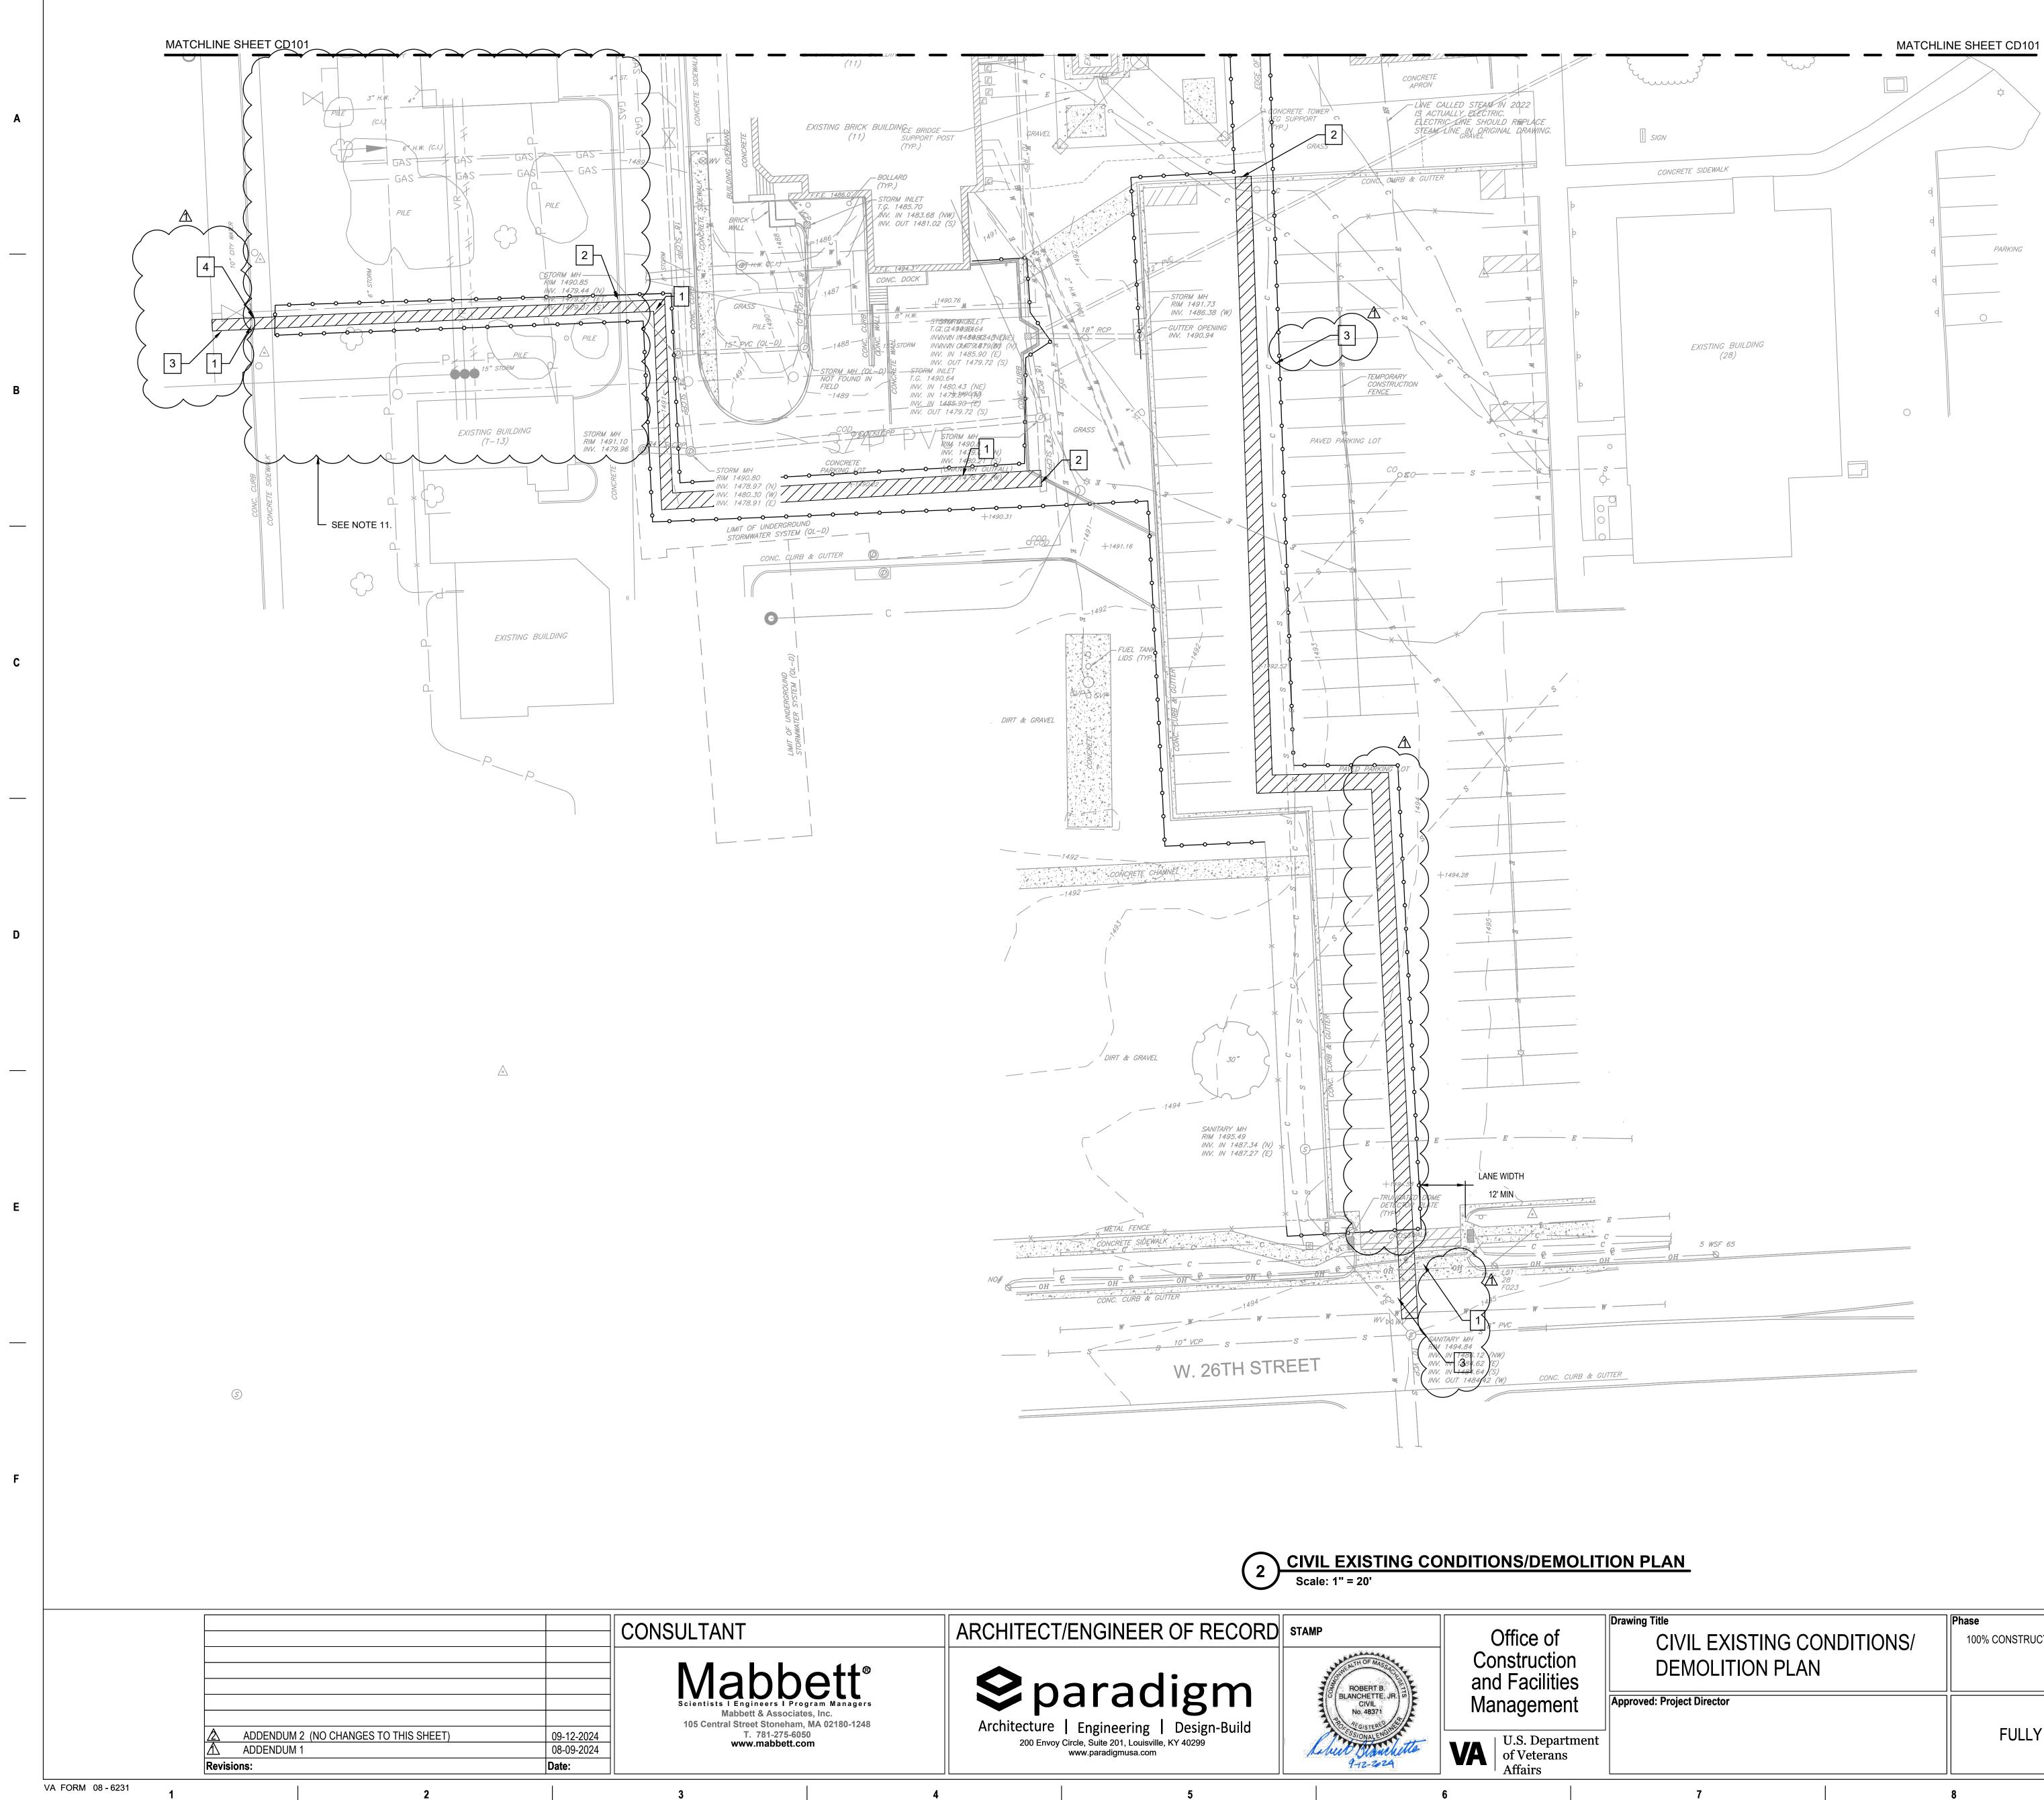

2

3

4

7

9

# NOTES

8


- 1. REFER TO DRAWING C-001 FOR CIVIL LEGEND, ABBRI
- 2. REFER TO ARCHITECTURAL, STRUCTURAL, MECHANI
- 3. REMOVE AND DISPOSE OF PAVEMENT TO THE LIMITS NEW WORK.
- 4. ALL PAVEMENT SHALL BE SAWCUT TO ALLOW THE BA PAVEMENT PATCHED AS PER THE SPECIFICATIONS
- 5. REMOVE AND DISPOSE OF CONCRETE SIDEWALKS T WORK.
- 6. PROTECT TREES IN THE VICINITY OF THE LIMITS OF
- 7. PROTECT EXISTING UTILITIES IN PLACE. IF CONFLICT AN ALTERNATE SOLUTION.
- 8. SOIL MAY BE STOCKPILED FOR FUTURE RE-USE AS B BE REMOVED AND DISPOSED.
- 9. REMOVE AND DISPOSE OF TOPSOIL
- 10. CONTRACTOR SHALL COMPLY WITH CITY OF SIOUX I STREET OPENING AND SERVICE CONNECTION REQUI
- 11. UTILITY LOCATIONS WITHIN THIS LOCATION ARE APP REFERENCE DOCUMENTS. CONTRACTOR TO VERIFY  $\checkmark \checkmark \checkmark \checkmark \checkmark \checkmark \checkmark$ 12. PROTECT FIXTURES (I.E. EXISTING LIGHT POLES, FIR PLACE WITHIN THE LIMIT OF WORK UNLESS NOTED RESPONSIBLE FOR REPLACEMENT OF FIXTURES SHO CONSTRUCTION.

# **KEY NOTES**

- 1. REMOVE AND DISPOSE OF CONCRETE PAVEMENT.
- 2. REMOVE AND DISPOSE OF CURB.
- 3. REMOVE AND DISPOSE OF ASPHALT PAVEMENT.
- 4. REMOVE AND DISPOSE SIDEWALK.


<u>EMOLITI</u>	<u>ON PLAN</u>	0	20	50
			SC	ALE: 1" = 2
of ction lities	Drawing Title CIVIL EXISTING CONDITIONS/ DEMOLITION PLAN	Phase 100% CONSTRUCTION DOCUMENT SUBMISSION	Project Title SIOUX FALLS BOILER P	PLANT
nent epartment rans	Approved: Project Director	FULLY SPRINKLERED	Location VAMC-Sioux Falls: 2501 Issue Date 08-09-2024	W 22nd St, S Checked RBB
	7	8	9	

	<b>A</b>
G C-001 FOR CIVIL LEGEND, ABBREVIATIONS, AND GENERAL NOTES. ECTURAL, STRUCTURAL, MECHANICAL AND ELECTRICAL DRAWINGS. OSE OF PAVEMENT TO THE LIMITS REQUIRED FOR THE INSTALLATION OF	В
ALL BE SAWCUT TO ALLOW THE BACKFILL TO BE COMPACTED AND ED AS PER THE SPECIFICATIONS AND SITE DETAILS. OSE OF CONCRETE SIDEWALKS TO THE LIMITS REQUIRED FOR NEW	
N THE VICINITY OF THE LIMITS OF WORK UNLESS NOTED OTHERWISE. G UTILITIES IN PLACE. IF CONFLICT SUBMIT RFI TO VA COR TO DETERMINE LUTION. KPILED FOR FUTURE RE-USE AS BACKFILL ONLY. SURPLUS SOIL SHALL DISPOSED. OSE OF TOPSOIL.	С
LL COMPLY WITH CITY OF SIOUX FALLS DEPARTMENT OF PUBLIC WORKS AND SERVICE CONNECTION REQUIREMENTS. S WITHIN THIS LOCATION ARE APPROXIMATE FROM VA PROVIDED MENTS. CONTRACTOR TO VERIFY ALL UTILITIES IN FIELD. S (I.E. EXISTING LIGHT POLES, FIRE HYDRANTS, AND SIGNS) TO REMAIN IN LIMIT OF WORK UNLESS NOTED OTHERWISE. THE CONTRACTOR IS REPLACEMENT OF FIXTURES SHOULD THEY BE DAMAGED DURING	
	D
OSE OF CONCRETE PAVEMENT. OSE OF ASPHALT PAVEMENT. OSE SIDEWALK.	
	E
	F
20 50 100 SCALE: 1" = 20'  roject Title SIOUX FALLS BOILER PLANT  Project Number 438-22-900  Building Number 12	
ocation     12       vAMC-Sioux Falls: 2501 W 22nd St, Sioux Falls, SD 57105     Drawing Number       ssue Date     Checked       8-09-2024     RBB       9     10	

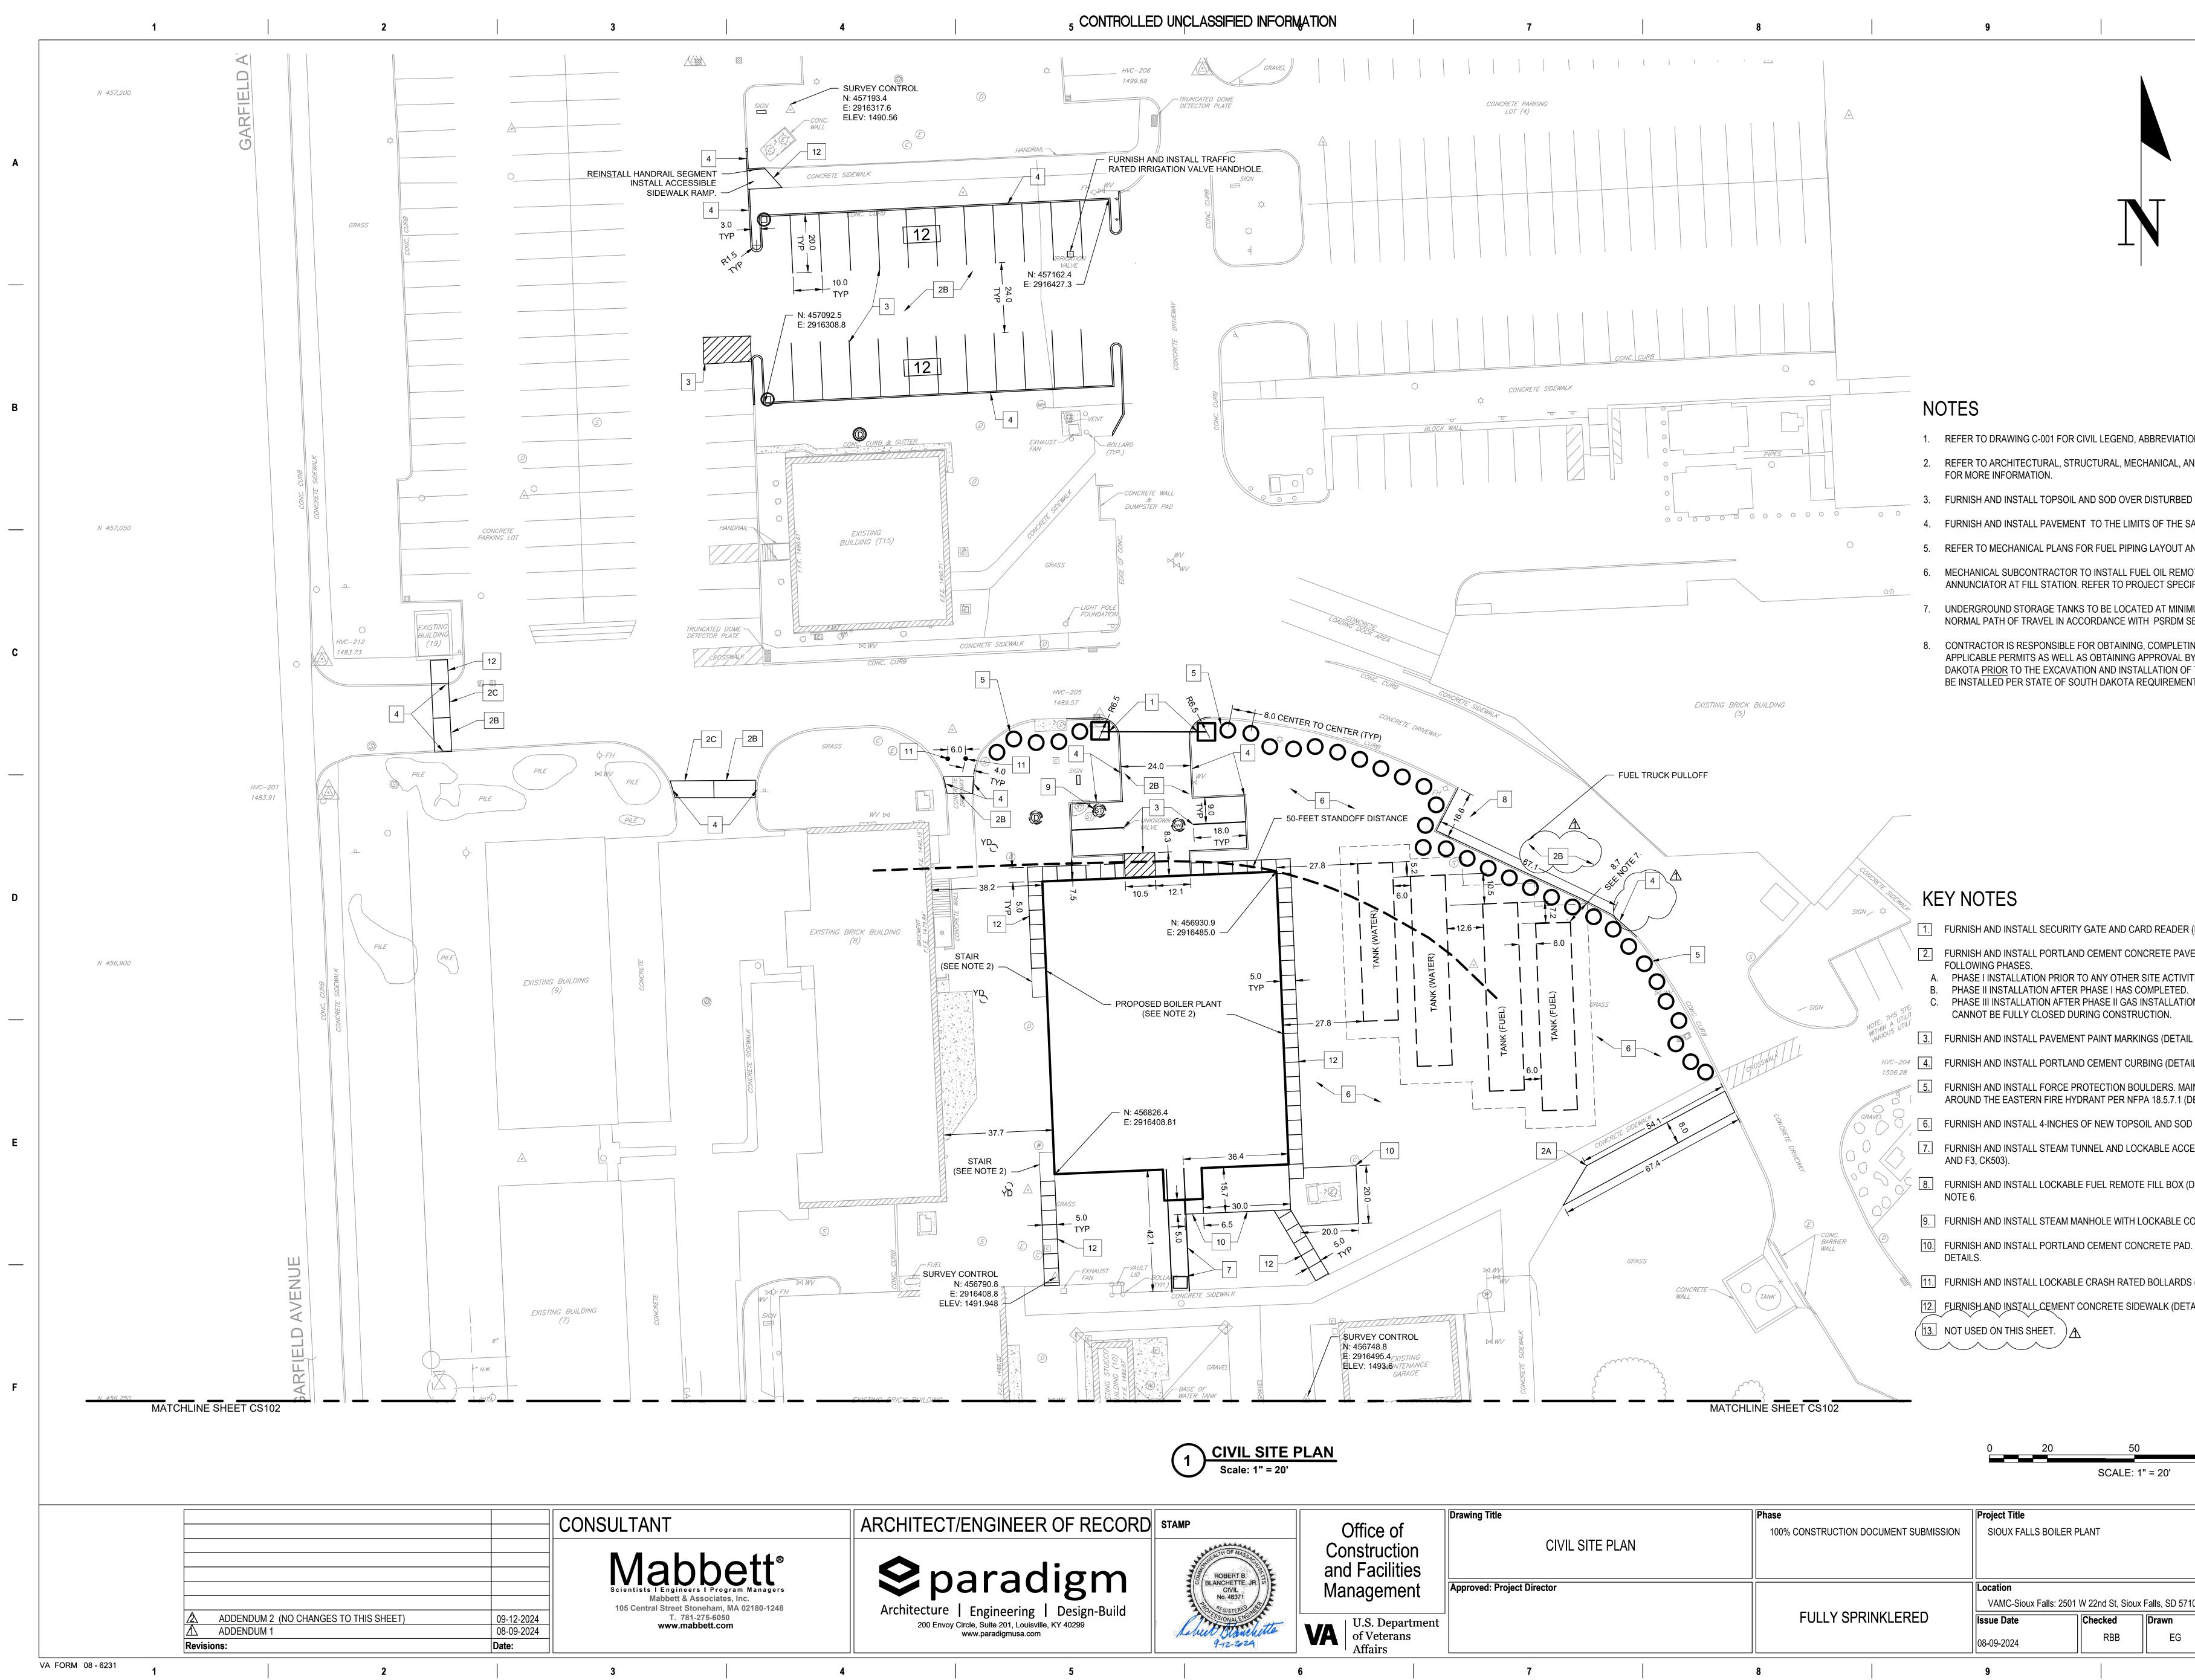

	9			10	1
					A
NC	DTES				В
1. 2. ○ ○ ○ ○ 3. 4.	REFER TO DRAWING C-00 REFER TO ARCHITECTUR/ FOR MORE INFORMATION FURNISH AND INSTALL TO FURNISH AND INSTALL PA REFER TO MECHANICAL P	AL, STRUCTURAL, MEC PSOIL AND SOD OVER	HANICAL, AND EI DISTURBED LAW S OF THE SAW C	LECTRICAL DRAWINGS /N AREAS. CUT OR AS NEEDED.	
	MECHANICAL SUBCONTRA				
<u> </u>	UNDERGROUND STORAGE	E TANKS TO BE LOCATE	ED AT MINIMUM 8	3.5-FEET FROM	
8.	NORMAL PATH OF TRAVEI CONTRACTOR IS RESPON APPLICABLE PERMITS AS DAKOTA <u>PRIOR</u> TO THE EX BE INSTALLED PER STATE	ISIBLE FOR OBTAINING WELL AS OBTAINING A XCAVATION AND INSTA	, COMPLETING, A PPROVAL BY TH LLATION OF TAN	AND SUBMITTING E STATE OF SOUTH	с
OOMORE IT					
sign to the KE	Y NOTES				D
2.	FURNISH AND INSTALL SE FURNISH AND INSTALL PO FOLLOWING PHASES. PHASE I INSTALLATION F PHASE II INSTALLATION PHASE III INSTALLATION CANNOT BE FULLY CLOS	ORTLAND CEMENT CON PRIOR TO ANY OTHER S AFTER PHASE I HAS CO I AFTER PHASE II GAS II	CRETE PAVEMEN SITE ACTIVITIES OMPLETED. NSTALLATION HA	NT (DETAIL D1, CK501) IN THE COMMENCING.	
WITHIN & UTICA WITHIN & UTICA VARIOUS 3.	FURNISH AND INSTALL PA	VEMENT PAINT MARKIN	NGS (DETAIL D3,	CK501).	
1506.28	FURNISH AND INSTALL PO				
GRAVEL	AROUND THE EASTERN FI	IRE HYDRANT PER NFP	A 18.5.7.1 (DETAI		
7.	FURNISH AND INSTALL ST			HATCH (DETAILS E4,CK501	E
8.	AND F3, CK503). FURNISH AND INSTALL LO	CKABLE FUEL REMOTE	E FILL BOX (DETA	IL F7, CK501). REFER TO	
	NOTE 6. FURNISH AND INSTALL ST	EAM MANHOLE WITH L	OCKABLE COVEF	R (DETAIL F1, CK503).	
	FURNISH AND INSTALL PO DETAILS.	ORTLAND CEMENT CON	CRETE PAD. REF	ER TO STRUCTURAL	
,	FURNISH AND INSTALL LO				
	FURNISH AND INSTALL CE	$\mathbf{i}$	WALK (DETAIL B	1, CK501).	
S102					F
5102					
	0 20	0 50 SCALE: 1	" = 20'	100	
	Draiget Title			Dreiset Number	
TRUCTION DOCUMENT SUBMISS	SION SIOUX FALLS BO	DILER PLANT		Project Number 438-22-900	
	]			Building Number 12	
LLY SPRINKLERED	Location VAMC-Sioux Falls	s: 2501 W 22nd St, Sioux	Falls, SD 57105	Drawing Number CS101	
	08-09-2024	RBB	EG	4 OF 17	

of tion ties	CIVIL SITE PLAN	100% C	DNSTRUCTION DOCUMENT SUBMISSION	SIOUX FALLS BOILER F	PLANT
nent	Approved: Project Director			Location VAMC-Sioux Falls: 2501	W 22nd St, Si
partment ans				Issue Date	Checked RBB
		•		08-09-2024	

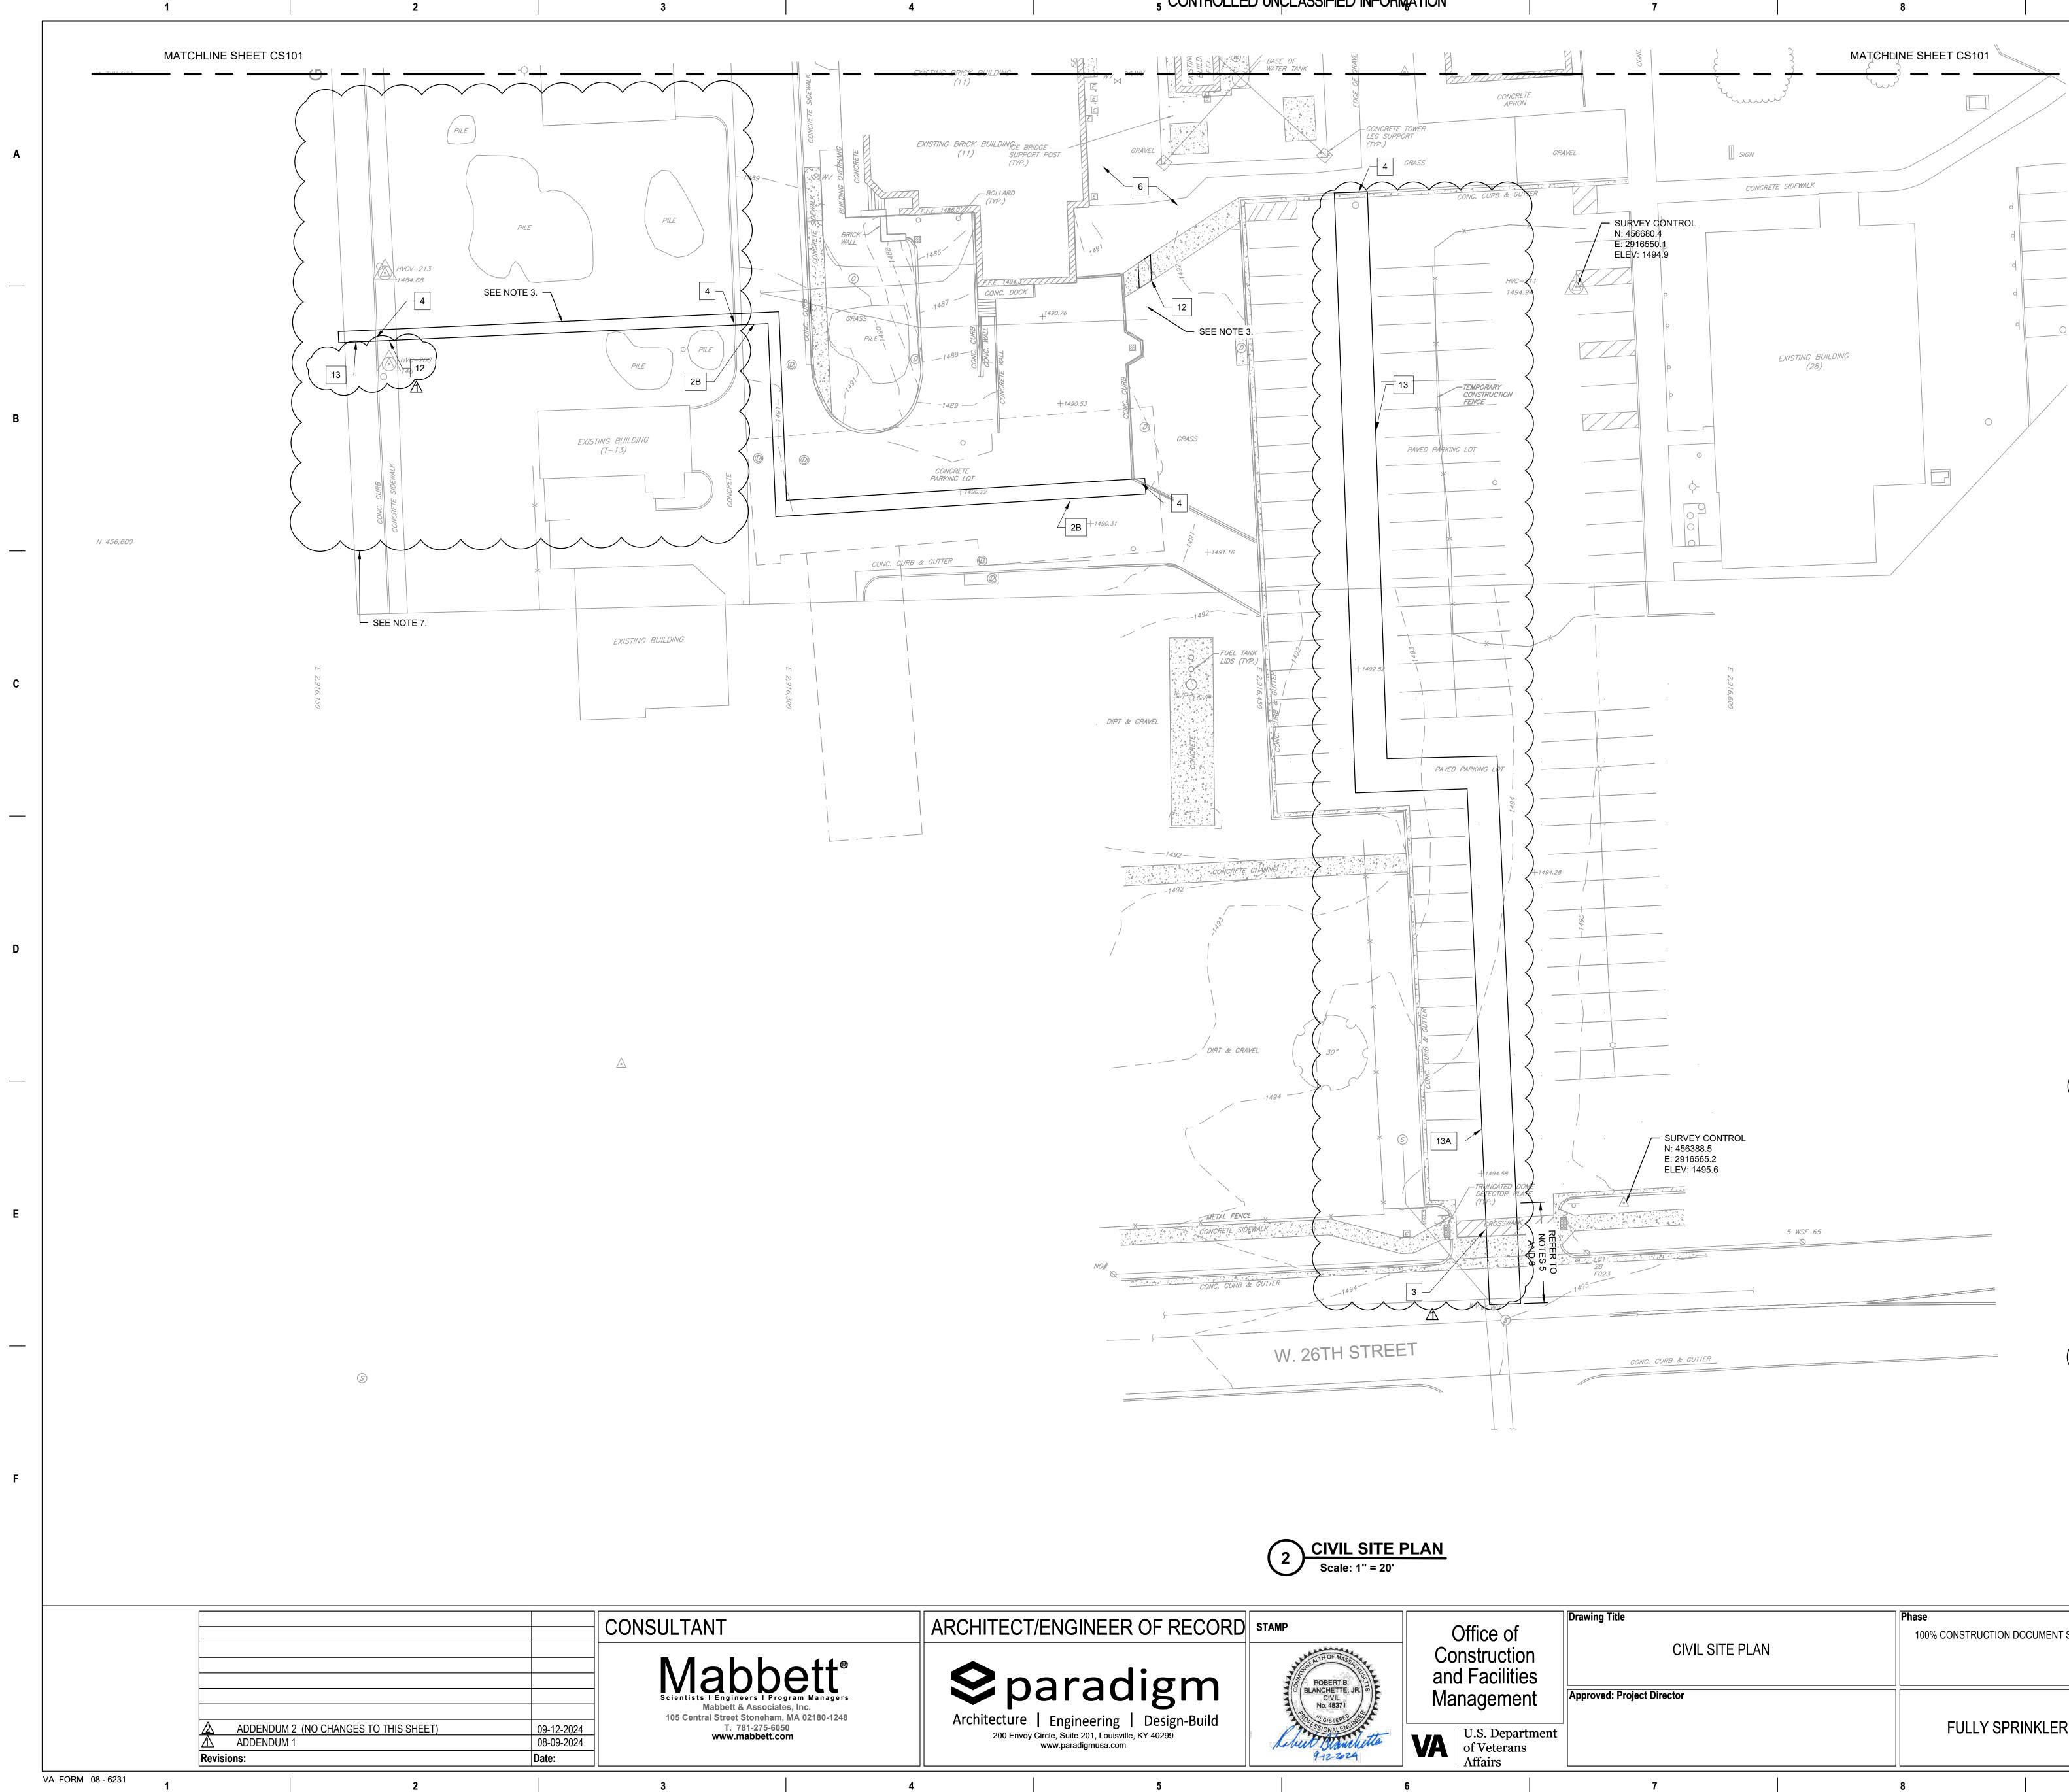

### $_{5}$ CONTROLLED UNCLASSIFIED INFORMATION

CUI

## NOTES

- 1. REFER TO DRAWING C-001 FOR CIVIL LEGEN
- 2. REFER TO ARCHITECTURAL, STRUCTURAL, FOR MORE INFORMATION.
- 3. FURNISH AND INSTALL TOPSOIL AND SOD ( DISTURBED AREAS.
- 5. CONTRACTOR SHALL REPAIR PAVEMENT, WITHIN THE PUBLIC RIGHT OF WAY IN ACCO REGULATIONS.
- 6. CONTRACTOR SHALL PROVIDE TRAFFIC CO SIOUX FALLS REGULATIONS DURING WORK
- 7. UTILITY LOCATIONS WITHIN THIS LOCATION REFERENCE DOCUMENTS. CONTRACTOR


### **KEY NOTES**


1.	NOT USED THIS SHEET.
2. (A. B. C.	PHASE II INSTALLATION AFTER PHASE I HAS
3.	
4.	FURNISH AND INSTALL PORTLAND CEMENT C
5.	NOT USED THIS SHEET.
6.	FURNISH AND INSTALL 4-INCHES OF NEW TOP
7.	NOT USED THIS SHEET.
8.	NOT USED THIS SHEET.
9.	NOT USED THIS SHEET.
10.	NOT USED THIS SHEET.
11.	NOT USED THIS SHEET.
12.	FURNISH AND INSTALL CEMENT CONCRETE S
(1 <u>3</u> . A.	FURNISH AND INSTALL ASPHALT PAVEMENT. PHASE I INSTALLATION PRIOR TO ANY OTHE
$\sim$	

)		20		

	Drawing Title	Phase	Project Title	
of ction lities	CIVIL SITE PLAN	100% CONSTRUCTION DOCUMENT SUBMISSION	ON SIOUX FALLS BOILER PLANT	
nent	Approved: Project Director		Location	
			VAMC-Sioux Falls: 2501	W 22nd St, S
epartment		FULLY SPRINKLERED	Issue Date	Checked
rans			08-09-2024	RBB
	7	8	9	

	9			10	
					<b>A</b>
<ol> <li>REFER FOR M</li> <li>FURNIS DISTUR</li> </ol>	TO DRAWING C-001 FOR TO ARCHITECTURAL, STF ORE INFORMATION. SH AND INSTALL TOPSOIL RBED AREAS.	RUCTURAL, MECH AND SOD OR GR	IANICAL, AND E AVEL AS APPLIC	LECTRICAL DRAWINGS CABLE OVER	В
<ol> <li>CONTE WITHIN REGUL</li> <li>CONTE SIOUX</li> <li>UTILITY</li> </ol>	SH AND INSTALL PAVEMEN RACTOR SHALL REPAIR PA I THE PUBLIC RIGHT OF W ATIONS. RACTOR SHALL PROVIDE T FALLS REGULATIONS DUP Y LOCATIONS WITHIN THIS ENCE DOCUMENTS. CONT	VEMENT, SIDEW AY IN ACCORDAN RAFFIC CONTRO RING WORK WITH LOCATION ARE	ALKS, AND PAVI NCE WITH CITY DL IN ACCORDAI IIN THE PUBLIC APPROXIMATE	EMENT PAINT MARKING OF SIOUX FALLS NCE WITH CITY OF RIGHT OF WAY. FROM VA PROVIDED	C
KEY N	OTES				
2. FURNIS FOLO A. NOT B. PHAS C. PHAS CANI 3. FURNIS 4. FURNIS 5. NOT US	WING PHASES: USED ON THIS SHEET. SE II INSTALLATION AFTER SE III INSTALLATION AFTER NOT BE FULLY CLOSED DU ISH AND INSTALL PAVEME SH AND INSTALL PORTLAN SED THIS SHEET.	A PHASE I HAS CO R PHASE II GAS IN JRING CONSTRUC INT PAINT MARKIN ID CEMENT CURE	OMPLETED. ISTALLATION HA CTION. NGS (DETAIL D3 BING (DETAIL E1	А, СК501).	
8.         NOT US           9.         NOT US           10.         NOT US           11.         NOT US           12.         FURNIS           13.         FURNIS	SED THIS SHEET. SED THIS SHEET. SED THIS SHEET. SED THIS SHEET. SED THIS SHEET. SH AND INSTALL CEMENT SH AND INSTALL ASPHALT SE I INSTALLATION PRIOR	° Pavement.			E
	0 20	50 SCALE: 1"	= 20'	100	F
SUBMISSION	<b>Project Title</b> SIOUX FALLS BOILER F	PLANT		Project Number 438-22-900 Building Number 12	
ED	Location VAMC-Sioux Falls: 2501 Issue Date 08-09-2024		Falls, SD 57105 <b>Drawn</b> EG	Drawing Number CS102 5 OF 17	

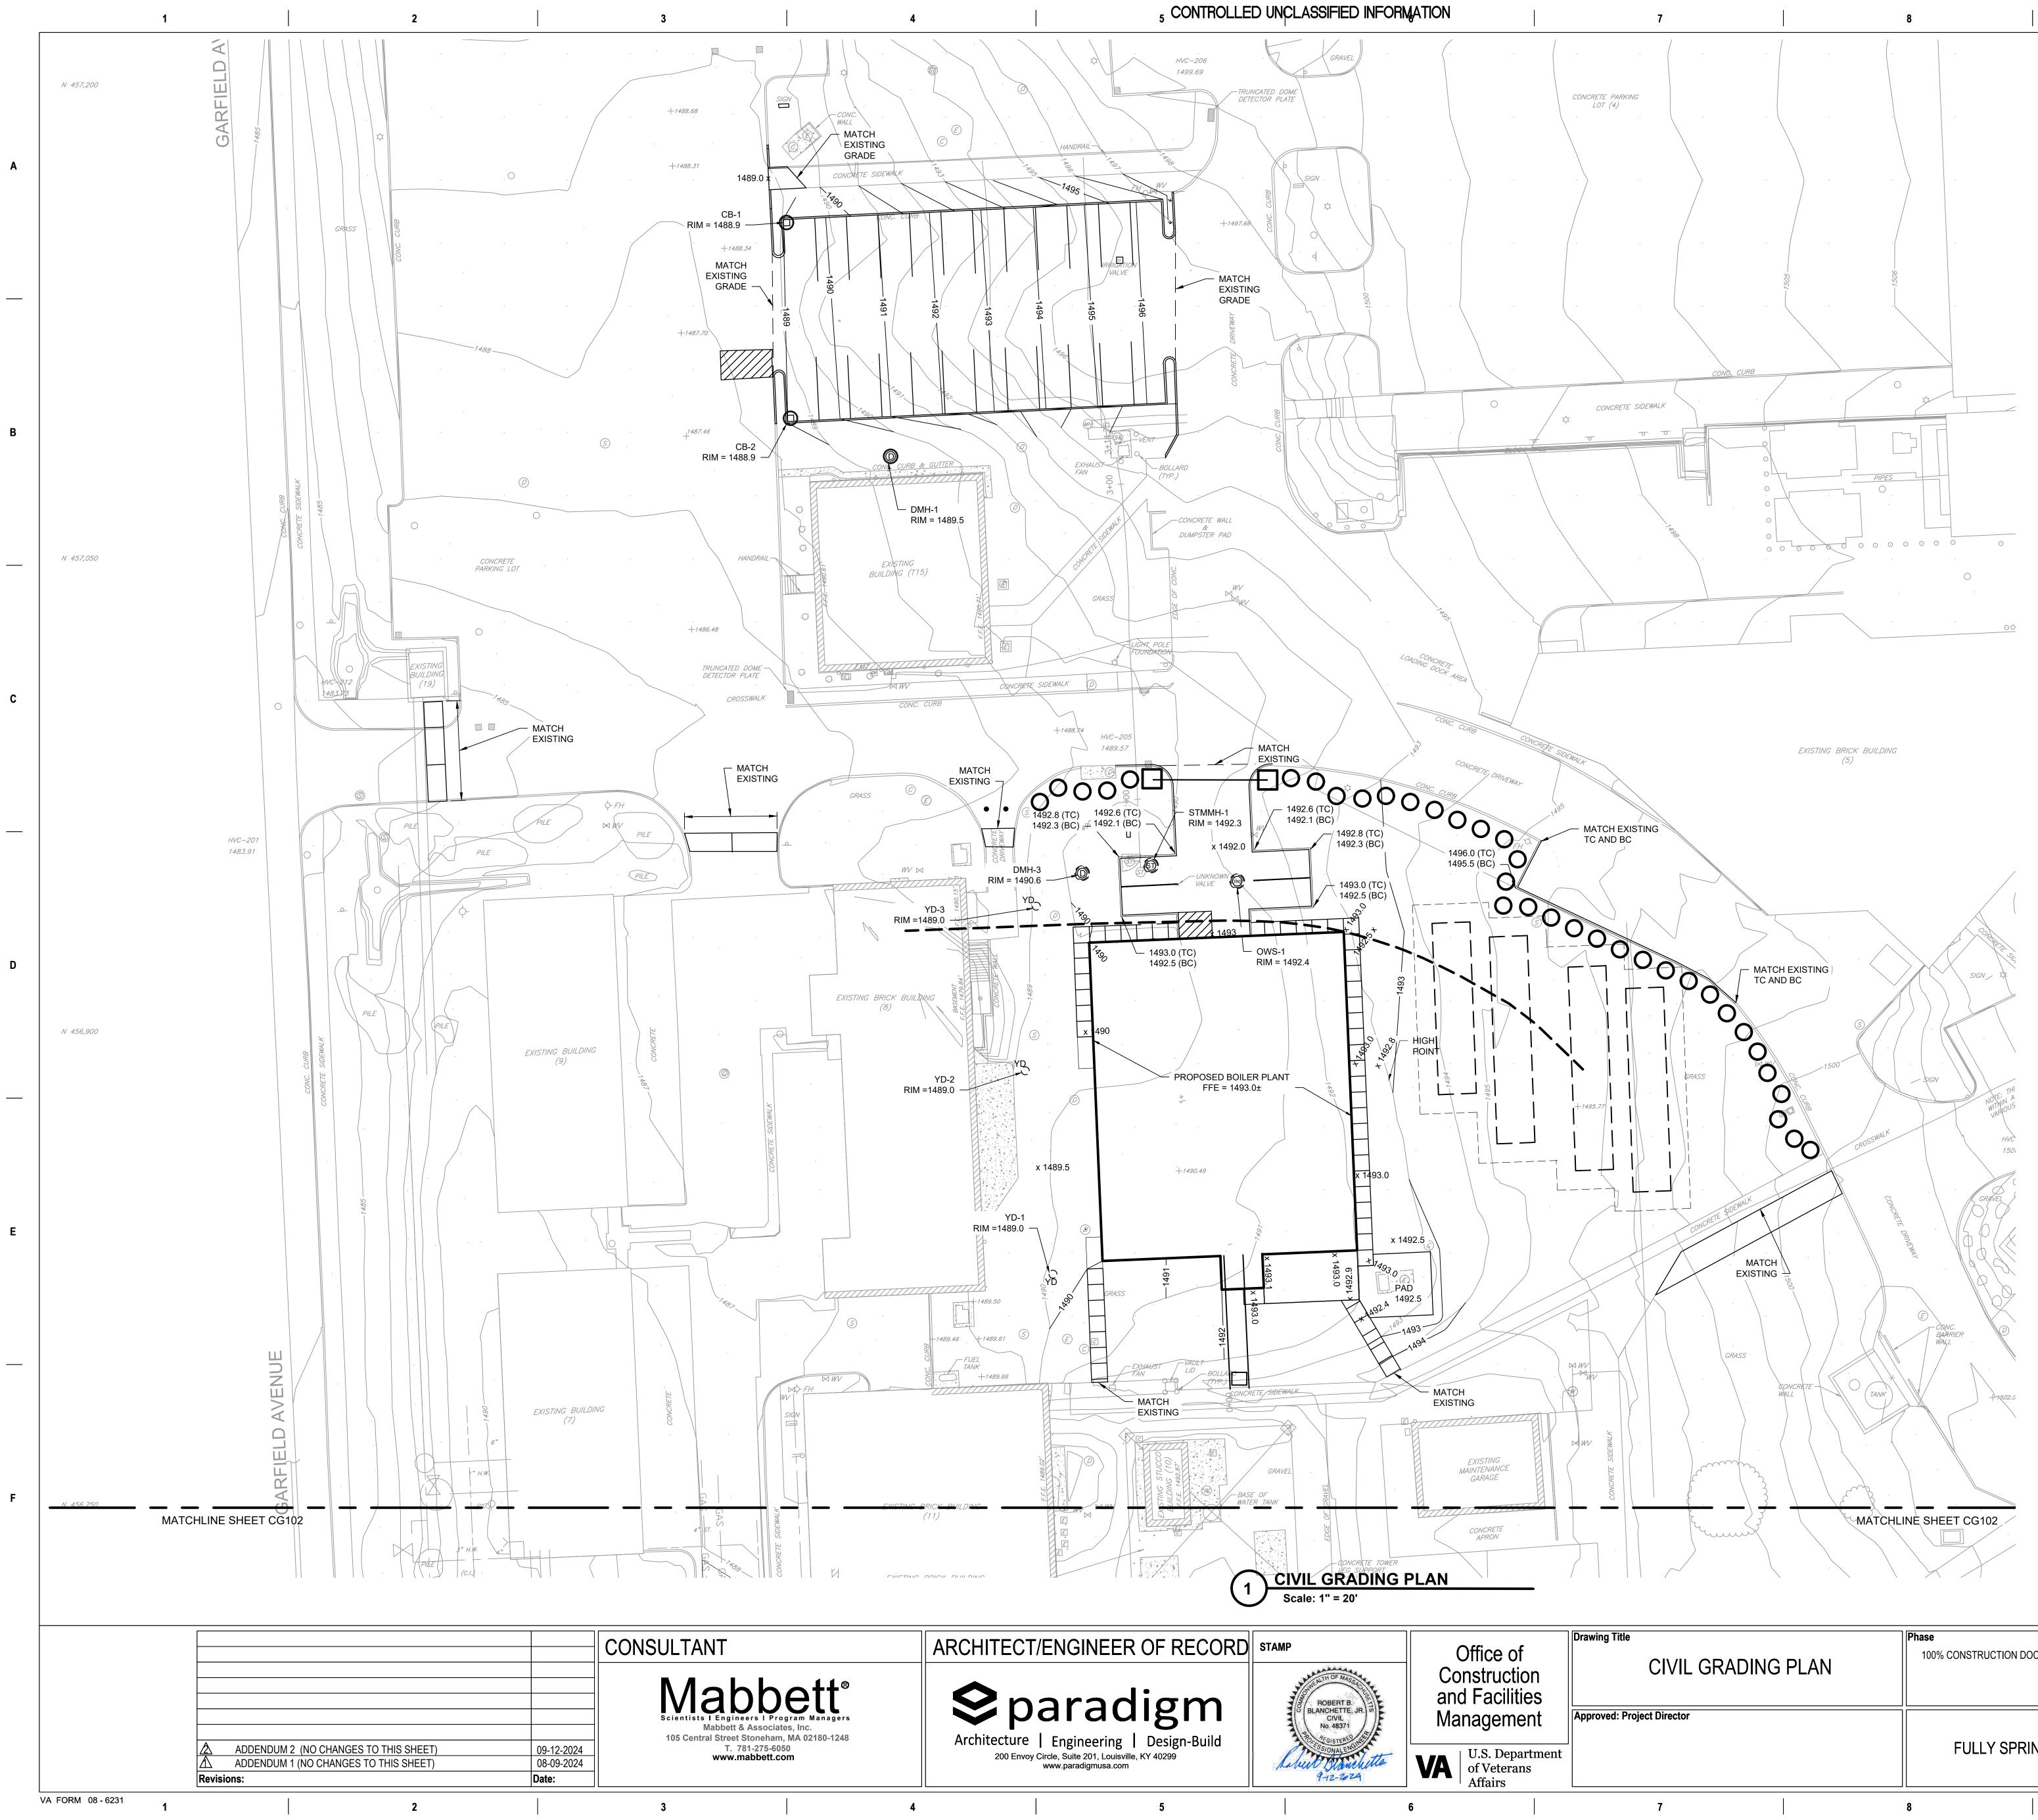

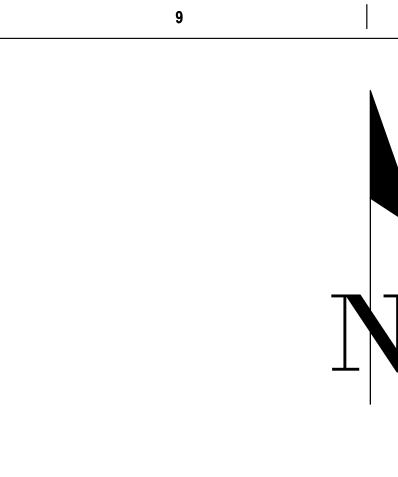

# NOTES


- 1. REFER TO DRAWING C-001 FOR CIVIL LEGEND, ABBREVIATIONS, AND GENERAL NOTES.
- 2. MATCH EXISTING GRADE UNLESS NOTED OTHERWISE.
- 3. MATCH EXISTING GRADE WHERE NEW PAVEMENT MEETS EXISTING.

0 20

9

			SCA	ALE: 1" = 2
_	Drawing Title	Phase	Project Title	
of tion ities	CIVIL GRADING PLAN	100% CONSTRUCTION DOCUMENT SUBMISSION	SIOUX FALLS BOILER P	PLANT
nent	Approved: Project Director		Location VAMC-Sioux Falls: 2501	W 22nd St, S
partment ans		FULLY SPRINKLERED	<b>Issue Date</b> 08-09-2024	Checked RBB
				· <u> </u>

50		100
LE: 1" = 20'		
		Project Number
LANT		438-22-900
		Building Number
		12
		Drawing Number
W 22nd St, Sioux I	Falls, SD 57105	
Checked	Drawn	CG101
RBB	EG	6 OF 17
		10

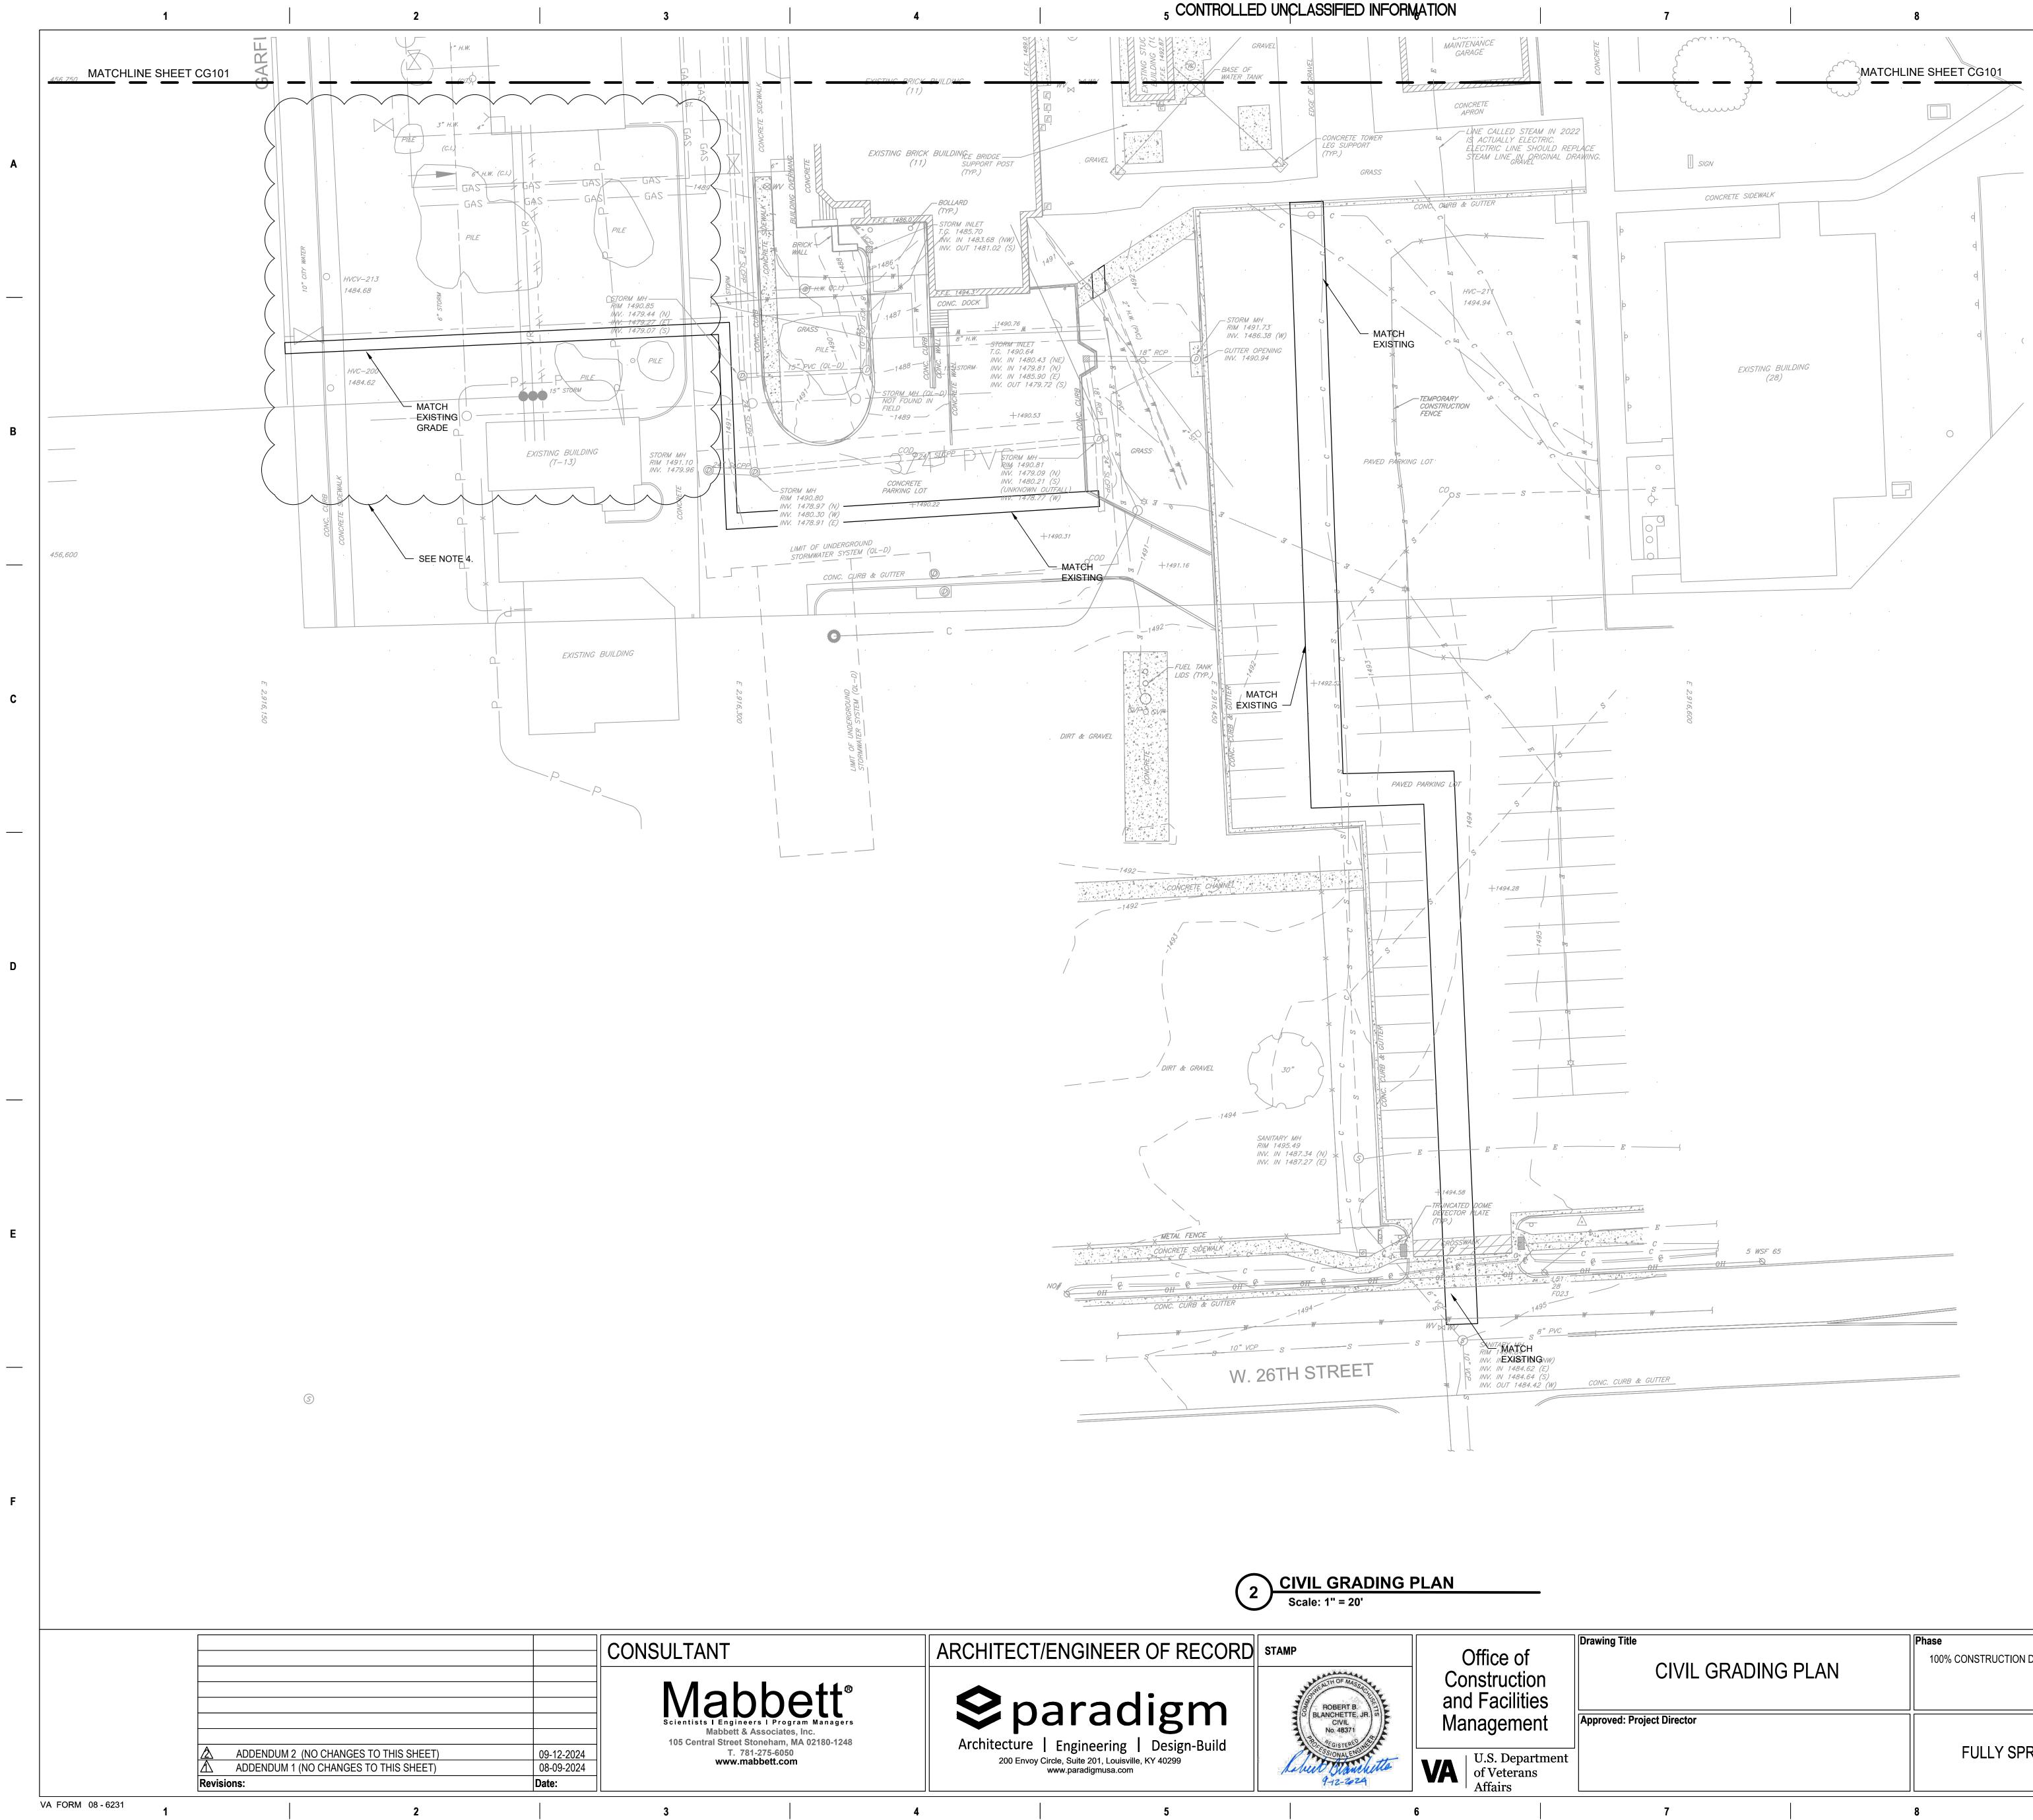





# NOTES

- 1. REFER TO DRAWING C-001 FOR CIVIL LEGEND
- 2. MATCH EXISTING GRADE UNLESS NOTED OTH
- 3. MATCH EXISTING GRADE WHERE NEW PAVEMI
- 4. UTILITY LOCATIONS WITHIN THIS LOCATION AF REFERENCE DOCUMENTS. CONTRACTOR TO \

		0	20	50
			SCA	LE: 1" =
	Drawing Title	Phase	Project Title	
of ction ilities	CIVIL GRADING PLAN	100% CONSTRUCTION DOCUMENT SUBMISSION	SIOUX FALLS BOILER P	LANT
ment	Approved: Project Director		Location VAMC-Sioux Falls: 2501 V	W 22nd St,
epartment		FULLY SPRINKLERED	Issue Date	Checked
erans			08-09-2024	RBB
	7	8	9	

-
, ABBREVIATIONS, AND GENERAL NOTES.
IERWISE.
IENT MEETS EXISTING.
RE APPROXIMATE FROM VA PROVIDED VERIFY ALL UTILITIES IN FIELD.

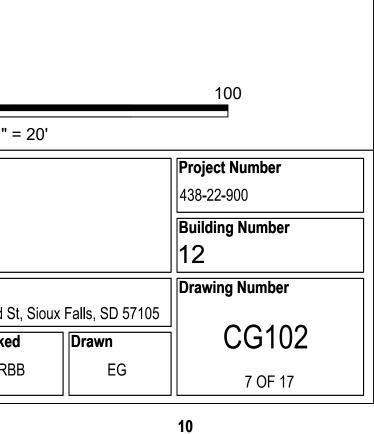

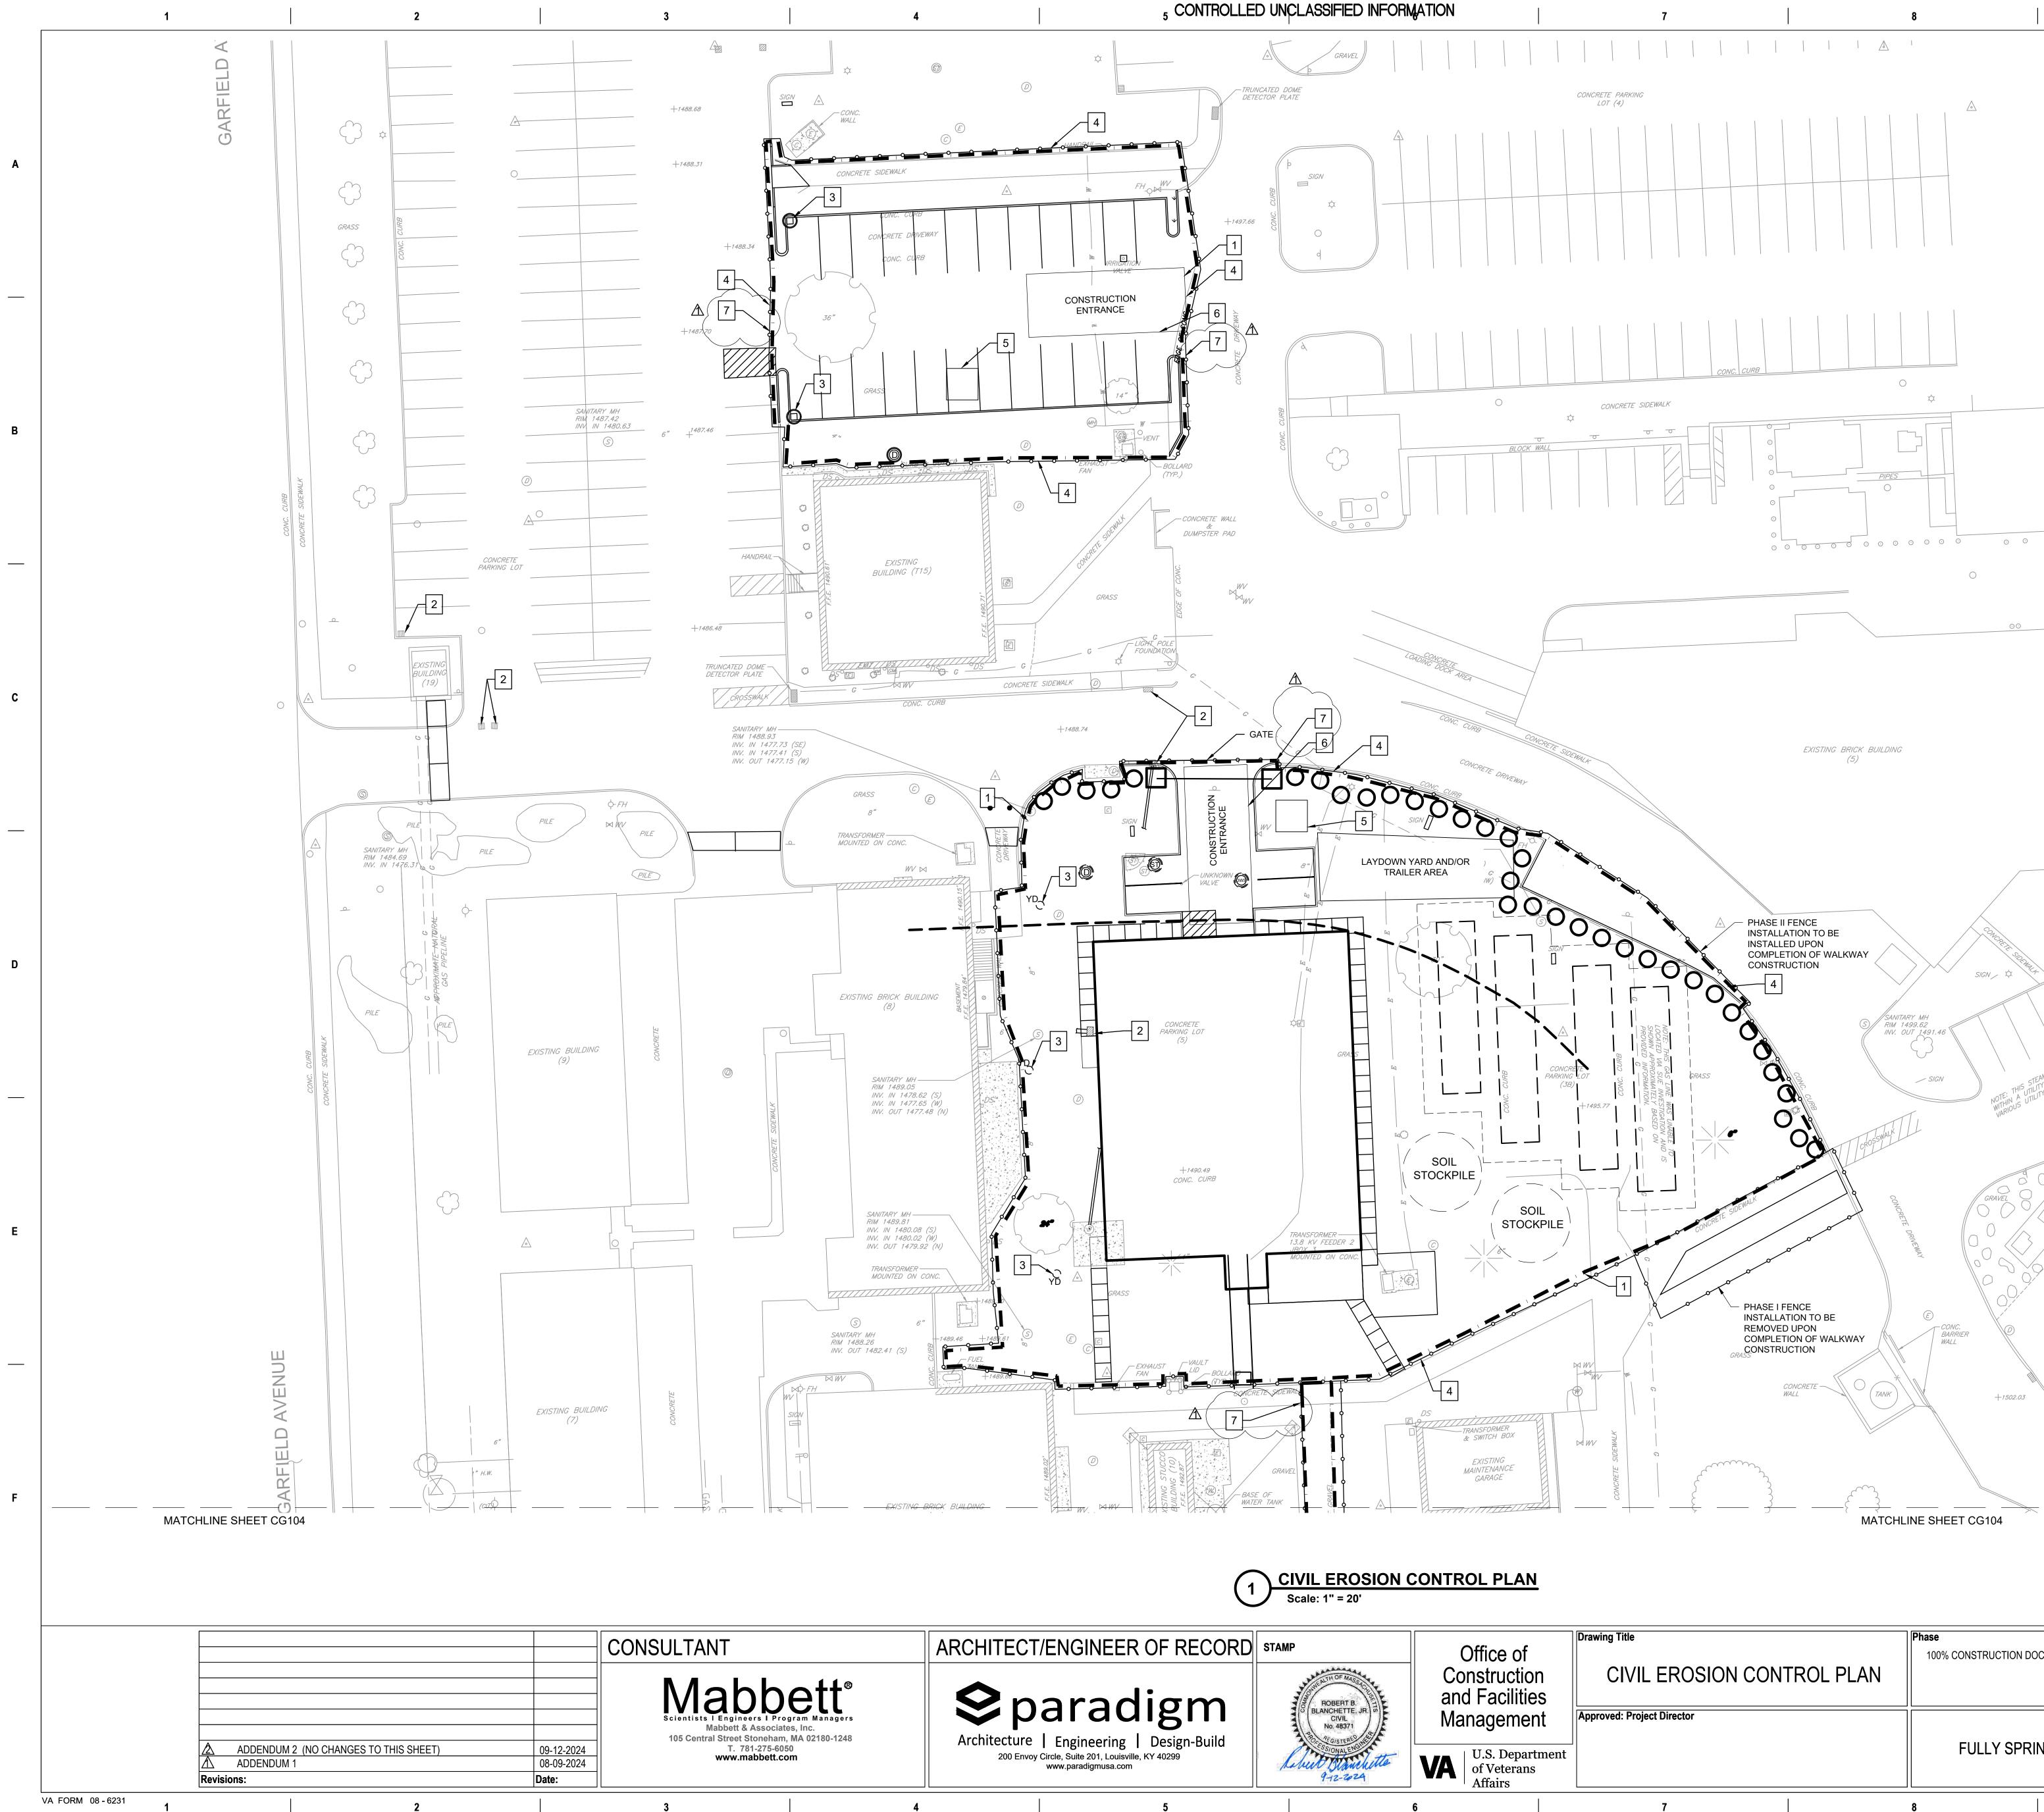

# NOTES

1. REFER TO DRAWING C-001 FOR CIVIL LEGEND, ABE

9


- 2. SURPLUS SOIL SHALL BE HAULED OFFSITE AND DIS
- FEDERAL, STATE, AND LOCAL REQUIREMENTS. SOIL THAT IS TO BE RE-USED MAY BE STORED ONS TARPAULINS TO PREVENT EROSION.
- 4. EROSION CONTROL MAY BE REMOVED ONCE A MO AND PAVEMENT HAS BEEN INSTALLED.
- THE CONTRACTOR SHALL DISCHARGE NO WASTE PROPERTY DUE TO WASHING OF CONCRETE CON UTILIZE THE METHODS PROVIDED BY THE EPA TO PROPER DISPOSAL OR REUSE. THE CONTRACTOR CONCRETE WASHOUT IS REMOVED AND SURREND CITY OF SIOUX FALLS APPROVED WASTE CONCRE
- 4. THE CONTRACTOR SHALL STAGE ALL MATERIALS A FOOTPRINT OF THE PROJECT. THE CONTRACTOR PRACTICES WITHIN THE STAGING AREA AT ALL TIN
- 5. THE CONTRACTOR SHALL COLLECT ALL DEBRIS W CONSTRUCTION SITE AT THE END OF EACH SHIFT. STORED IN CLOSED CONTAINERS AND REMOVED MEDICAL CENTER GROUNDS OR AESTHETICS. THE WITHIN THE CONFINES OF THE CONSTRUCTION SI
- THE CONTRACTOR SHALL PROVIDE TO THE STATE AGRICULTURE AND NATURAL RESOURCES AIR QU INFORMATION. (MAKE, MODEL, SERIAL NUMBER, F
- 7. THE CONTRACTOR SHALL COMPLY WITH THE CITY REQUIREMENTS WITHIN THE CONSTRUCTION SITE
- EROSION CONTROLS ARE TO BE INSPECTED AND I FORMS WITHIN 24 HOURS OF A RAIN EVENT GREAT WEEKLY. FAILED EROSION CONTROL MEASURES POSSIBLE BUT NO LATER THAN 7 DAYS OF IDENTIF
- TRACK PAD CONSTRUCTION ENTRANCE TO BE VIS BE CLEANED (BRUSHED , EITHER MANUALLY OR MI FILLED WITH SEDIMENT, AT MINIMUM EVERY TWO

# **KEY NOTES**

- 1. FURNISH AND INSTALL EROSION CONTROL (DETAIL 2. FURNISH AND INSTALL INLET PROTECTION FOR EX
- D7 AND D9, CK501). 3. FURNISH AND INSTALL INLET PROTECTION AT THE
- DRAINS WHILE CONSTRUCTION CONTINUES (DETA
- ( 4.) FURNISH AND INSTALL DRIVEN POST CONSTRUCTION 5. FURNISH AND INSTALL CONCRETE WASHOUT STAT
- 6. FURNISH AND INSTALL TRACK PAD CONSTRUCTION
- 7. FURNISH AND INSTALL CONSTRUCTION AND SAFET
- $\nearrow$

		0	20	50		100
			SC	CALE: 1" = 20'		
	Drawing Title	Phase	Project Title			Project Numb
of		100% CONSTRUCTION DOCUMENT SUBMISSION	SIOUX FALLS BOILER	PLANT		438-22-900
tion	CIVIL EROSION CONTROL PLAN					Building Num
ities						12
nent	Approved: Project Director		Location			Drawing Num
			VAMC-Sioux Falls: 2501	W 22nd St, Sioux	Falls, SD 57105	
partment		FULLY SPRINKLERED	Issue Date	Checked	Drawn	G CG1
rans			08-09-2024	RBB	EG	8 O
	7	8	9			10

10	
	Α
BREVIATIONS, AND GENERAL NOTES. ISPOSED OF IN ACCORDANCE WITH	В
OWABLE STAND OF GRASS HAS GROWN OR SURPLUS CONCRETE ONTO THE VA ITAINERS. THE CONTRACTOR SHALL CONTAIN CONCRETE WASHOUT FOR R SHALL ENSURE THE COLLECTED DERED TO A STATE OF SOUTH DAKOTA OR ETE COLLECTION SITE. AND STOCKPILES WITHIN THE FENCED SHALL MAINTAIN GOOD HOUSEKEEPING MES. WITHIN THE AREA DEFINED AS THE C DEBRIS SHALL BE COLLECTED AND WITHOUT DISTURBING SIOUX FALLS VA E WASTE CONTAINER SHALL BE CONTAINED ITE. TE OF SOUTH DAKOTA DEPARTMENT OF JALITY OFFICE THE APPROPRIATE BOILER	с 
UEL USE, HORSEPOWER) Y OF SIOUX FALLS NUISANCE VEGETATION E. DOCUMENTED VIA SDDOT 298 INSPECTION ATER THAN 0.5 INCHES OR AT MINIMUM SHALL BE REPLACED AS SOON AS FICATION. SUALLY INSPECTED WEEKLY. MATS SHOULD MECHANICALLY) PRIOR TO VOIDS BEING WEEKS AFTER RAIN EVENTS.	D
IL B3, CK501). XISTING STRUCTURES TO REMAIN (DETAILS E TIME OF INSTALLATION OF PROPOSED AILS D7 AND D9, CK501). TION FENCE (DETAIL F4, CK501). TION (DETAIL C1, CK503). IN ENTRANCE (DETAIL B7, CK501). TY SIGNS.	E
100 = 20' Project Number 438-22-900 Building Number 12 Sioux Falls, SD 57105 Drawing Number CG103	F
EG 8 OF 17	

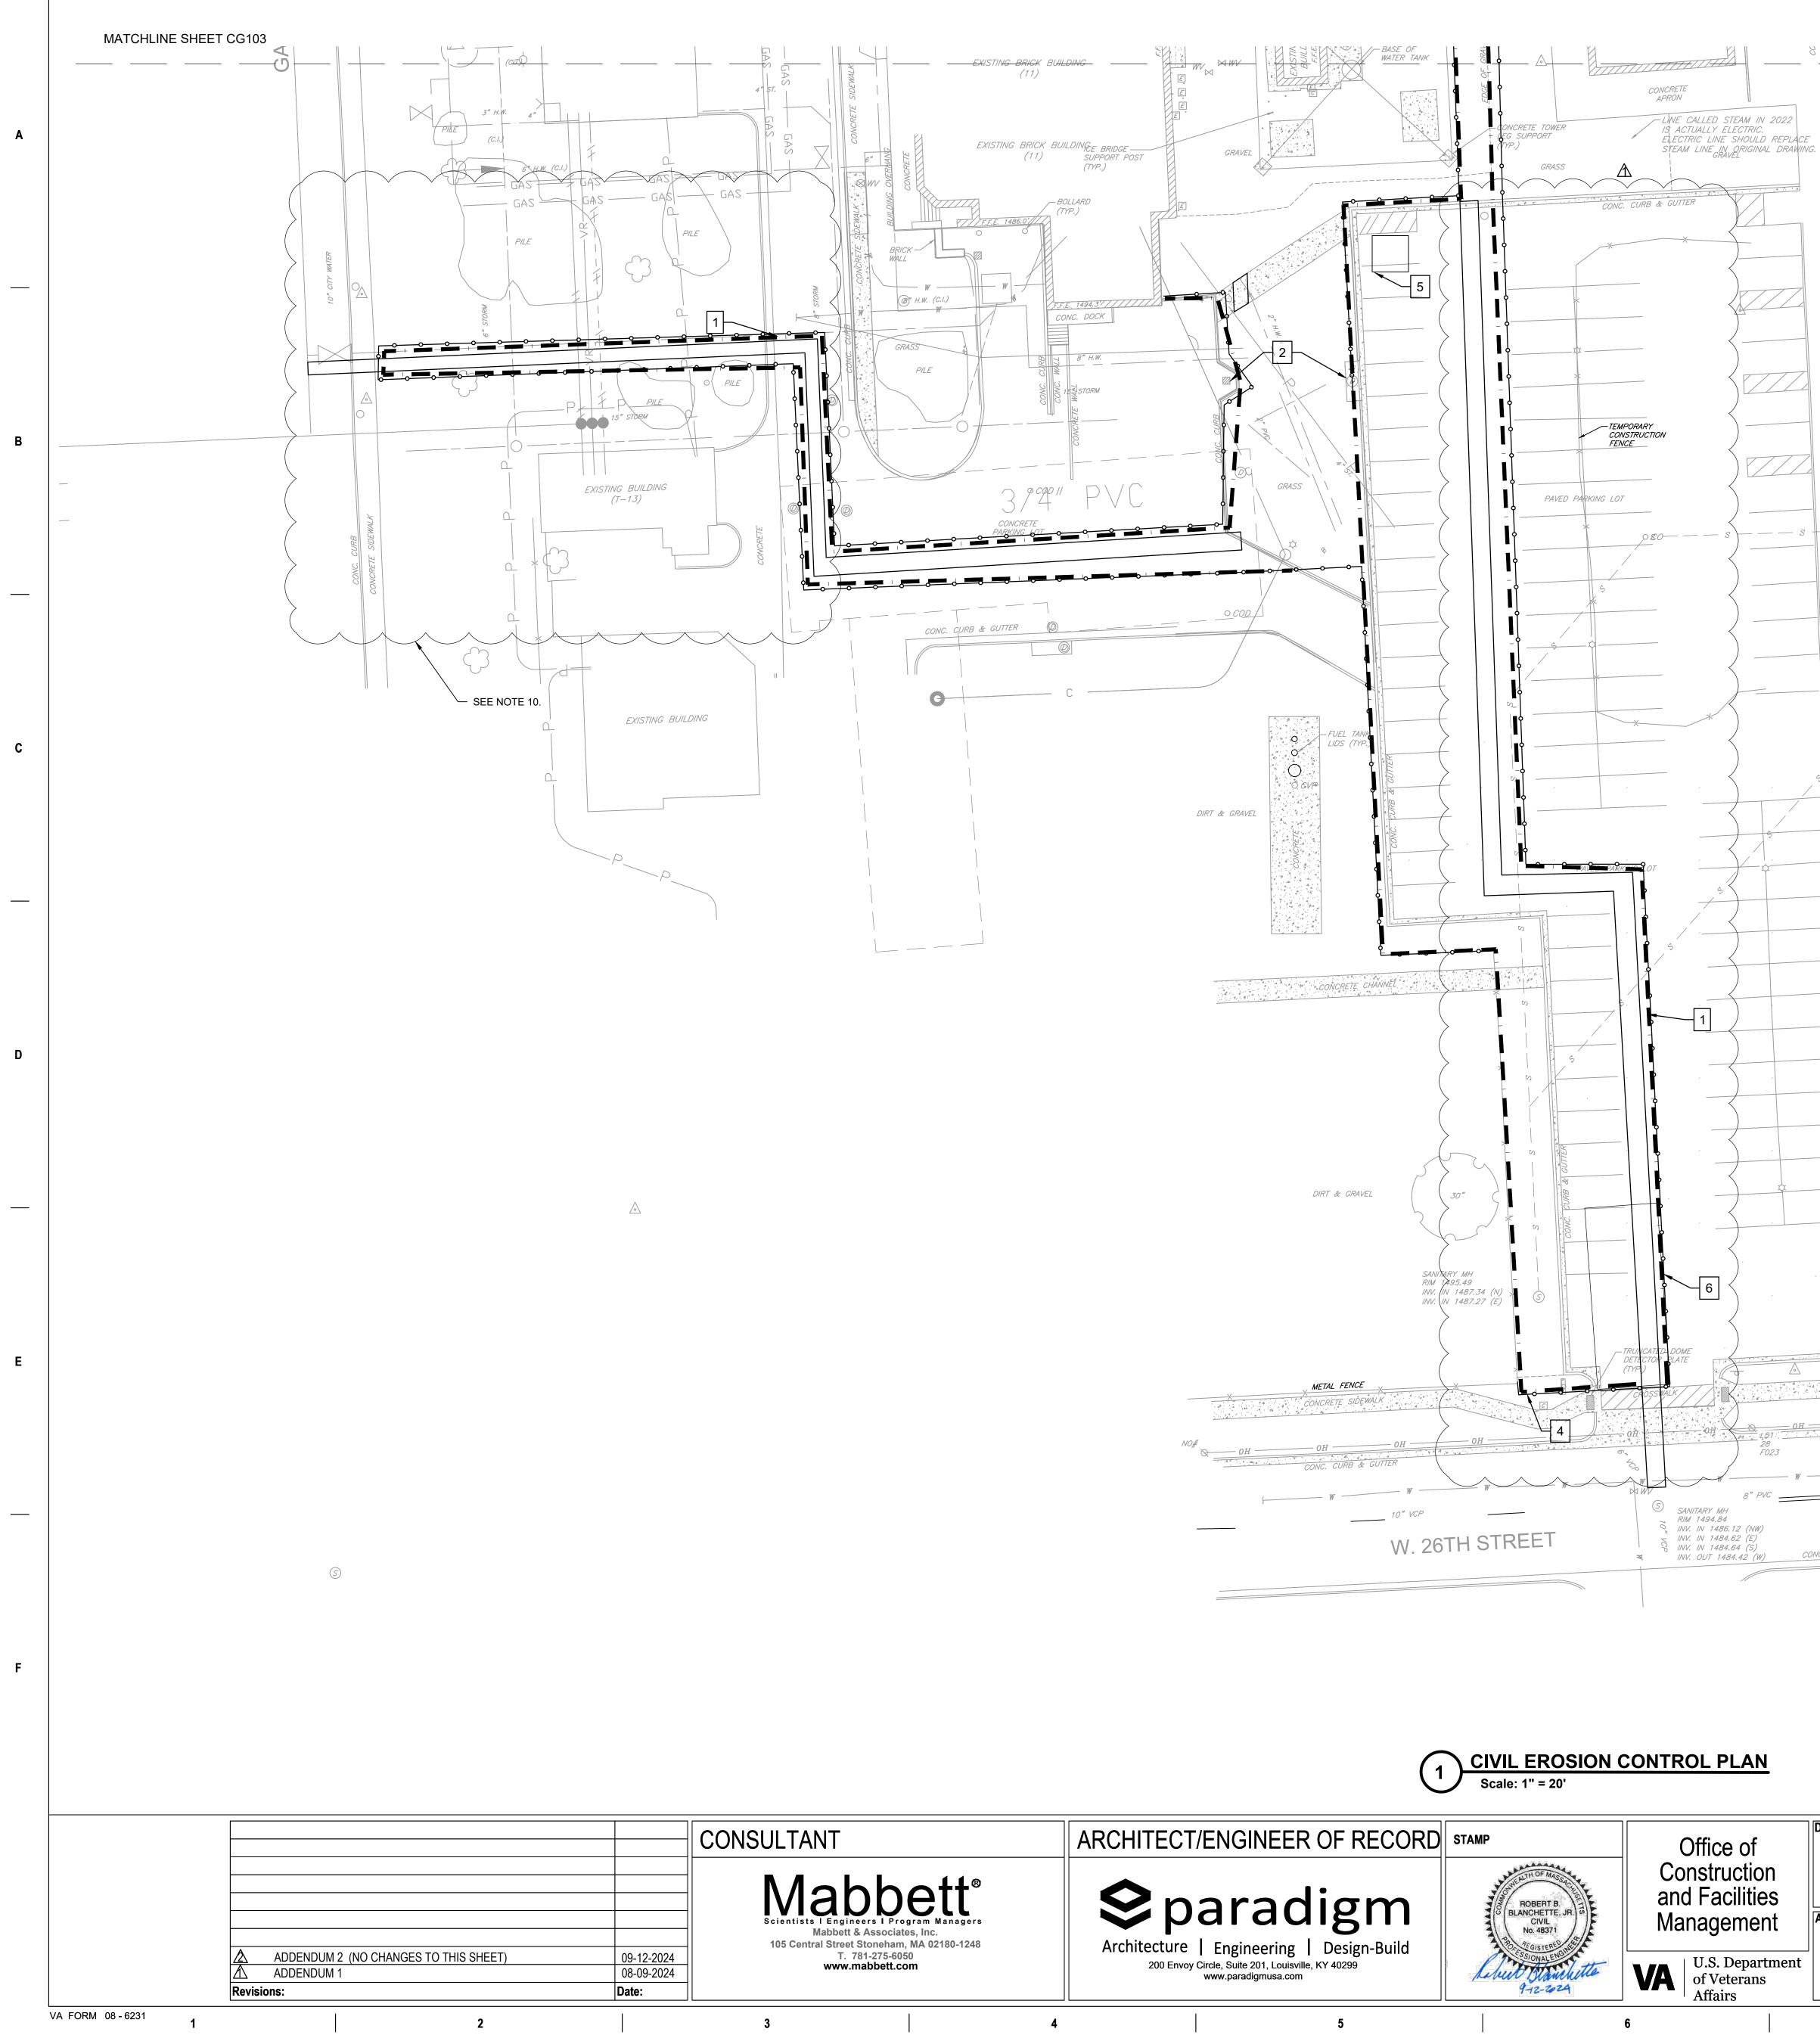

2

3

4

### 5 CONTROLLED UNCLASSIFIED INFORMATION



5

1

\_\_\_\_\_\_ S

\_\_\_\_

7

\_\_\_\_\_

SIGN

CONCRETE SIDEWALK

EXISTING BUILDING

(28)

# 8

MATCHLINE SHEET CG103

 $\bigcirc$ 

\_\_\_\_\_

\_\_\_\_\_\_

PARKING

0



# NOTES

1. REFER TO DRAWING C-001 FOR CIVIL LEGEND, ABE

9


- 2. SURPLUS SOIL SHALL BE HAULED OFFSITE AND D FEDERAL, STATE, AND LOCAL REQUIREMENTS.
- 3. SOIL THAT IS TO BE RE-USED MAY BE STORED ON TARPAULINS TO PREVENT EROSION.
- 4. EROSION CONTROL MAY BE REMOVED ONCE A MO AND PAVEMENT HAS BEEN INSTALLED.
- THE CONTRACTOR SHALL DISCHARGE NO WASTE PROPERTY DUE TO WASHING OF CONCRETE CON UTILIZE THE METHODS PROVIDED BY THE EPA TO PROPER DISPOSAL OR REUSE. THE CONTRACTO CONCRETE WASHOUT IS REMOVED AND SURREN CITY OF SIOUX FALLS APPROVED WASTE CONCRE
- 4. THE CONTRACTOR SHALL STAGE ALL MATERIALS FOOTPRINT OF THE PROJECT. THE CONTRACTOR PRACTICES WITHIN THE STAGING AREA AT ALL TI
- 5. THE CONTRACTOR SHALL COLLECT ALL DEBRIS V CONSTRUCTION SITE AT THE END OF EACH SHIF STORED IN CLOSED CONTAINERS AND REMOVED MEDICAL CENTER GROUNDS OR AESTHETICS. THE WITHIN THE CONFINES OF THE CONSTRUCTION S
- 6. THE CONTRACTOR SHALL PROVIDE TO THE STAT AGRICULTURE AND NATURAL RESOURCES AIR QU INFORMATION. (MAKE, MODEL, SERIAL NUMBER, F
- 7. THE CONTRACTOR SHALL COMPLY WITH THE CITY REQUIREMENTS WITHIN THE CONSTRUCTION SITE
- 8. EROSION CONTROLS ARE TO BE INSPECTED AND FORMS WITHIN 24 HOURS OF A RAIN EVENT GREA WEEKLY BY A QUALIFIED COMPLIANCE INSPECTO EROSION CONTROL MEASURES SHALL BE REPLAC THAN 7 DAYS OF IDENTIFICATION.
- 9. TRACK PAD CONSTRUCTION ENTRANCE TO BE VIS BE CLEANED (BRUSHED , EITHER MANUALLY OR MI FILLED WITH SEDIMENT, AT MINIMUM EVERY TWO
- 10. UTILITY LOCATIONS WITHIN THIS LOCATION ARE REFERENCE DOCUMENTS. CONTRACTOR TO VERI
- 11. THE CONTRACTOR SHALL REFER TO BID DOCUME **KEY NOTES**
- 1. FURNISH AND INSTALL EROSION CONTROL (DETAIL
- 2. FURNISH AND INSTALL INLET PROTECTION FOR EX
- D7 AND D9, CK501). 3. NOT USED.
- 4. FURNISH AND INSTALL DRIVEN POST CONSTRUCTION
- 5. FURNISH AND INSTALL CONCRETE WASHOUT STAT
- 6. FURNISH AND INSTALL TRACK PAD CONSTRUCTIO

/•\ 5 WSF 65 

CONC. CURB & GUTTER

<u>AN</u>				0	20	50	
						SCALE: 1" = 20'	
of ction lities	Drawing Title CIVIL EROSION CONTROL PLA		Phase 100% CONSTRI	UCTION DOCUMENT SUBMISSION	Project Title SIOUX FALLS BC	DILER PLANT	
nent epartment rans	Approved: Project Director		FULL	Y SPRINKLERED	Location VAMC-Sioux Falls Issue Date 08-09-2024	s: 2501 W 22nd St, Sioux Checked RBB	Falls, SD 571 Drawn EG
	7	8	}		9		

<b>ч</b> Г	A
BREVIATIONS, AND GENERAL NOTES.	В
DISPOSED OF IN ACCORDANCE WITH	
NSITE AND COVERED WITH SECURED	
OWABLE STAND OF GRASS HAS GROWN	
E OR SURPLUS CONCRETE ONTO THE VA NTAINERS. THE CONTRACTOR SHALL O CONTAIN CONCRETE WASHOUT FOR OR SHALL ENSURE THE COLLECTED IDERED TO A STATE OF SOUTH DAKOTA OR ETE COLLECTION SITE.	
S AND STOCKPILES WITHIN THE FENCED R SHALL MAINTAIN GOOD HOUSEKEEPING MES.	С
WITHIN THE AREA DEFINED AS THE T. DEBRIS SHALL BE COLLECTED AND WITHOUT DISTURBING SIOUX FALLS VA IE WASTE CONTAINER SHALL BE CONTAINED SITE.	
TE OF SOUTH DAKOTA DEPARTMENT OF UALITY OFFICE THE APPROPRIATE BOILER FUEL USE, HORSEPOWER)	
Y OF SIOUX FALLS NUISANCE VEGETATION E.	
DOCUMENTED VIA SDDOT 298 INSPECTION ATER THAN 0.5 INCHES OR AT MINIMUM OR OF STORMWATER (QCIS) . FAILED CED AS SOON AS POSSIBLE BUT NO LATER	D
SUALLY INSPECTED WEEKLY. MATS SHOULD MECHANICALLY) PRIOR TO VOIDS BEING WEEKS AFTER RAIN EVENTS.	
APPROXIMATE FROM VA PROVIDED RIFY ALL UTILITIES IN FIELD.	
ENTS FOR SITE SAFETY REQUIREMENTS.	
IL B3, CK501).	
XISTING STRUCTURES TO REMAIN (DETAILS	
ΓΙΟΝ FENCE (DETAIL F4, CK501).	E
ATION (DETAIL C1, CK503).	
ON ENTRANCE (DETAIL B7, CK501).	
	F
= 20'	
Project Number 438-22-900	
Building Number 12	
Sioux Falls, SD 57105	
B Drawn CG104 EG 9 OF 17	
]]]]]]]] 10	

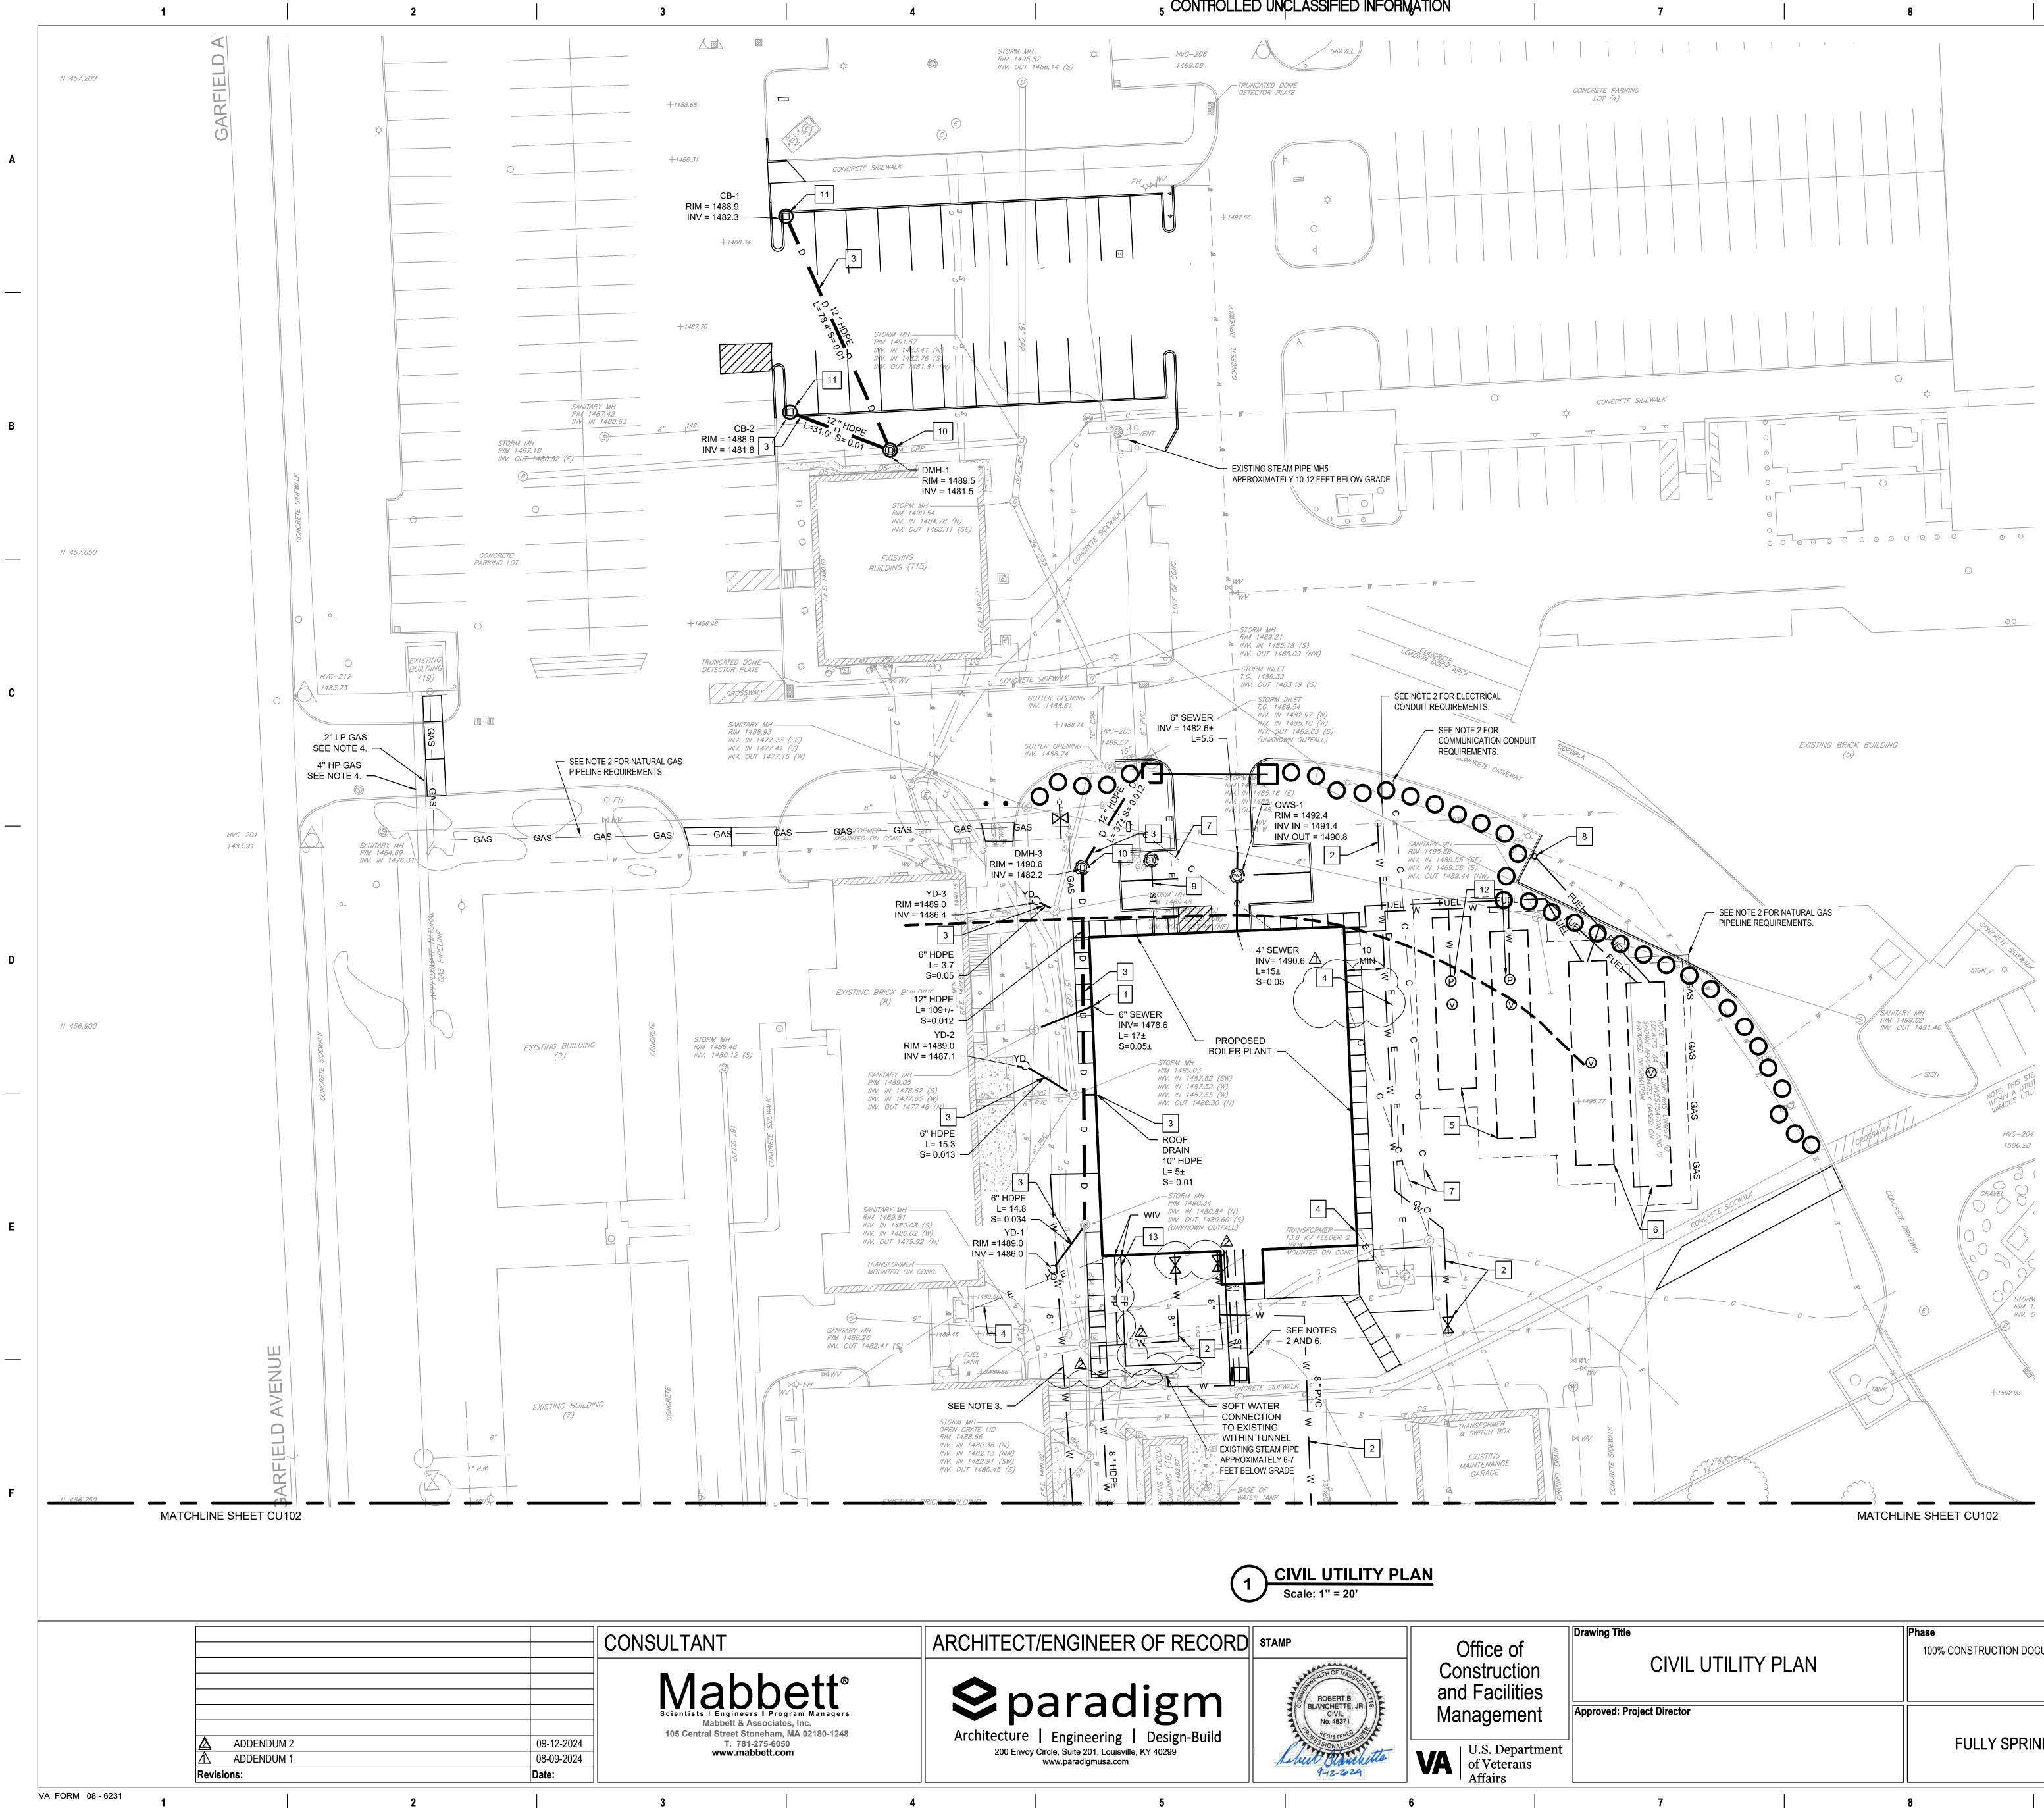

### 5 CONTROLLED UNCLASSIFIED INFORMATION

6

# NOTES

1. REFER TO DRAWING C-001 FOR CIVIL LEGEND, A

9


- 2. REFER TO ARCHITECTURAL, STRUCTURAL, ME ELECTRICAL DRAWINGS FOR MORE INFORMAT
- 3. REFER TO CIVIL UTILITY PROFILE SHEETS, C-30
- 4. LOCATION OBTAINED FROM VA, V.I.F. 4-INCH H
- 5. REFER TO SPECIFICATIONS FOR PERFORMANCE
- 6. REFER TO PLUMBING PLANS PL101 AND PL201
- WATER LINE TO BE CONNECTED TO EXISTING FOR CONTINUATION AND CU103 FOR PHASING

# **KEY NOTES**

- 1. FURNISH AND INSTALL 6-INCH PVC SEWER SER
- 2. FURNISH AND INSTALL GATE VALVE AND 8-INCH DETAIL C3, CK503).
- 3. FURNISH AND INSTALL HDPE DRAIN PIPE (DETA
- 4. FURNISH AND INSTALL ELECTRICAL DUCT BANK
- 5. FURNISH AND INSTALL 73,929 GALLONS OF WAT 49'-4"L X 12'D AND (1) 40,000 GALLON 54'-4"L X 2 TANKS (DETAIL D1, CK502).
- 6. FURNISH AND INSTALL 68,031 GALLONS OF FUE UNDERGROUND FRP DOUBLE WALLED FUEL O
- 7. FURNISH AND INSTALL COMMUNICATIONS CABI  $\frown \frown \frown \frown \frown \frown$ FURNISH AND INSTALL FUEL PIPING AND REMO
- AND DETAIL F7, CK501.  $\overline{\ }$ 9. FURNISH AND INSTALL STEAM MANHOLE (DETA
- [10.] FURNISH AND INSTALL DRAIN MANHOLE WITH L
- 11. FURNISH AND INSTALL CATCH BASIN (DETAIL F
- 12. FURNISH AND INSTALL DUPLEX SUBMERSIBLE
- 13. FURNISH AND INSTALL 4-INCH FIRE PROTECTIO WATER TOWER. SEE NOTE 2.  $\wedge \wedge$

		0	20	50	
			SCA	ALE: 1" = 20'	
e of	Drawing Title	Phase 100% CONSTRUCTION DOCUMENT SUBMISSION	Project Title SIOUX FALLS BOILER P		
uction cilities	CIVIL UTILITY PLAN				
ement	Approved: Project Director		Location VAMC-Sioux Falls: 2501	W 22nd St, Sioux I	<sup>-</sup> alls, SD 5
Department terans rs		FULLY SPRINKLERED	<b>Issue Date</b> 08-09-2024	Checked RBB	<b>Drawn</b> EG
	7	8	9		

	A
Γ	
, ABBREVIATIONS, AND GENERAL NOTES.	В
ECHANICAL, FIRE PROTECTION, AND TION.	
801 AND C-302. HGH PRESSURE NATURAL GAS. V.I.F.	
CE REQUIREMENTS.	
FOR WATER LINE CONFIGURATION IN TUNNEL WATER TOWER LINE. REFER TO SHEET CU102	
2.	
	C
	D
RVICE (DETAIL E9, CK501).	
CH PVC WATER MAIN (DETAIL F1, C-501 AND	
AIL C9, CK502). IK (SEE NOTE 2 AND DETAIL B5, CK501).	
ATER STORAGE. TANKS: (1) 35,000 GALLON 12'D UNDERGROUND FRP WATER STORAGE	
EL OIL STORAGE. TANKS: (2) 49'-4''L X 12'D DIL STORAGE TANKS (DETAIL F1, CK502).	
BLING. SEE NOTE 2.	E
AIL F1, CK503).	
LOCKABLE COVER (DETAIL C5, CK503). F5, CK502).	
PUMPS AND CONTROLS.	
ON LINE FOR BACKUP WATER PROVIDED BY	
	F
100	
20' Project Number	
438-22-900 Building Number	
, Sioux Falls, SD 57105	
B BG 10 OF 17	
10	]

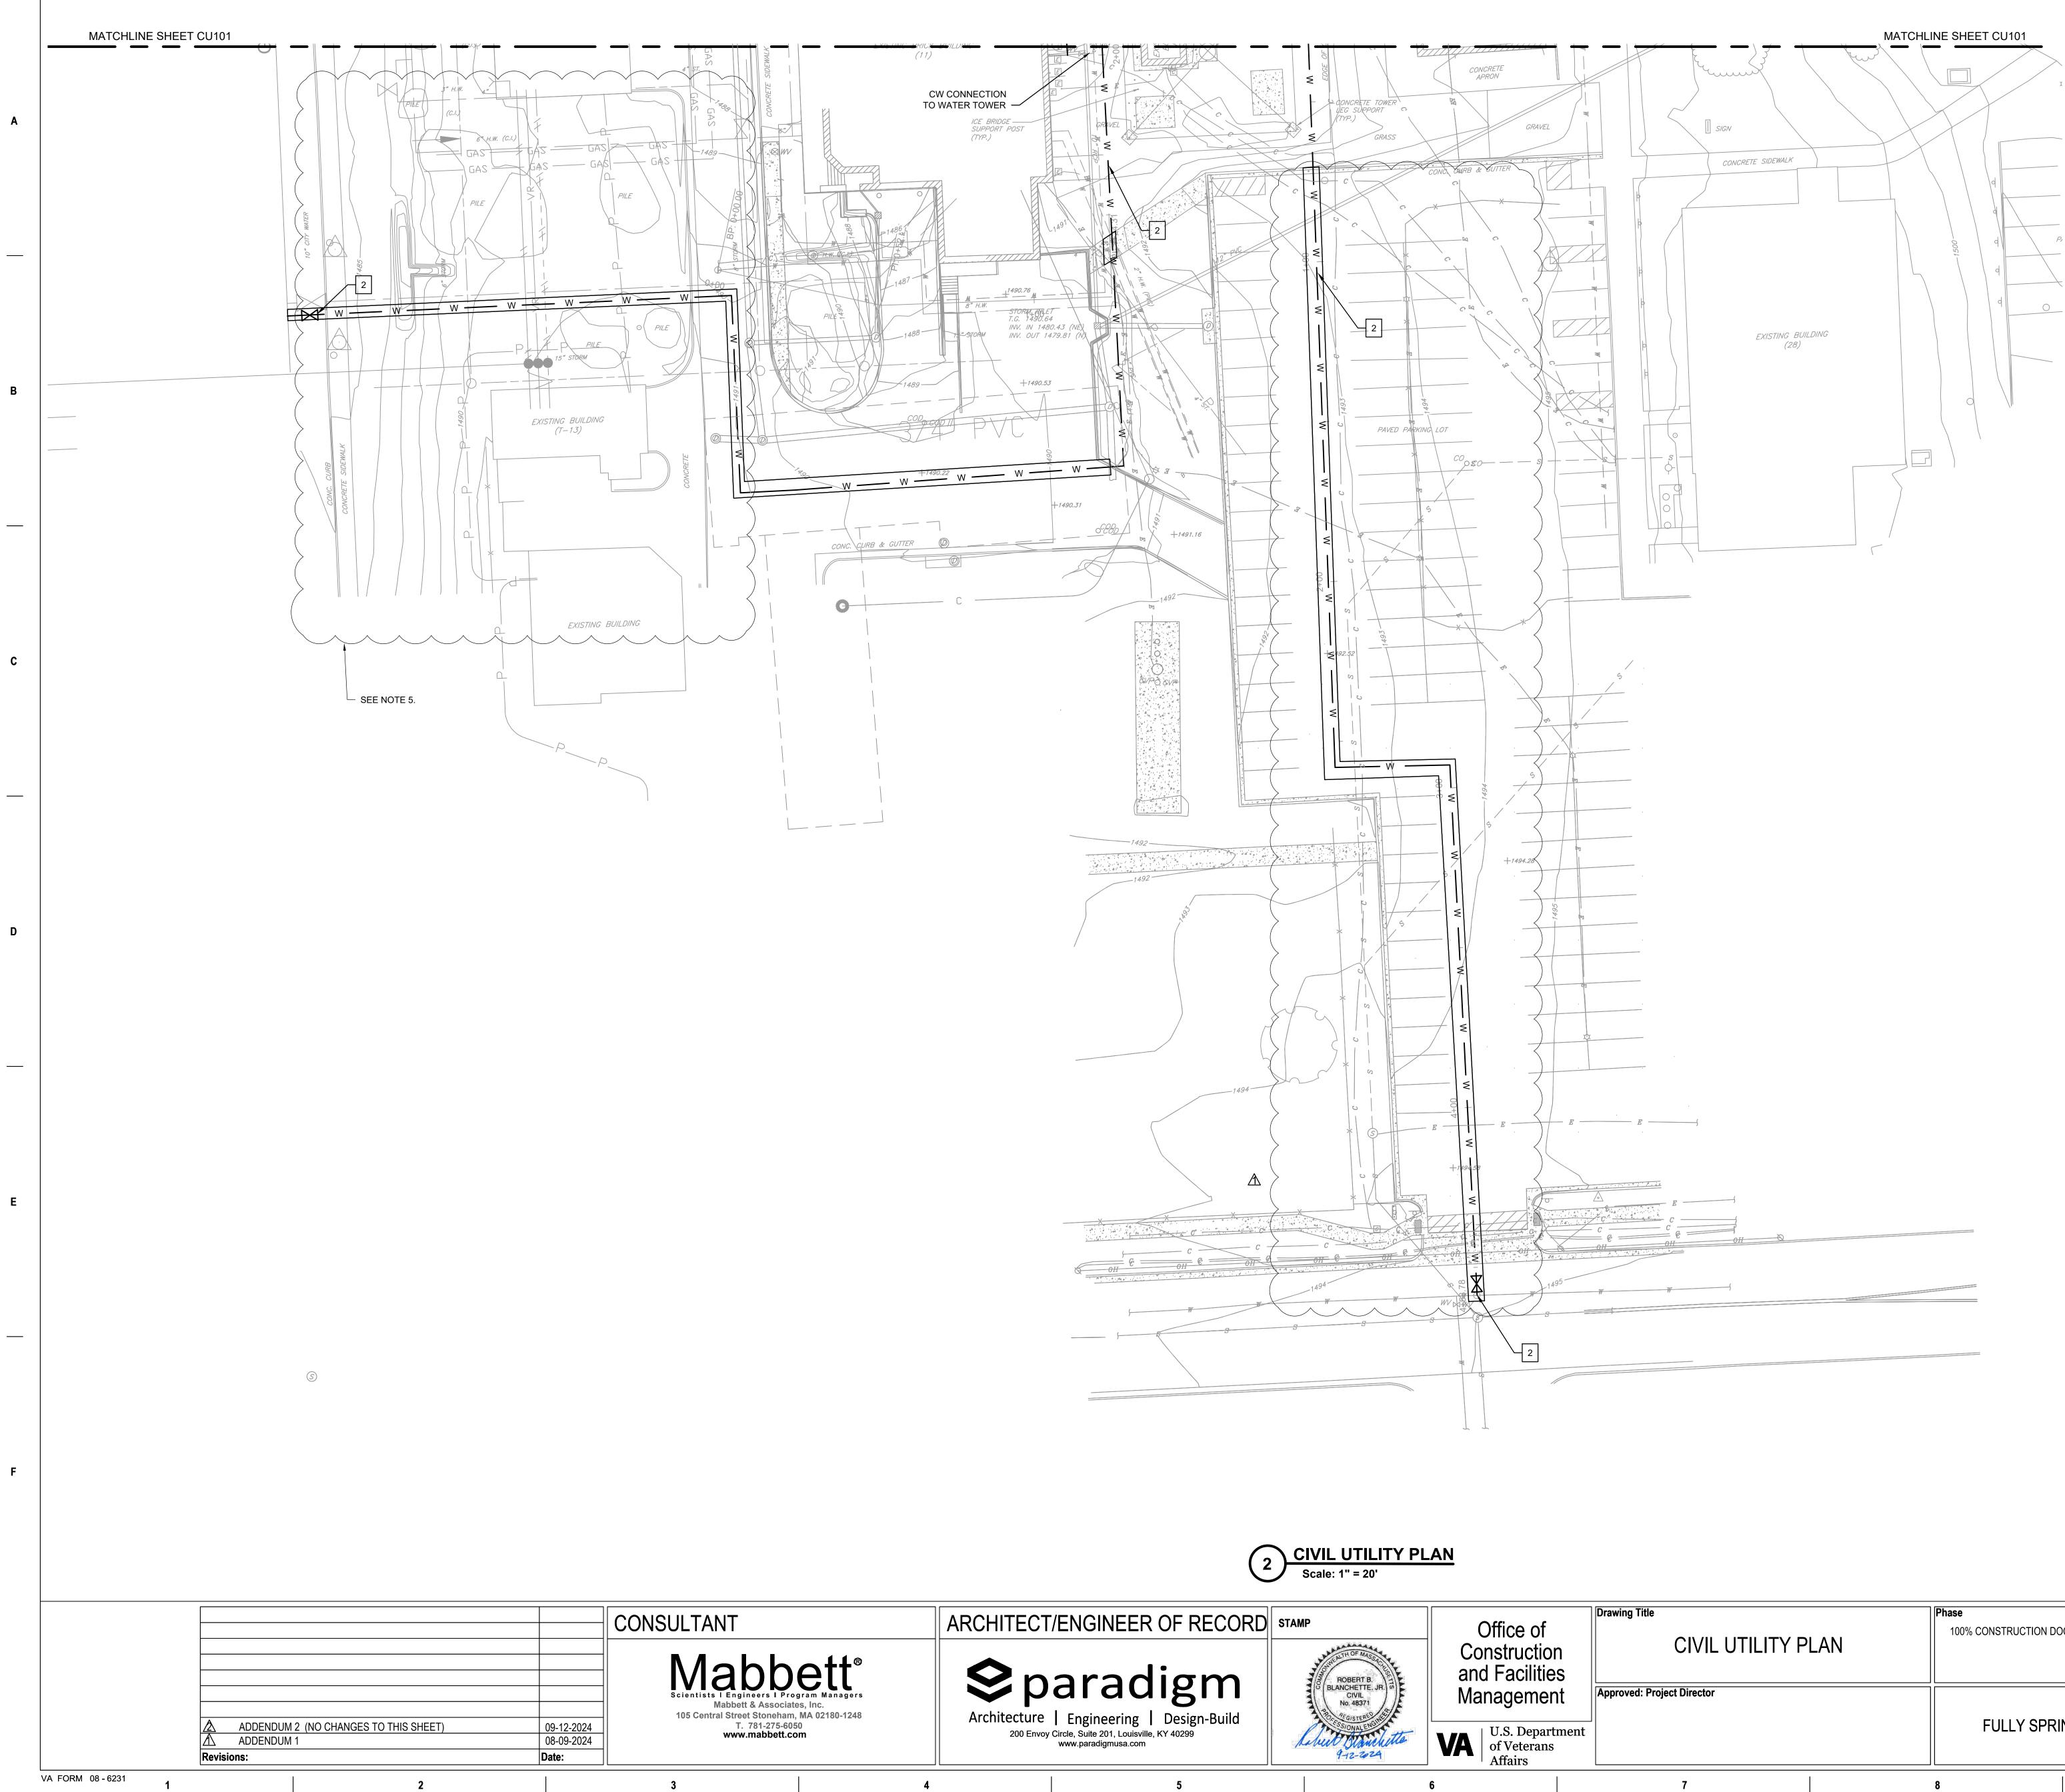

3

4

1



# 7

8



9

# NOTES

- 1. REFER TO DRAWING C-001 FOR CIVIL LEGEND, ABBREVIATIONS, AND GENERAL NOTES.
- 2. REFER TO ARCHITECTURAL, STRUCTURAL, MECHANICAL, AND ELECTRICAL DRAWINGS FOR MORE INFORMATION.
- 3. REFER TO CIVIL UTILITY PROFILE SHEETS, CJ301 AND CJ302.
- 4. COMPLY WITH CITY OF SIOUX FALLS DEPARTMENT OF PUBLIC WORKS STREET OPENING AND SERVICE CONNECTION.
- 5. UTILITIES SHOWN IN THIS LOCATION WERE OBTAINED FROM VA REFERENCE DOCUMENTS. CONTRACTOR IS REQUIRED TO VERIFY ALL LOCATIONS IN FIELD.

### **KEY NOTES**


1. NOT USED.

2. FURNISH AND INSTALL GATE VALVE AND 8-INCH I DETAIL C3, CK503).

		0	20	50
			SC/	ALE: 1" = 20
c	Drawing Title	Phase	Project Title	
e of ruction icilities	CIVIL UTILITY PLAN	100% CONSTRUCTION DOCUMENT SUBMISSION	SIOUX FALLS BOILER F	PLANT
ement	Approved: Project Director		Location	
			VAMC-Sioux Falls: 2501	W 22nd St, Sie
Department		FULLY SPRINKLERED	Issue Date	Checked
eterans irs			08-09-2024	RBB
	7	8	9	

	100
20'	
	Project Number
	438-22-900
	Building Number
	12
	Drawing Number
Sioux Falls, SD 57105	
Drawn	CU102
B EG	11 OF 17
	10

H PVC WATER I	MAIN (DETAIL	F1, CK501	AND

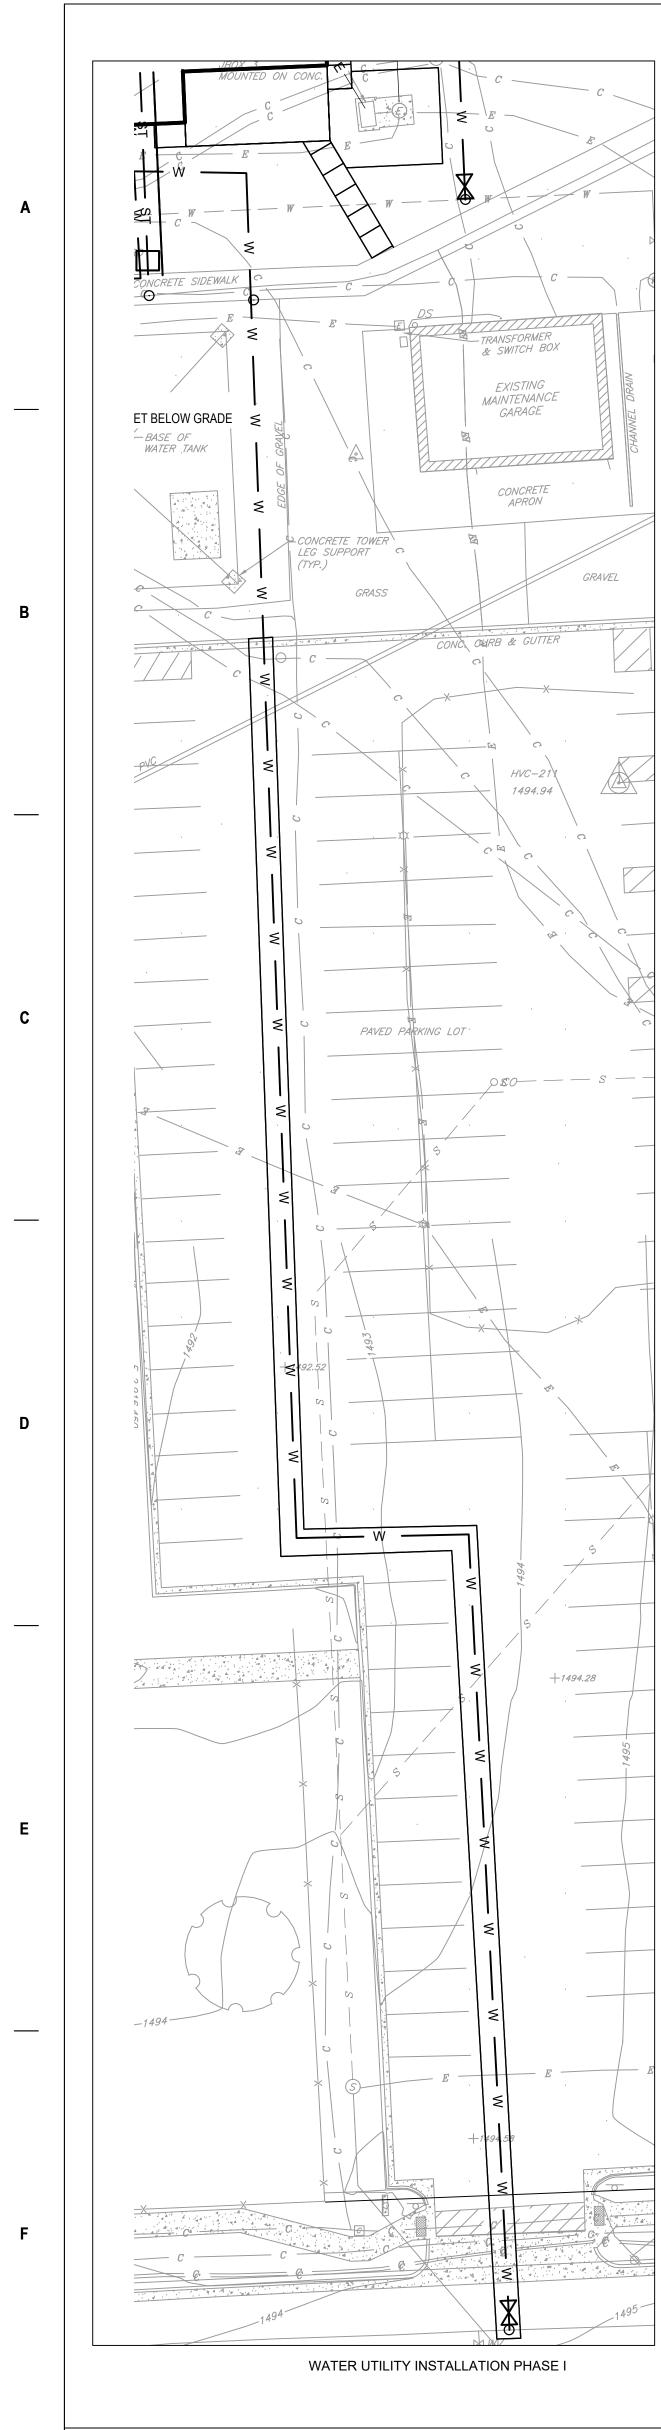

D

Ε

1

# PHASE I NOTES

2

PHASE I OF THE WATER MAIN INSTALLATION INCLUDES WORK ASSOCIATED WITH THE INSTALLATION OF THE WATER MAIN FROM WEST 26TH STREET TO THE NEW BOILER PLANT (NOT ACTIVE AT THE TIME OF INSTALLATION) ... THIS PHASE IS REQUIRED TO BE COMPLETED PRIOR TO ANY DISCONNECTIONS TO PREVENT AN OUTAGE FOR THE HOSPITAL.

3


4


		CONSULTANT
ADDENDUM 2 (NO CHANGES TO THIS SHEET) ADDENDUM 1 (NO CHANGES TO THIS SHEET)	09-12-2024 08-09-2024	Mabbett & As 105 Central Street Sto T. 781- www.mab
Revisions:	Date:	

2

1

### 5 CONTROLLED UNCLASSIFIED INFORMATION

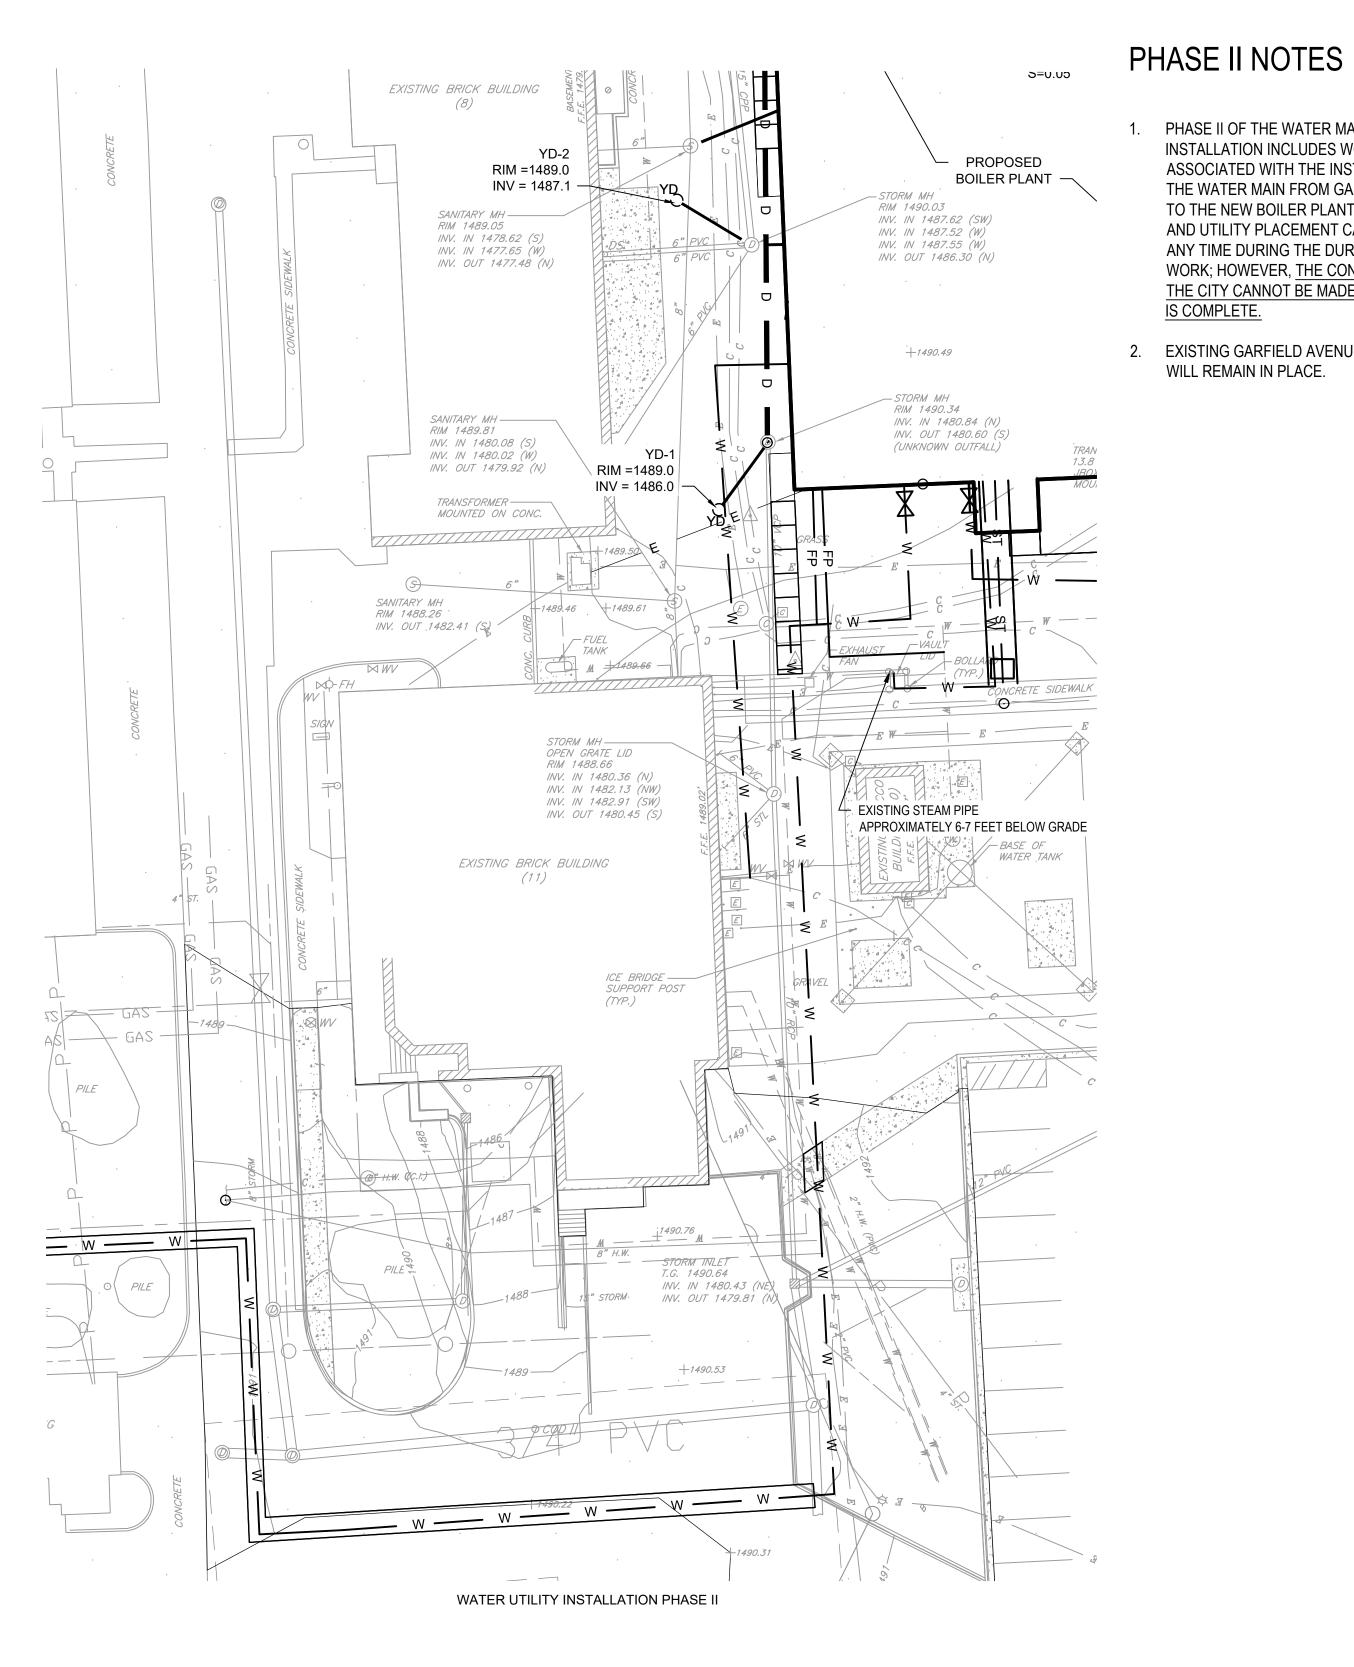

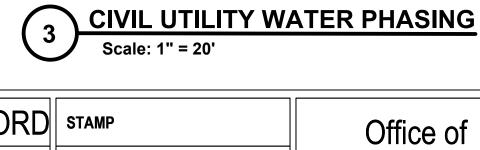



4

ARCHITECT/ENGINEER OF RECORD STAMP

\$ paradigm ROBERT B. BLANCHETTE, JR CIVIL No. 48371 Architecture | Engineering | Design-Build 200 Envoy Circle, Suite 201, Louisville, KY 40299 www.paradigmusa.com 9-12-2024



CUI

5


7

8

9

1. PHASE II OF THE WATER MAIN INSTALLATION INCLUDES WORK ASSOCIATED WITH THE INSTALLATION OF THE WATER MAIN FROM GARFIELD AVENUE TO THE NEW BOILER PLANT. EXCAVATION AND UTILITY PLACEMENT CAN BE DONE AT ANY TIME DURING THE DURATION OF THE WORK; HOWEVER, THE CONNECTION TO THE CITY CANNOT BE MADE UNTIL PHASE I

2. EXISTING GARFIELD AVENUE WATER MAIN

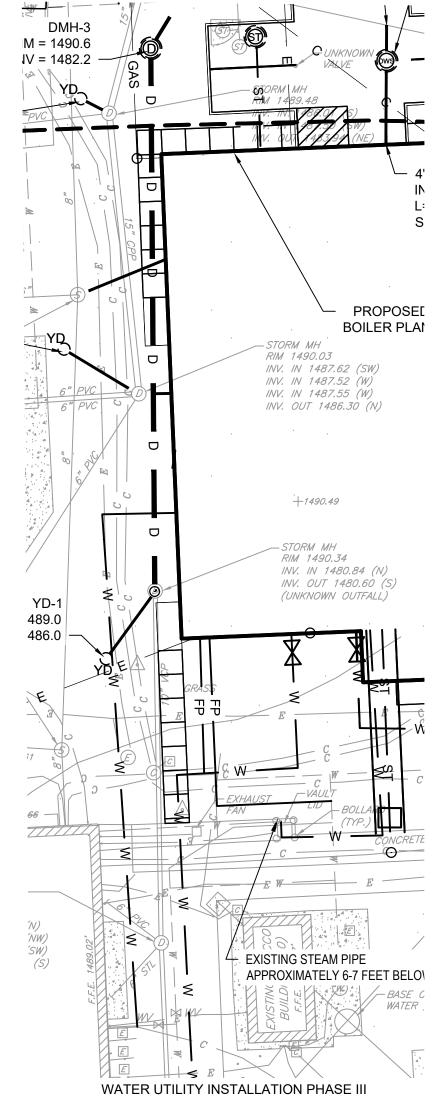

# ∠ PHASE III NOTES

PHASE III OF THE WATER MAIN INSTALLATION INCLUDES V EXISTING UNDERGROUND WATER LINES ARE L ABILITY TO ISOLATE THE SYSTEMS. THERE IS A THE UNDERGROUND PUMPED/TOWER WATER FEEDS THE EXISTING WATER SOFTENERS IN BU THAT CAN BE UTILIZED TO ISOLATE THE SYSTEI THE FINAL CONNECTIONS TO THE NEW BUILDIN PUMPED/TOWER WATER SYSTEM TO BE COMPL EXISTING PUMPED/TOWER WATER SYSTEM WO FULLY OPERATIONAL, THE NEW SOFT WATER S WOULD BE TIED INTO THE SITE IN PHASE 2 AVC DISRUPTION OF WATER SERVICE TO THE SIOUX ONCE THE NEW PUMPED/TOWER LINE IS TESTE VALVES CAN BE OPENED TO ALLOW THE NEW TOWER/PUMP SYSTEM TO BE COMMISSIONED.


### NOTES


- 1. REFER TO DRAWING C-001 FOR CIVIL LEGEND, ABBREVIATIONS, AND GENERAL NOTES.
- 2. REFER TO MECHANICAL DRAWINGS FOR MORE INFORMATION.
- 3. REFER TO CIVIL UTILITY PROFILE SHEETS, CJ301 AND CJ302.
- 4. REFER TO SPECIFICATIONS FOR PERFORMANCE REQUIREMENTS.

NG				0	20	50
						SCALE: 1" = 2
_	Drawing Title		Phase		Project Title	
of tion lities	CIVIL UTILITY P PHASING	PLAN -	100% CONSTRUCTION DC	DCUMENT SUBMISSION	SIOUX FALLS BO	DILER PLANT
nent	Approved: Project Director				Location	
					VAMC-Sioux Fall	s: 2501 W 22nd St, S
partment			FULLY SPRI	NKLERED	Issue Date	Checked
rans					08-09-2024	RBB
	7		8		9	


		100	
20'			
Project Number			
		438-22-900	
		Building Number	
		12	
		Drawing Number	
Sioux	Falls, SD 57105		
	Drawn	CU103	
}	EG	12 OF 17	
10			

NORK THE
IMITED IN THE
6" VALVE ON
LINE THAT
JILDING 11
M TO ALLOW
NG 12
LETED. THE
OULD STILL BE
SYSTEM
DIDING ANY
X FALLS SITE.
ED, THE

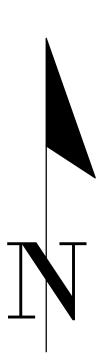

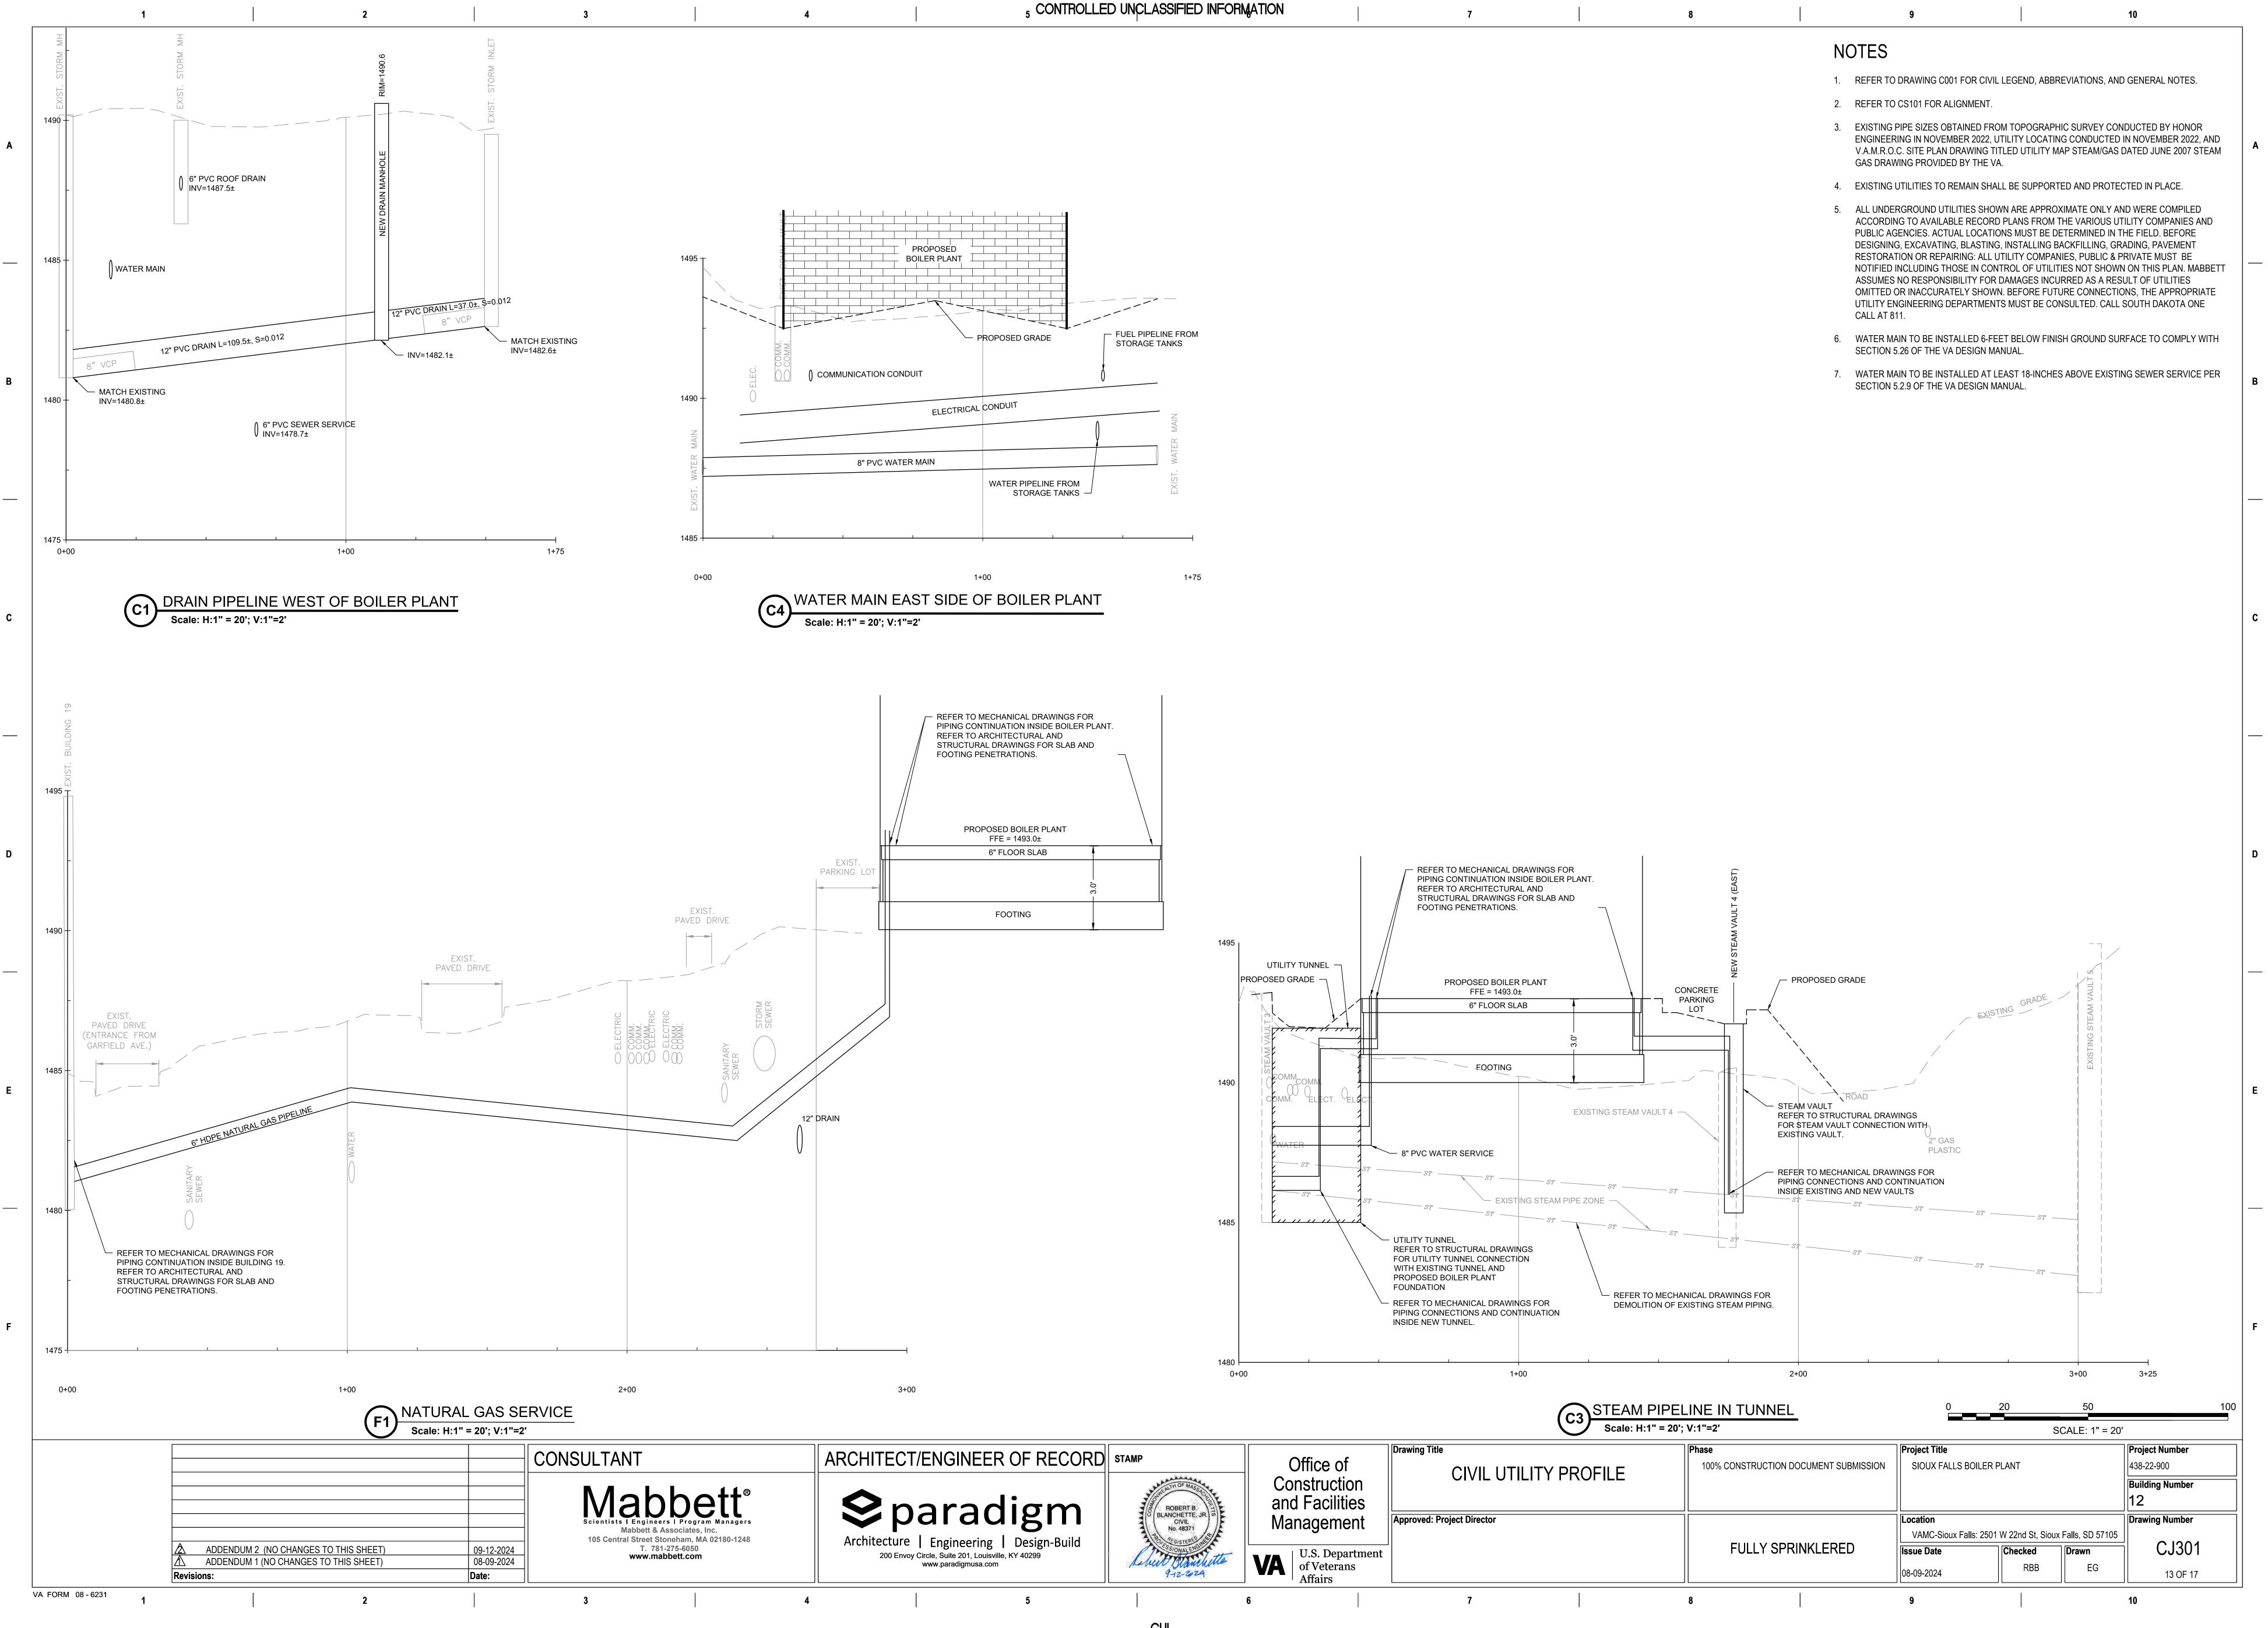




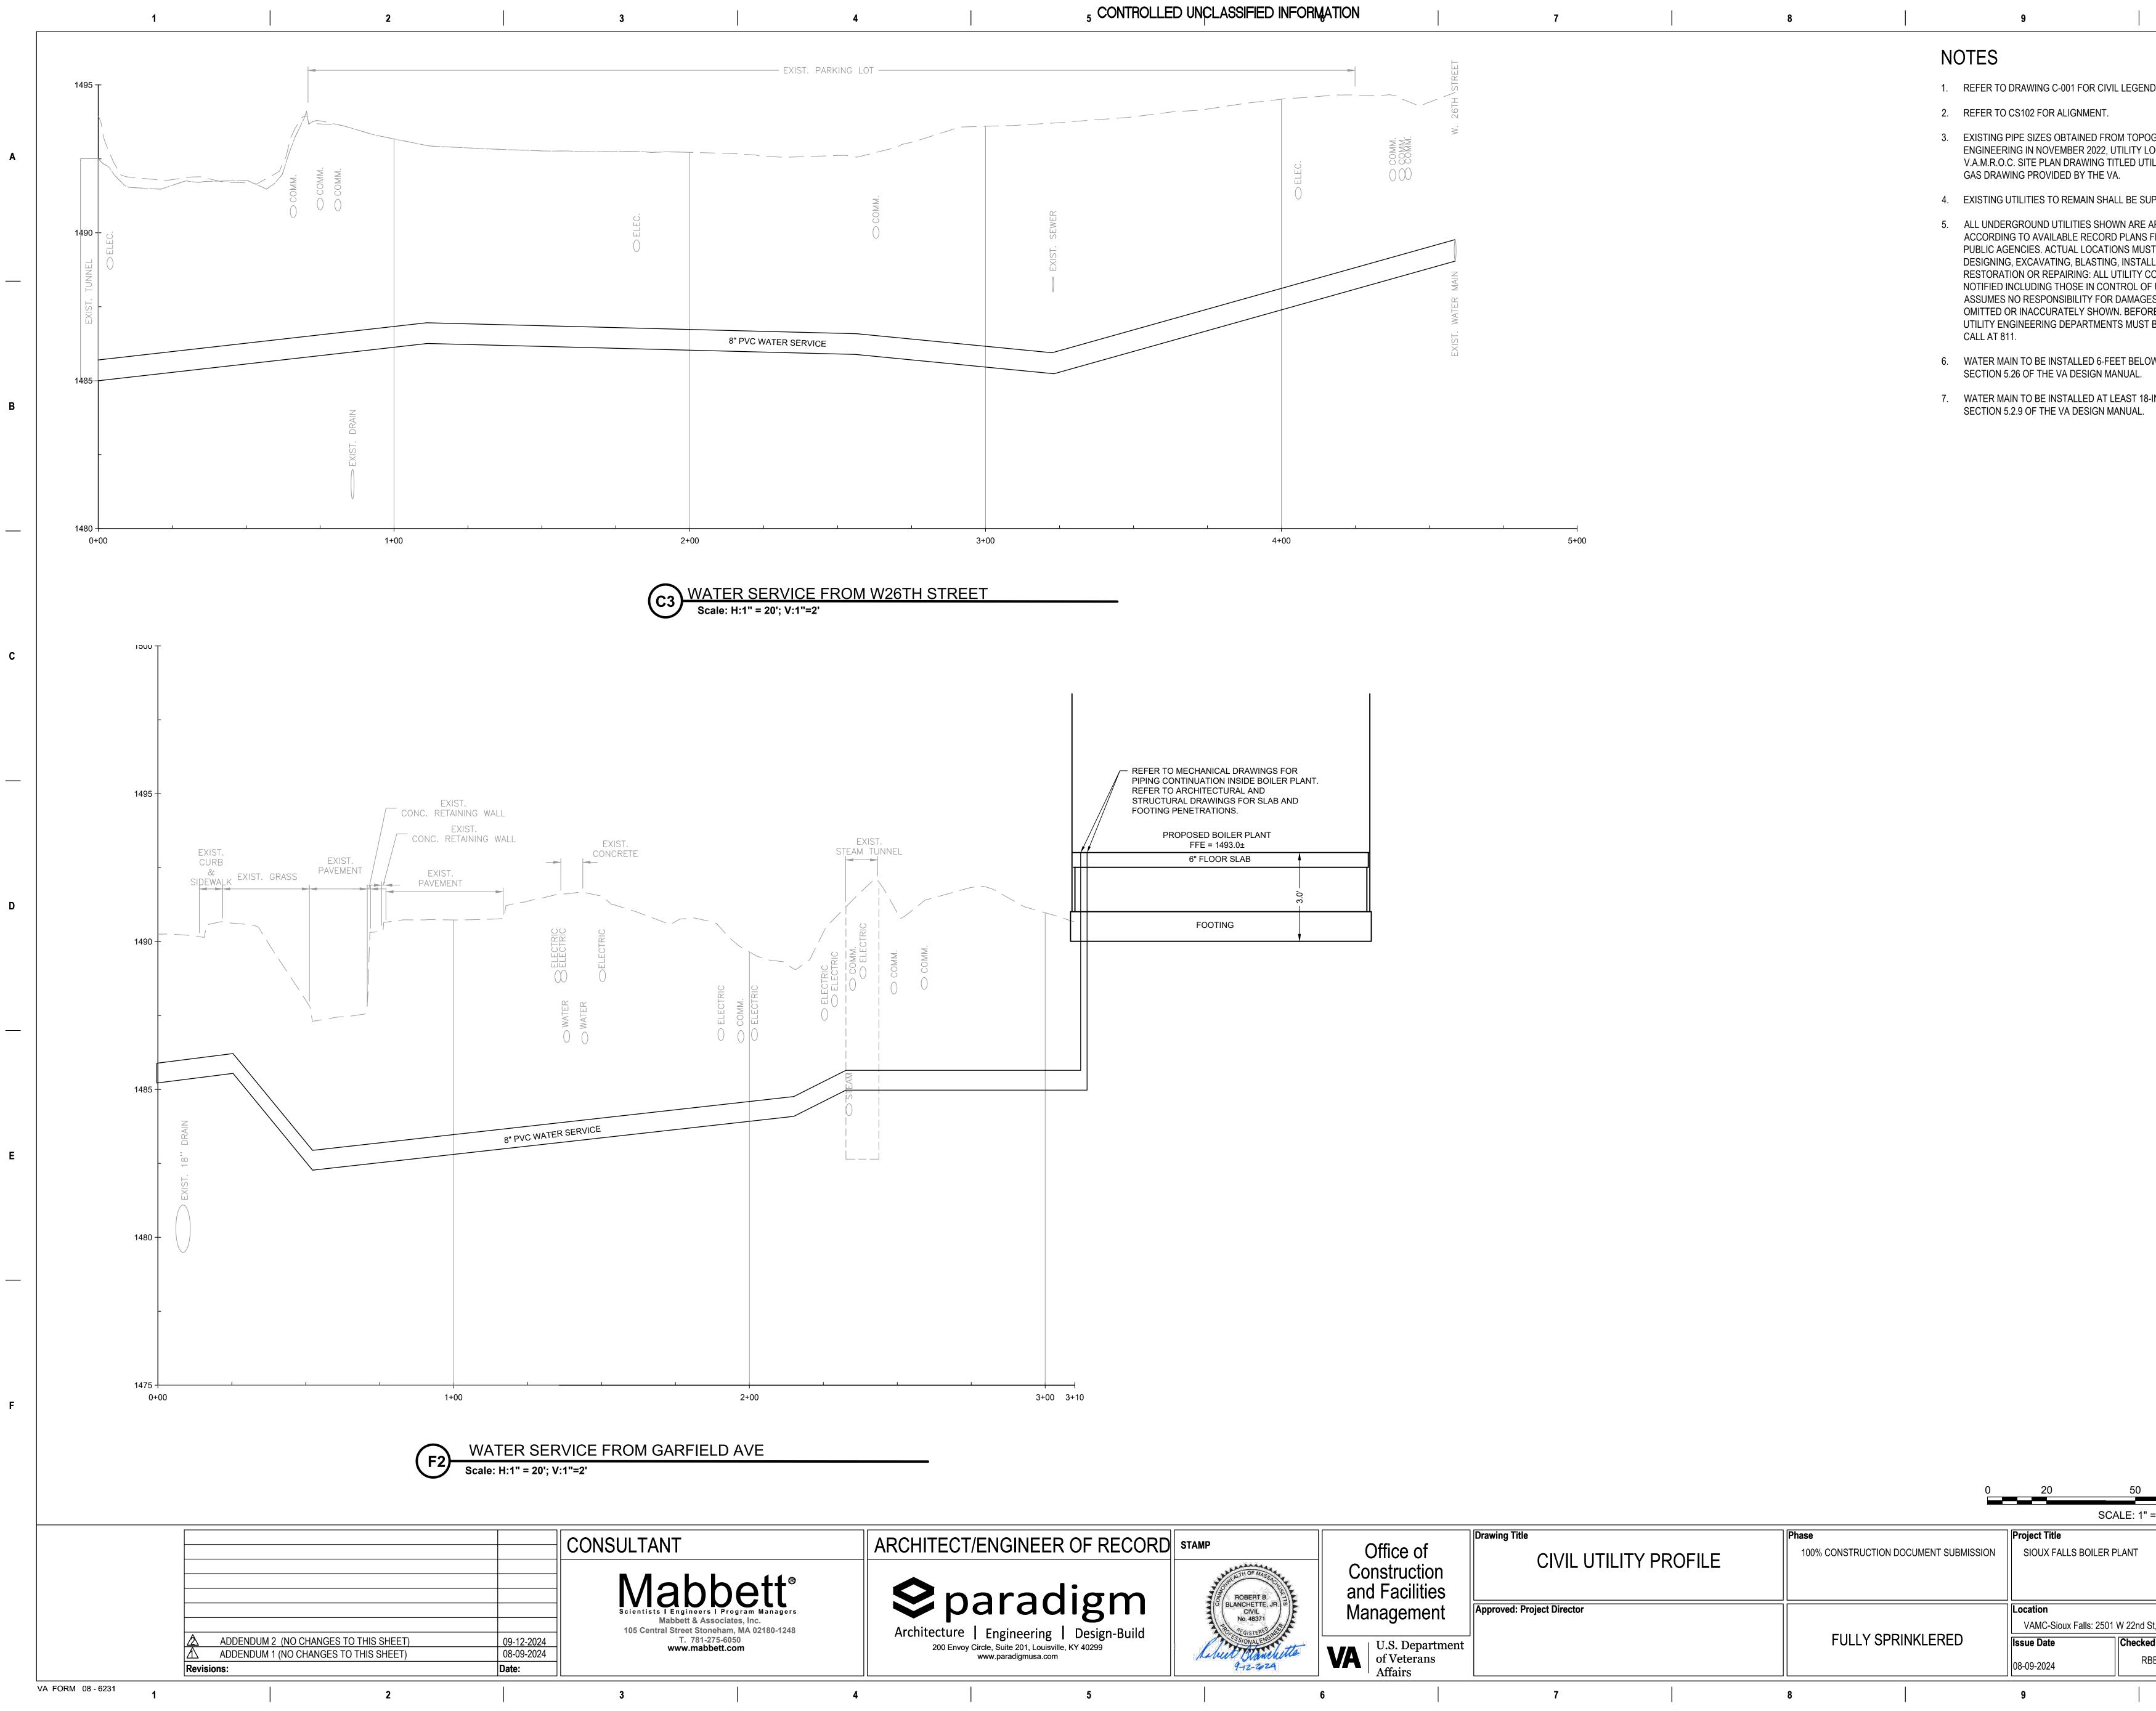

		0	20	50
			SCA	ALE: 1" :
	Drawing Title	Phase	Project Title	
e of Iction cilities	CIVIL UTILITY PROFILE	100% CONSTRUCTION DOCUMENT SUBMISSION	SIOUX FALLS BOILER P	PLANT
ment	Approved: Project Director		Location VAMC-Sioux Falls: 2501	W 22nd S
Department Terans Ts		FULLY SPRINKLERED	<b>Issue Date</b> 08-09-2024	Checked RB
	7	8	9	

ID, ABBREVIATIONS, AND GENERAL NOTES.	
OGRAPHIC SURVEY CONDUCTED BY HONOR OCATING CONDUCTED IN NOVEMBER 2022, AND ILITY MAP STEAM/GAS DATED JUNE 2007 STEAM	A
JPPORTED AND PROTECTED IN PLACE. APPROXIMATE ONLY AND WERE COMPILED FROM THE VARIOUS UTILITY COMPANIES AND ST BE DETERMINED IN THE FIELD. BEFORE LING BACKFILLING, GRADING, PAVEMENT COMPANIES, PUBLIC & PRIVATE MUST BE F UTILITIES NOT SHOWN ON THIS PLAN. MABBETT ES INCURRED AS A RESULT OF UTILITIES RE FUTURE CONNECTIONS, THE APPROPRIATE	
BE CONSULTED. CALL SOUTH DAKOTA ONE	
-INCHES ABOVE EXISTING SEWER SERVICE PER	В
	С
	D
	Е
	_
	F
= 20'	
<b>Project Number</b> 438-22-900	
Building Number 12	
St, Sioux Falls, SD 57105	
BB EG 14 OF 17	

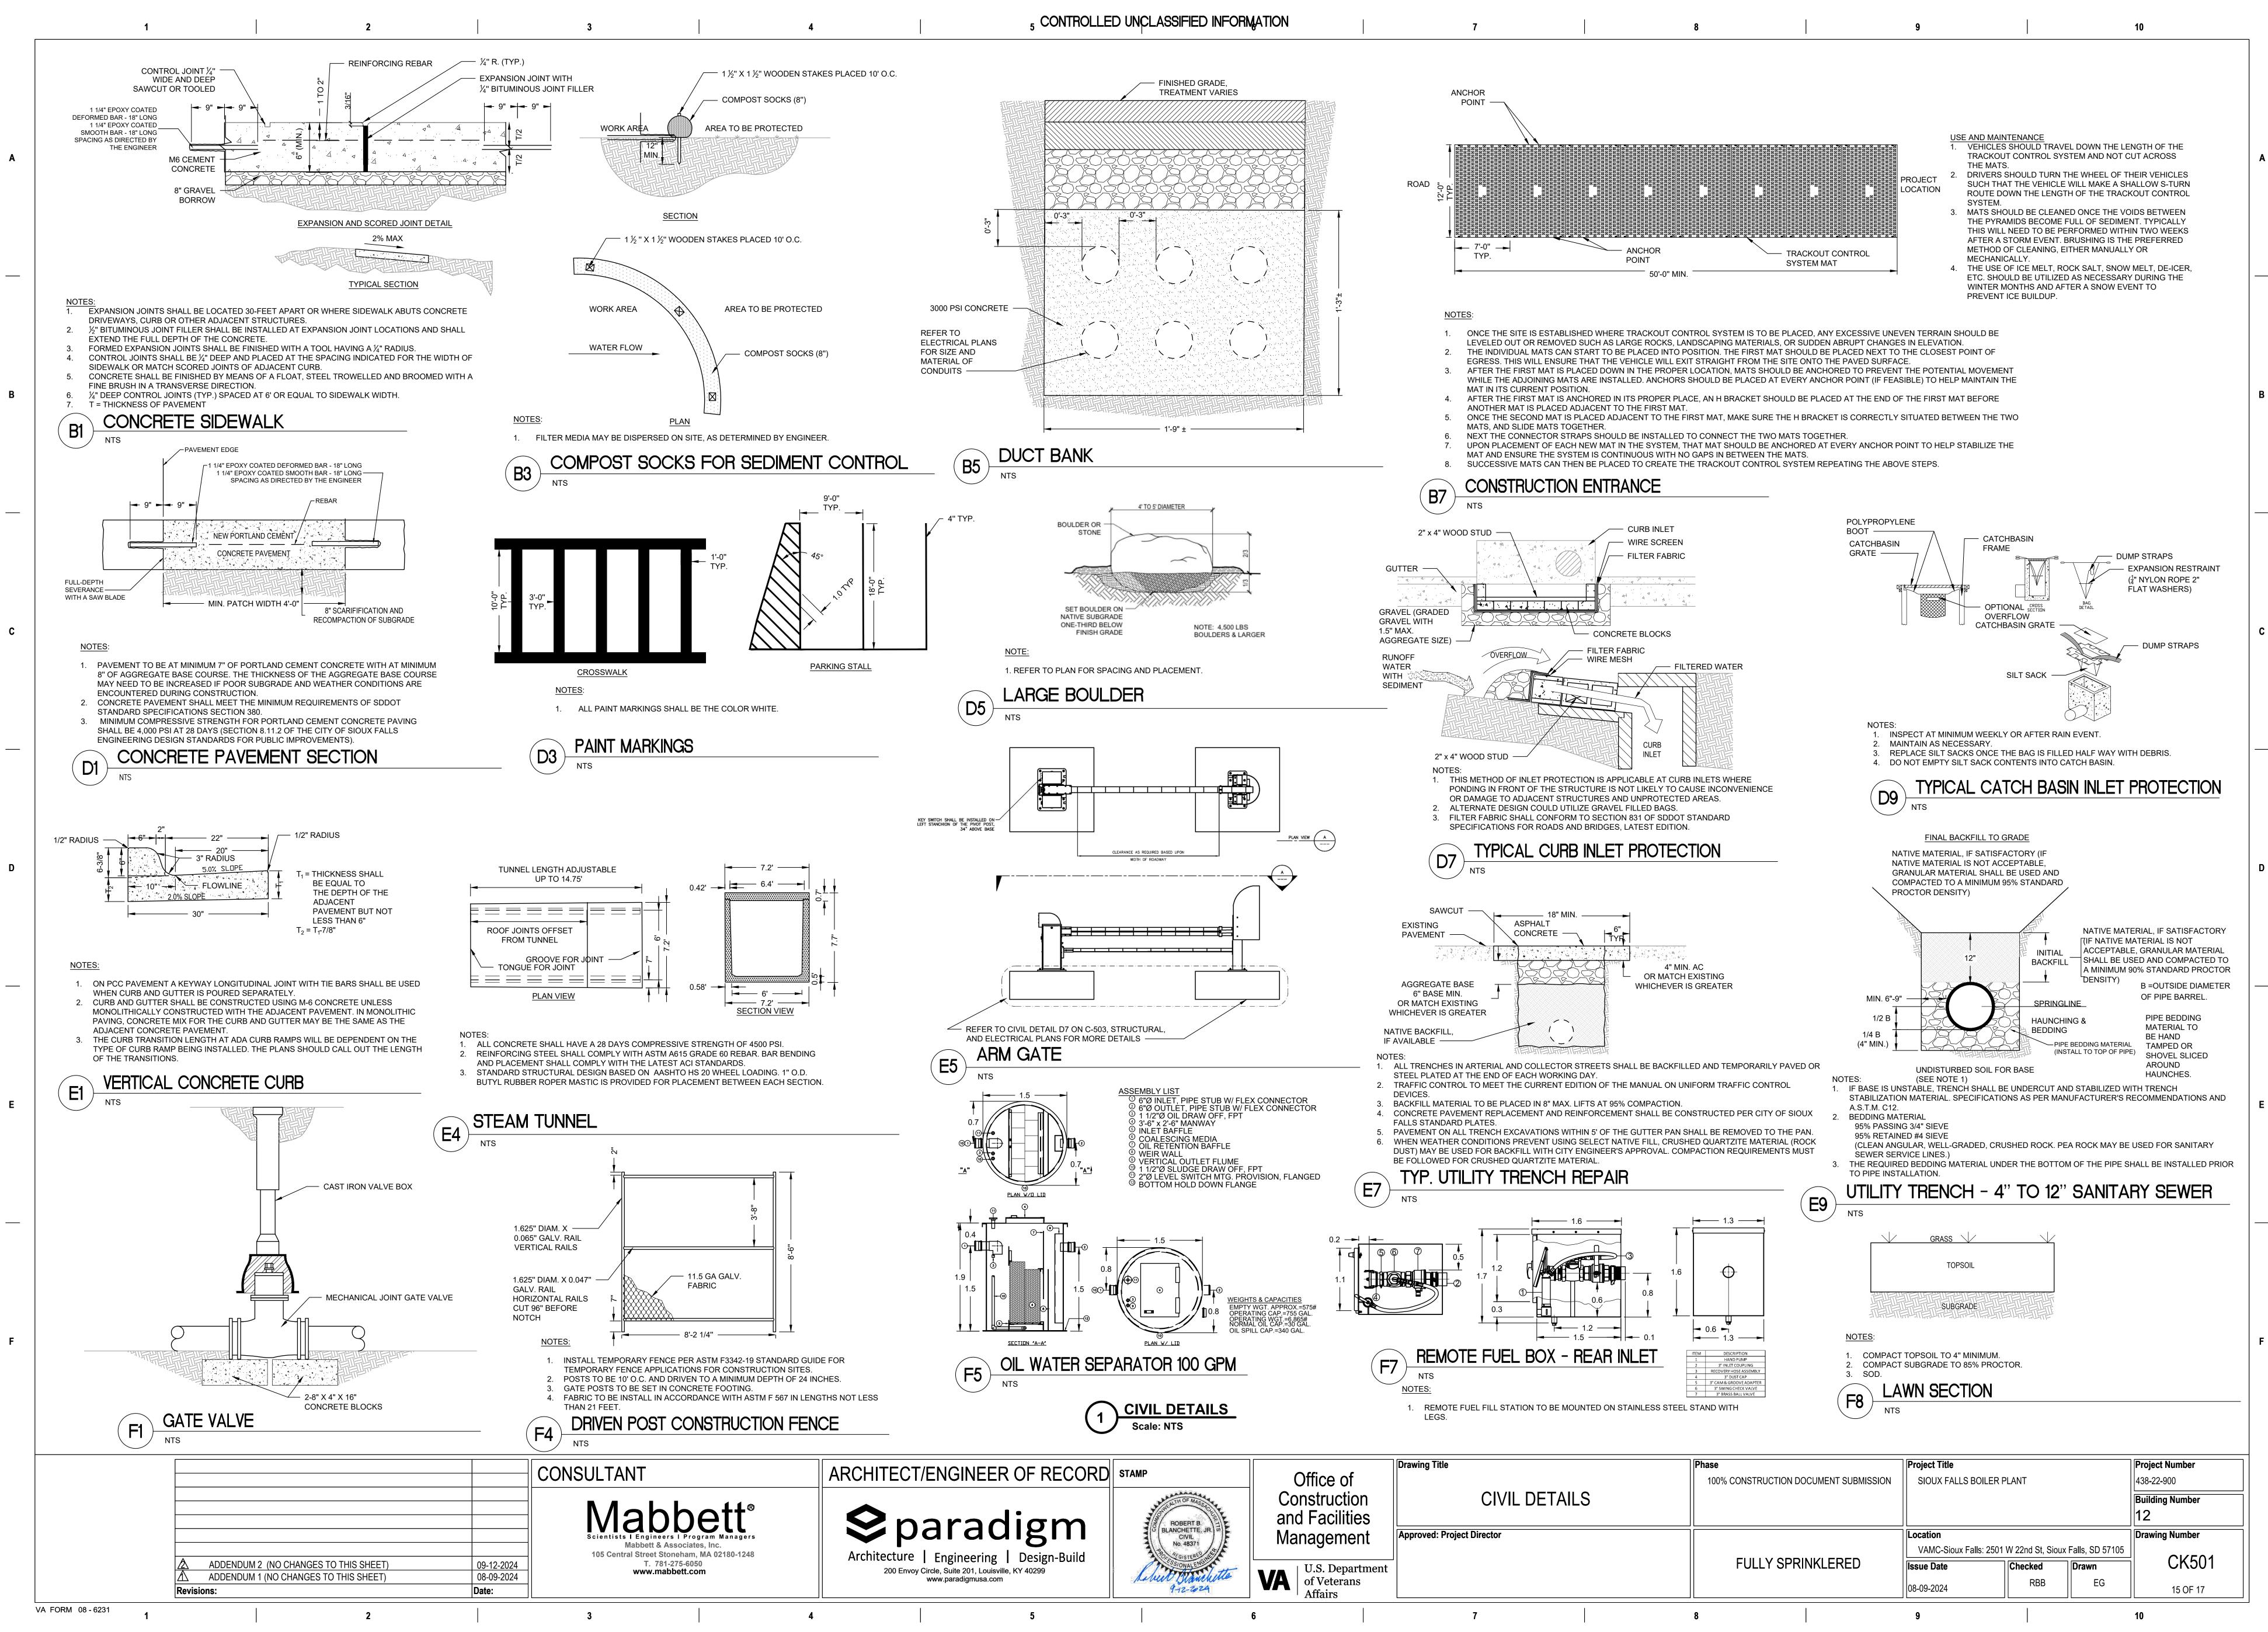

gement	Approved: Project Director	
S. Department Veterans fairs		FULLY SPRINKLERED
uiio		
1	7	•

ocation	
VAMC-Sioux Falls: 2501	W 22nd S
sue Date	Checke
-09-2024	RE

