PANEL RATING & FEEDER PANEL INFORMATION PANEL "12-LN2" MAIN TYPE 225A MLO PANEL AMPACITY: 225 AMPS 120/208 PHASE CONDUCTORS: VOLTAGE #4/0 THWN VOLTS 3PH-4W NORMAL POWER SURFACE NEUTRAL MOUNTING MOUNT (1) #4 THWN AIC RATING NEW PANEL # OF SETS (1 SET) "T-12-LN2" ENCLOSURE TYPE NEMA-1SOURCE LOAD IN VOLT AMPS (VA) LOAD IN VOLT AMPS (VA) KITCHEN RECEPT. LTG (125%) WIRE SIZE CB AMPS DESCRIPTON CKT DESCRIPTION CB AMPS WIRE SIZE | LTG (125%) | RECEPT. KITCHEN HVAC MISC PHASE MISC HVAC CKT 1 RECEPTACLES 20 900 20 RECEPTACLES #12 3 EXTERIOR RECEPTACLES 1080 REFRIGERATOR 20 #12 900 20 #12 4 5 RECEPTACLES 720 1200 COFFEE MAKER #12 #12 20 MJGBQWAVE 8 7 RECEPTACLES 360 1200 #12 9 RECEPTACLES 720 RECEPTACLES #12 11 RECEPTACLES RECEPTACLES 540 #12 900 #12 20 RÉCÉPTACLES 14 1080 13 RECEPTACLES 20 #12 15 WATER SOFTENERS 12-WS-1 & 12-WS-2 20 #12 2496 12-ACCU-4 (CONDENSING UNIT) 17 DOMESTIC WATER HEATER 12-WH-1 20 1800 2496 #12 19 SPARE 1980 #12 Α #10 12-FCCU-4 (FAN COIL UNIT) 1980 1976 -12-ACCU-2 (CONDENSING UNIT) #10 1976 BAS CONTROL PANEL #12 20 24 200 1456 1664 12-FCCU-2 (FAN COIL UNIT) 20 #12 UPS SYSTEM 28 1456 1664 #10 1976 1664 -12-ACCU-3 (CONDENSING UNIT) #10 30 32 1976 #12 FUEL MONITORING SYSTEM Α 35 12-FCCU-3 (FAN COIL UNIT) 1456 300 HAZARDOUS CONTROL PANEL #12 20 #12 200 PACS PANEL 1456 #12 37 SERVER RACK WATER QUALITY MONITORING SYSTEM 1000 300 #12 #12 39 SPARE 720 20 RECEPTACLES #12 #12 RECEPTACLES 41 BOILER CONTROL PANEL (12-B-101) 200 720 20 20 #12 #12 42 43 BOILER CONTROL PANEL (12-B-102) 1080 20 #12 200 #12 20 RECEPTACLES 44 45 BOILER CONTROL PANEL (12-B-103) #12 200 720 #12 RECEPTACLES 46 47 DIGITAL DIALER CONTROL PANEL 720 RECEPTACLES 48 #12 #12 49 EXTERIOR RECEPTACLES 720 1080 RECEPTACLES 20 #12 #12 51 EXTERIOR RECEPTACLES 540 BASS CONTROL PANEL #12 200 #12 52 53 BOILER CONTROL PANEL (12-B-104) (FUTURE) 20 400 12-B-101 & 12-B-102 #12 #12 54 55 RECEPTACLES 12-B-103 & 12-B-104 20 #12 1080 400 #12 56 Α 1000 1800 DEAERATOR 12-DA-001 #12 59 PDU (POWER DISTRIBUTION UNIT) 1800 CONDENSATE STORAGE 12-CR-1 20 #12 61 1000 1200 CONTROL ROOM PANEL 12-CP1 #12 62 63 1200 CONTROL ROOM PANEL 12-CP2 1000 #12 20 64 65 PDU (POWER DISTRIBUTION UNIT) 20 #12 BOILER FUEL OIL PUMP 12-F0-101 1000 1200 #12 67 1000 1200 BOILER FUEL OIL PUMP 12-F0-102 Α #12 20 1976 300 EXHAUST FAN 12-EF-3 #12 12-ACCU-1 (CONDENSING UNIT) #10 OVERHEAD DOOR 1976 1200 #12 900 1456 WELDER 74 #12 -12-FCCU-1 (FAN COIL UNIT) 30 #10 NEW TUNNEL RECEPTACLES 1456 360 #12 20 76 77 DRINKING FOUNTAIN 20 200 #12 20 SPARE 78 #12 79 SPARE 80 20 #12 82 81 SPARE SPD-12-LN2 (125KA) 20 #10 #12 84 83 SPARE 20 #12 OTAL LOADS 7380 20792 9360 TOTAL LOADS 13728 17064 LOAD CALCULATION (NEC 2023 - ARTICLE 220) PANEL NOTES LOAD TYPE LOAD (kVA) DEMAND % DEMAND LOAD kW LIGHTING 0.00 1.25 0.0 kW RECEPTACLES 10.00 1.00 13.4 kW RECEPTACLES > 10000 6.74 0.50 KITCHEN EQUIPMENT 0.00 0.65 0.0 kW 37.86 1.00 37.9 kW 23.0 kW 22.98 1.00 74.2 kW TOTAL kW DEMAND

PANEL SCHEDULE "12-LN2" (NORMAL POWER - 120/208 VOLTS)
SCALE NOT TO SCALE

PANEL INFORMATION MAIN TYPE: 100A MLO					PANEL "12-GEN"				PANEL RATING & FEEDER									
					TANLE 12 OLIV								AMPS					
	VOLTAGE: 120/ 208 3PH-4W					EMERGENCY LIFE SAFETY POWER				PHASE CONDUCTORS: (3) #3				THWN				
MOUNTING: SURFACE												#8	THWN					
AIC RATING: 10000 AIC			NEW PANEL				# OF SETS: (1 SET)											
ENCLOSURE TYPE: NEMA-1										SOURCE:	SEE ONE-L	LINE DIAGRA	A M					
			LOAD IN VO						 	OLT AMPS								
CKT DESCRIPTION	CB	WIRE	LTG(125%)	RECEPT.	KITCHEN	HVAC	MISC	PHASE	MISC	HVAC	KITCHEN	RECEPT.	LTG(125%)	WIRE	СВ	DESCRIPTON	CK	
1							900	Α	900								2	
3 GENERATOR SUPPLY FUEL PUMP (2HP)	20	#12					900	В	900					#12	20	GENERATOR RETURN FUEL PUMP (2HP)	4	
5							900	С	900								6	
7 GENERATOR LIGHTS AND RECEPTACLES	20	#12	100	360				Α	1200					#12	20	12-F0-103 (GENERATOR FUEL OIL PUMP)	8	
9 BATTERY CHARGER	30	#10					2000	В	1200					#12	20	12-F0-104 (GENERATOR FUEL OIL PUMP)	10	
11 SPARE	20	#12						С	100					#12	20	MOTORIZED DAMPERS		
13 SPARE	20	#12						Α						#12	20	SPARE	1 4	
15 SPARE	20	#12						В						#12	20	SPARE	16	
17 SPARE	20	#12						С						#12	20	SPARE	1 8	
19 SPARE	20	#12						Α						#12	20	SPARE	20	
21 SPARE	20	#12						В						#12	20	SPARE	22	
23 SPARE	20	#12						С				#12 20		20	SPARE	24		
OTAL LOADS			100	360	0	0	4700		5200	0	0	0	0			TOTAL LOADS		
PANEL NOTES												LOAD CALC	LILATION (NE	C 2023 -	ARTICLE 2	220)		
A. PANELBOARDS SHALL BE FULLY RATED,	SERIES	S RATED										LOAD CALCULATION (NEC 2023 - ARTICLE LOAD TYPE LOAD(kVA) DEMAND				•	k۷	
EQUIPMENT SHALL NOT BE PERMITTED.	OLME	o mare										LIGHTING		0.10	1.25	0.1		
EQUIT MENT STIME NOT BE TERMITTED.												RECEPTACL	FS	0.36	1.00			
B. PANEL BUS SHALL BE COPPER, ALUMIN	NUM BU	S SHALL	NOT BE									The state of the s			0.50	0		
PERMITTED.												KITCHEN E	QUIPMENT	0.00	0.65	0.0	0 kW	
												MISC.		9.90	1.00	9.9	_	
												HVAC		0.00	1.00	0.0		
												TOTAL kW	DEMAND		ı	10.4		
												TOTAL DEM	TOTAL DEMAND AMPS @ 100%				3 AMF	

PANEL SCHEDULE "12-GEN" (EMERGENCY LIFE SAFETY BRANCH - 120/208 VOLTS)
SCALE NOT TO SCALE

ADDENDUM 1	08-09-2024	CONSULTANT	ARCHITECT/ENGINEER OF RECORD	STAMP	Office of	Drawing Title	Phase 100% CONSTRUCTION DOCUMENTS	Project Title SIOUX FALLS BOILER PLANT	Project Numb
				TE OF LOUISIANIA	Construction and Facilities	PANEL SCHEDULES	100% CONSTRUCTION DOCUMENTS	SIOUX FALLS BOILER PLAINT	438-22-900 Building Num 12
			> paradigm	TYLER M. MONTGOMERY LICENSE NO. 0047142	Management	Approved: Project Director		Location VAMC-Sioux Falls: 2501 W 22nd St, Sioux	Falls, SD 57105
			Architecture Engineering Design-Build 9000 Wessex Place, Louisville, KY 40222 www.paradigmusa.com	9/12/2024	U.S. Department of Veterans		FULLY SPRINKLERED	Issue Date Checked WLM	Drawn EF

TOTAL DEMAND AMPS

@ 100%

205.98 AMPS

GENERAL NOTES

BE PERMITTED.


A. NEW PANEL BOARD SHALL BE FULLY RATED, SERIES RATED PANELS


SHALL NOT BE PERMITTED. B. NEW PANEL BOARD SHALL BE COPPER BUS, ALUMINUM SHALL NOT


C. ALUMINUM BUS WITHIN PANELS SHALL NOT BE PERMITTED.


D. PANEL BOARDS EXCEEDING (42) CIRCUITS SHALL BE FROM A SINGLE BUS CONFIGURATION, MULTIPLE BUS CONFIGURATIONS SHALL NOT BE PERMITTED.

E. ALL ELECTRICAL PANELS SHALL HAVE VISIBLE TRIP INDICATORS.

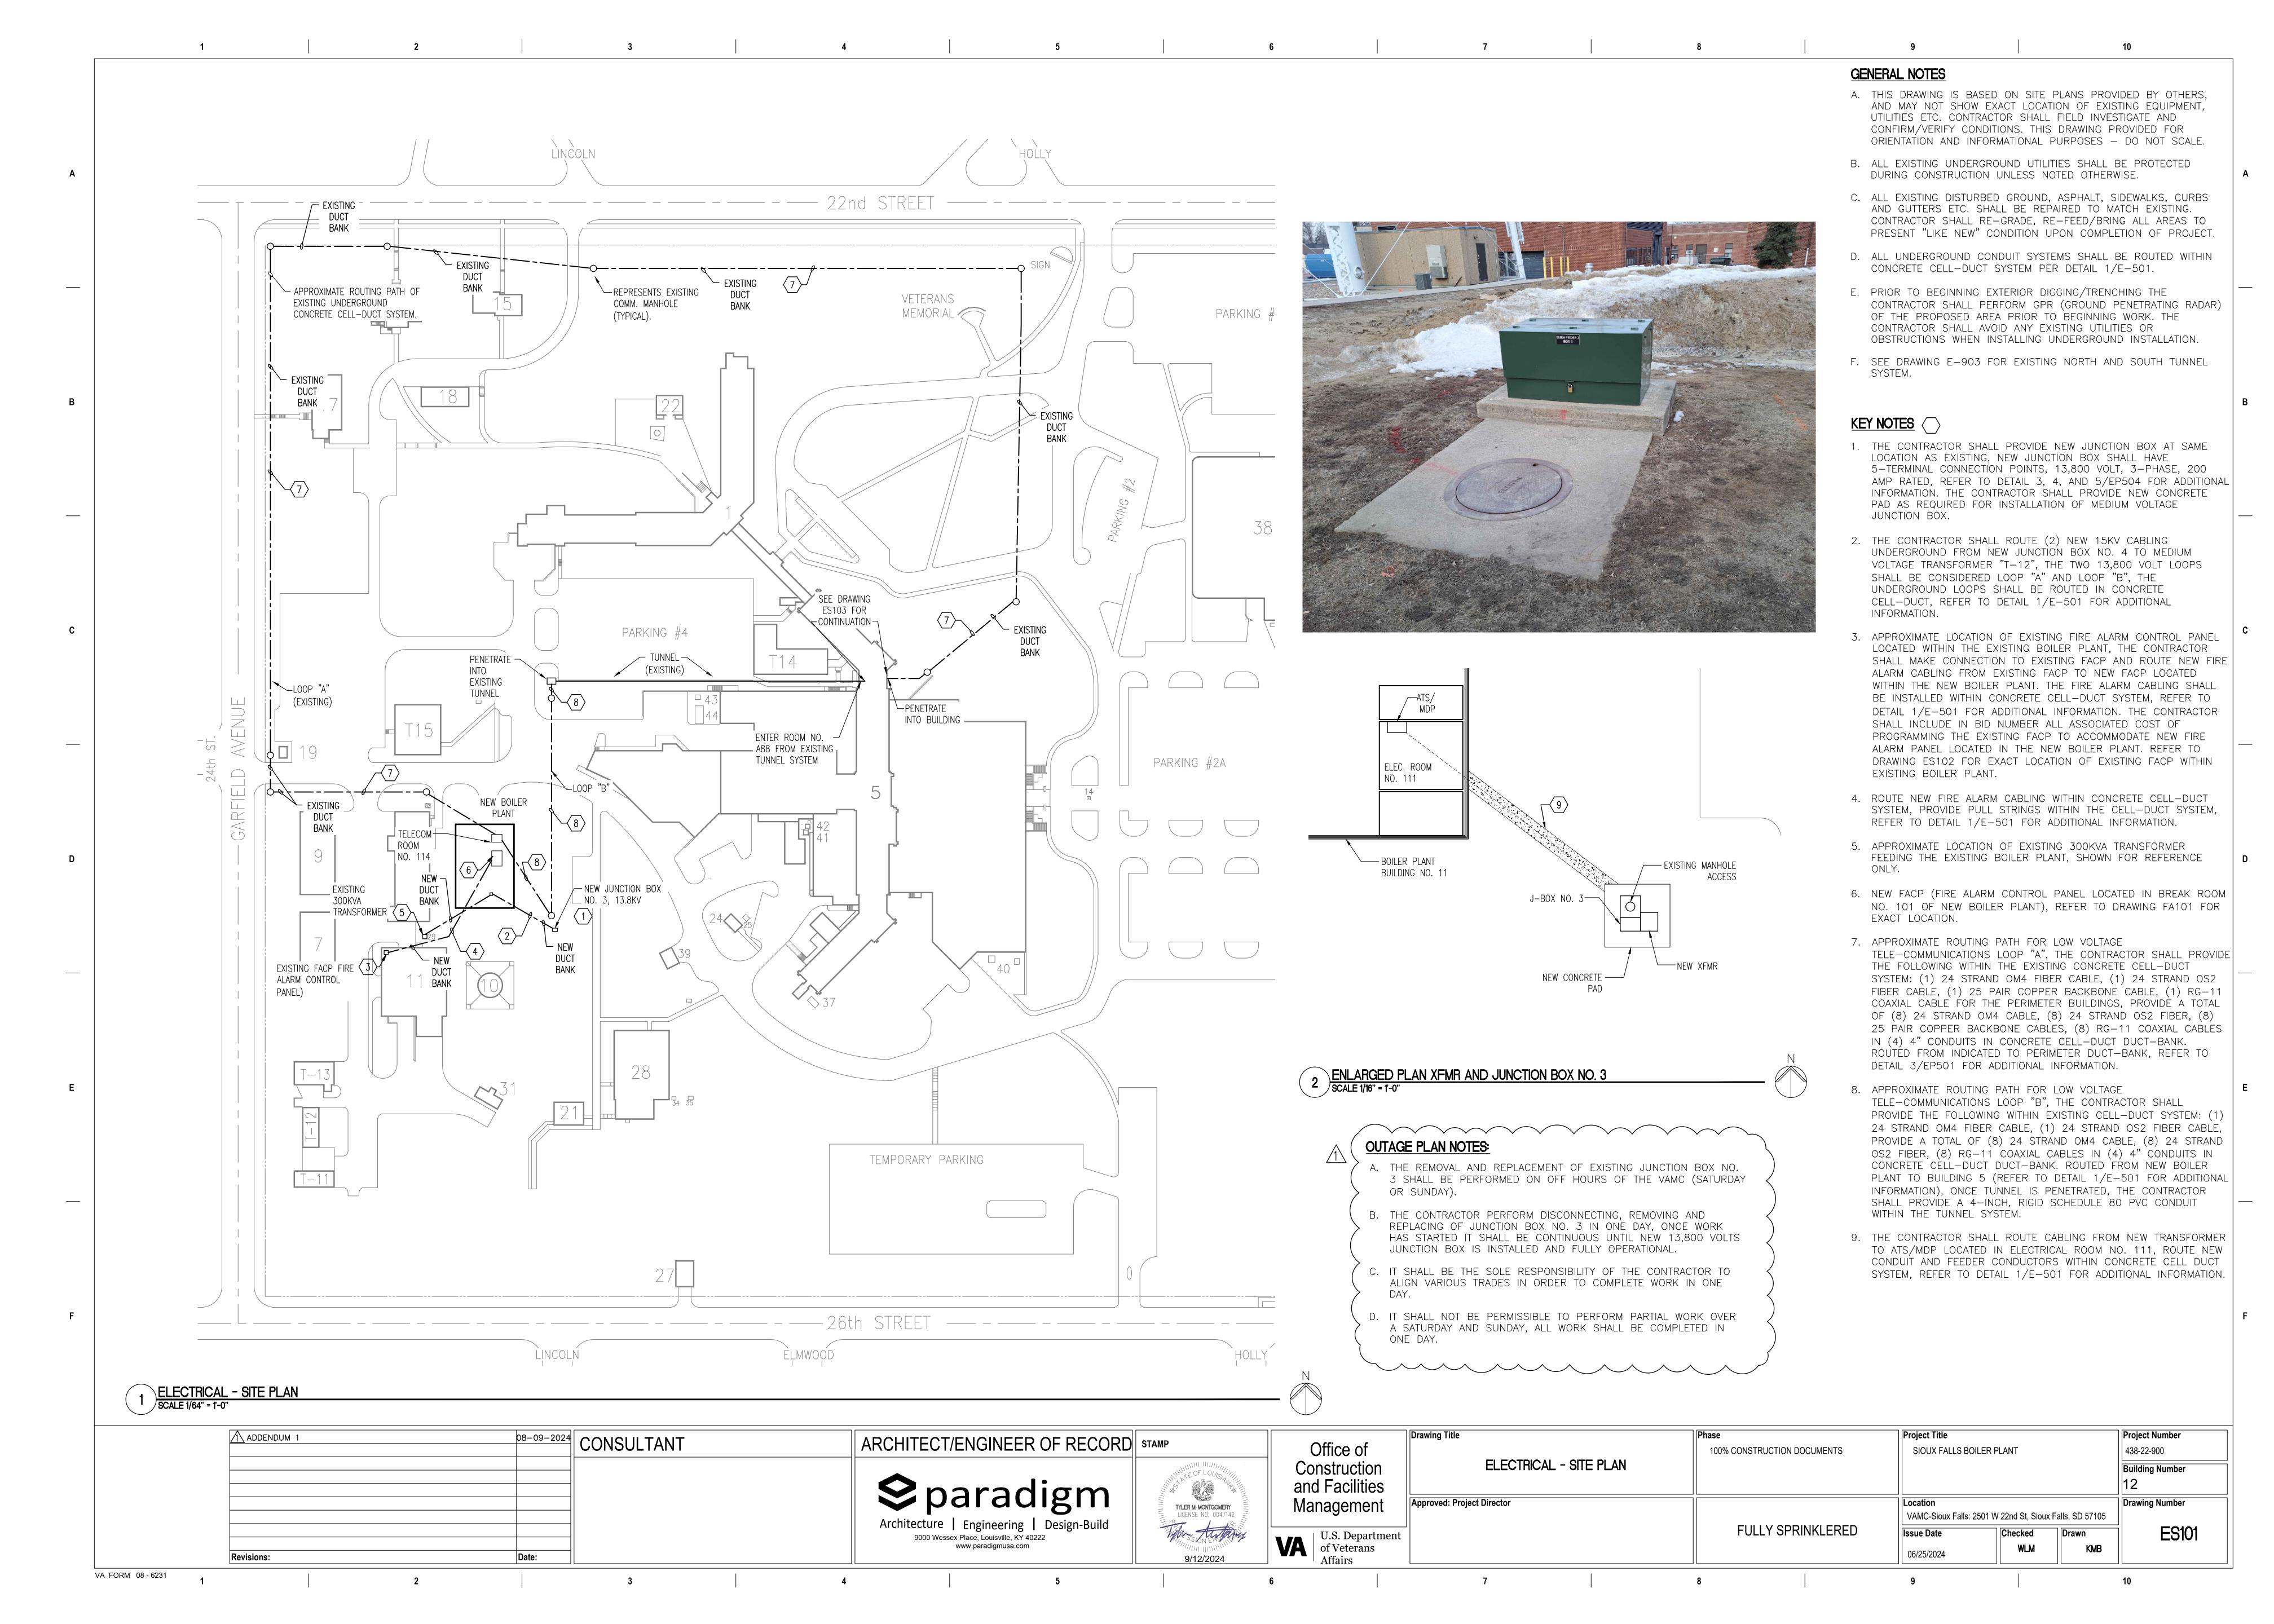


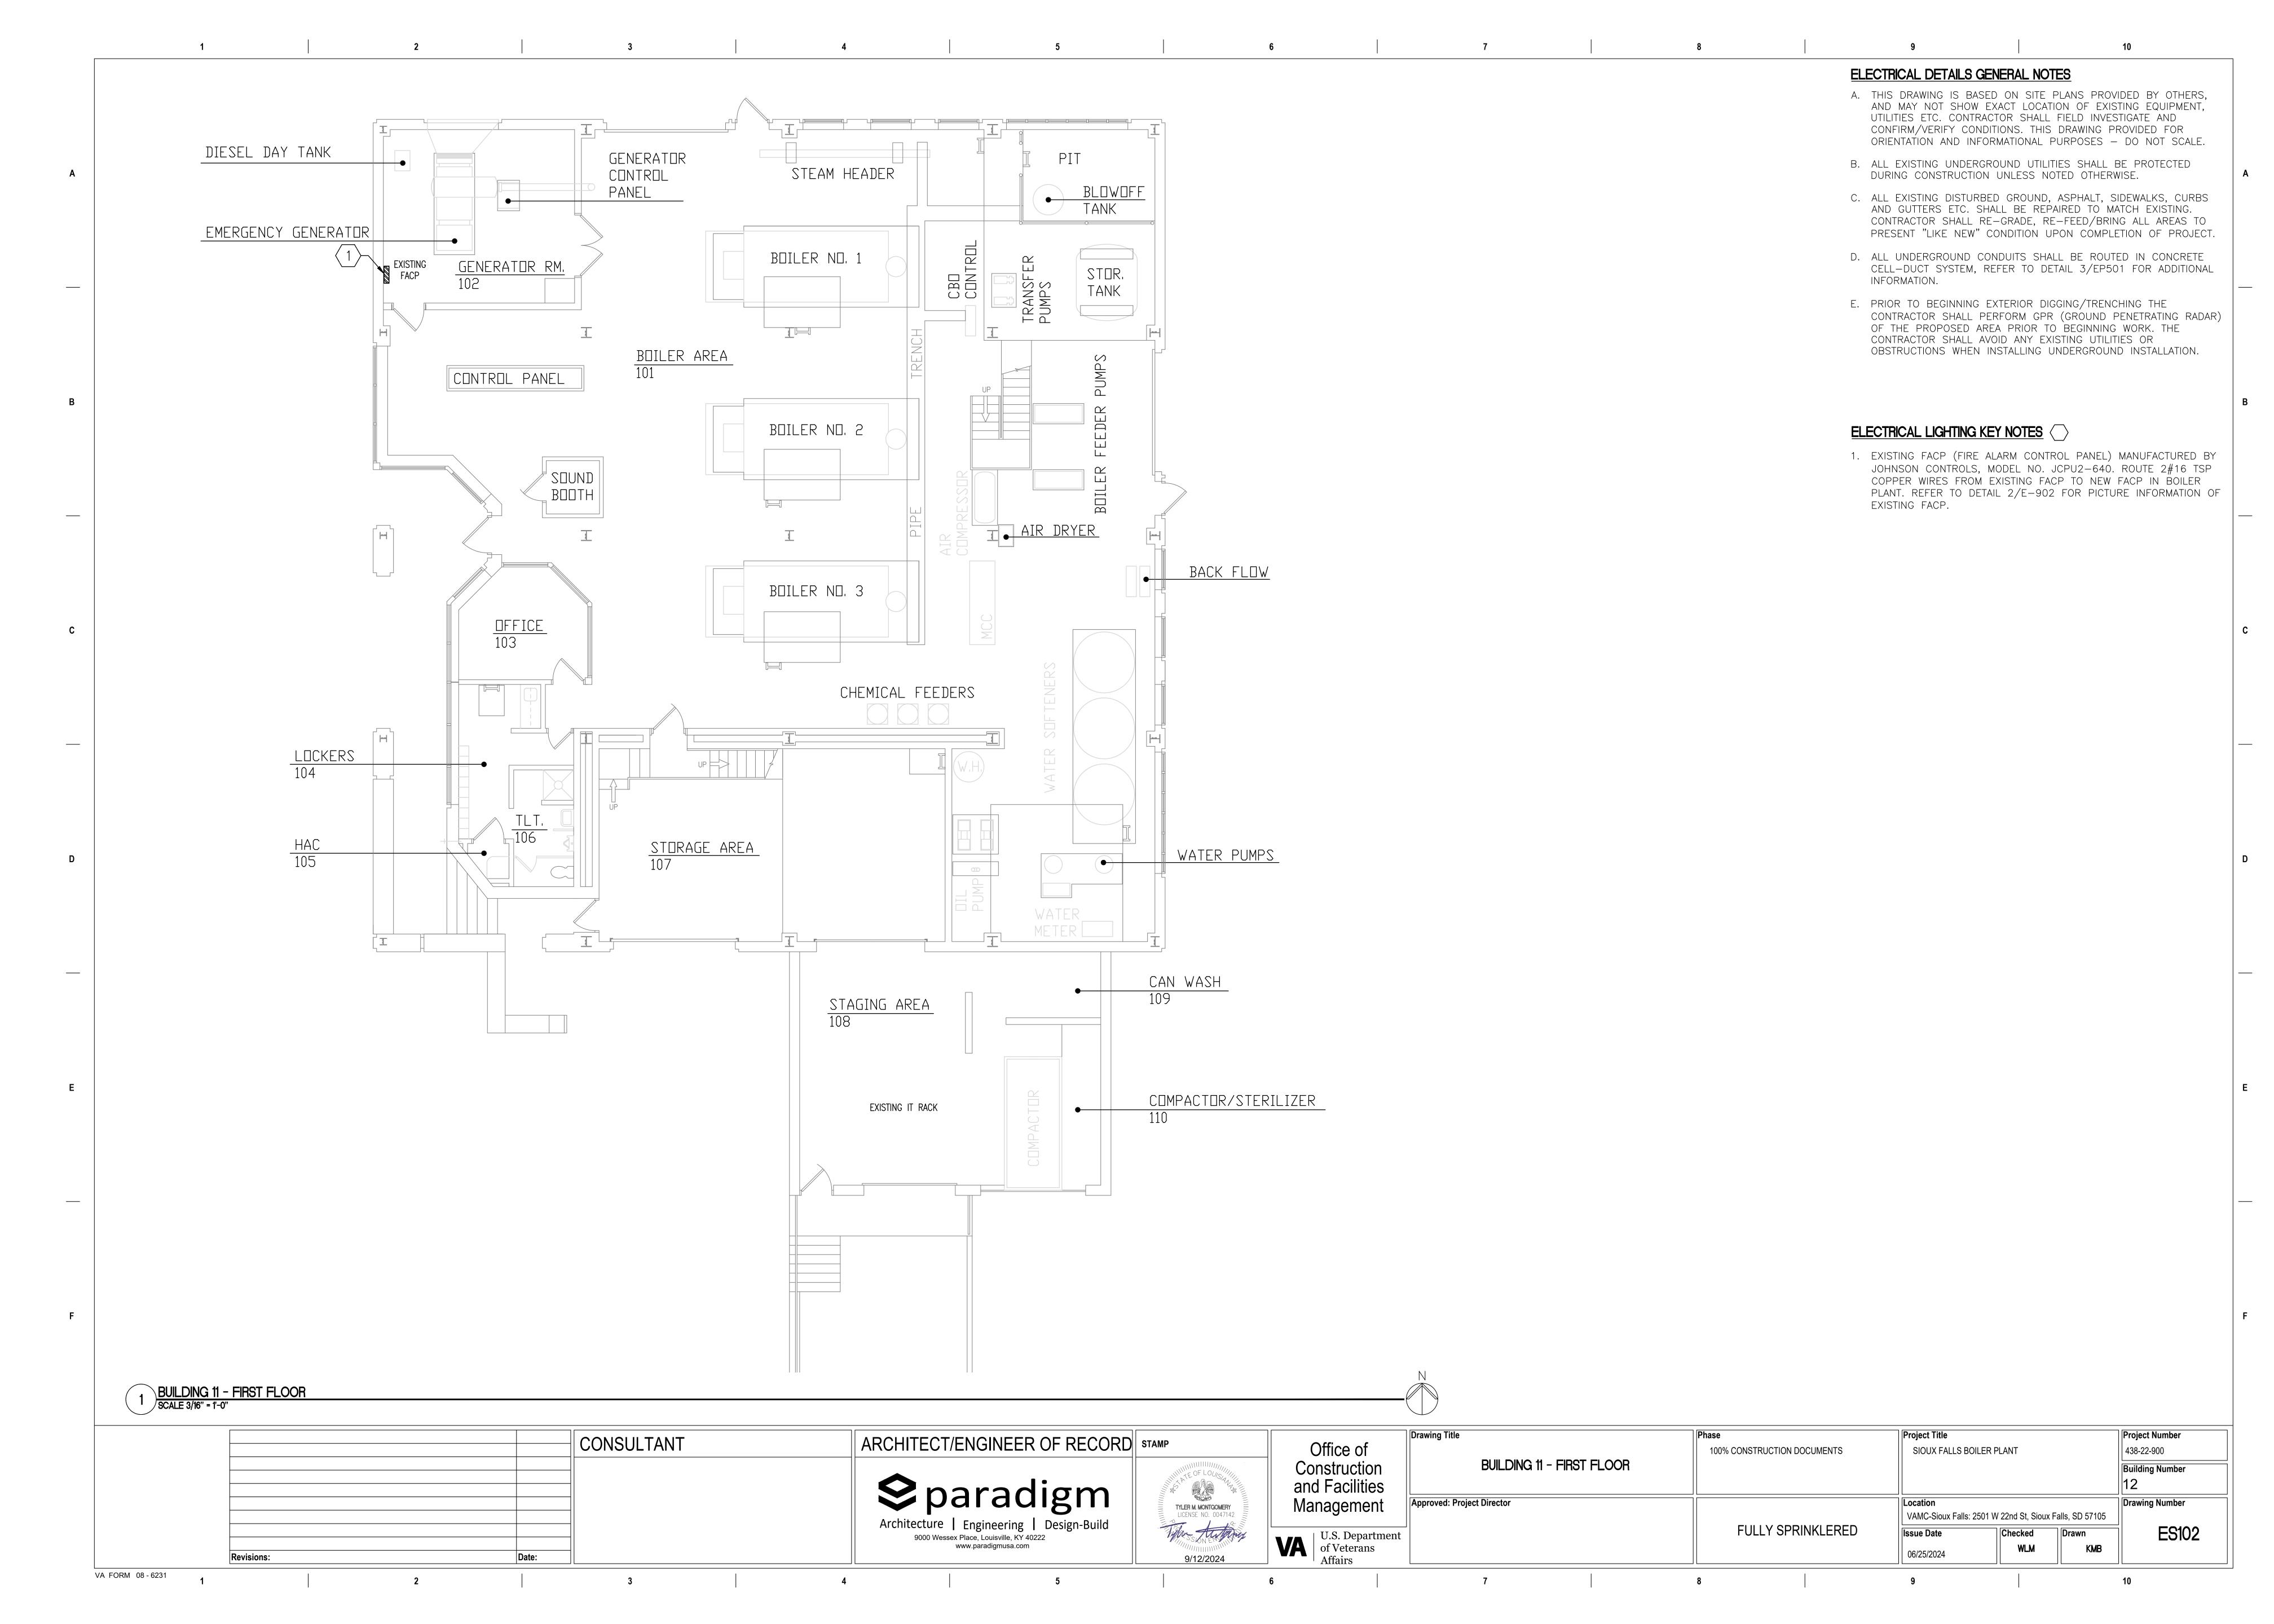

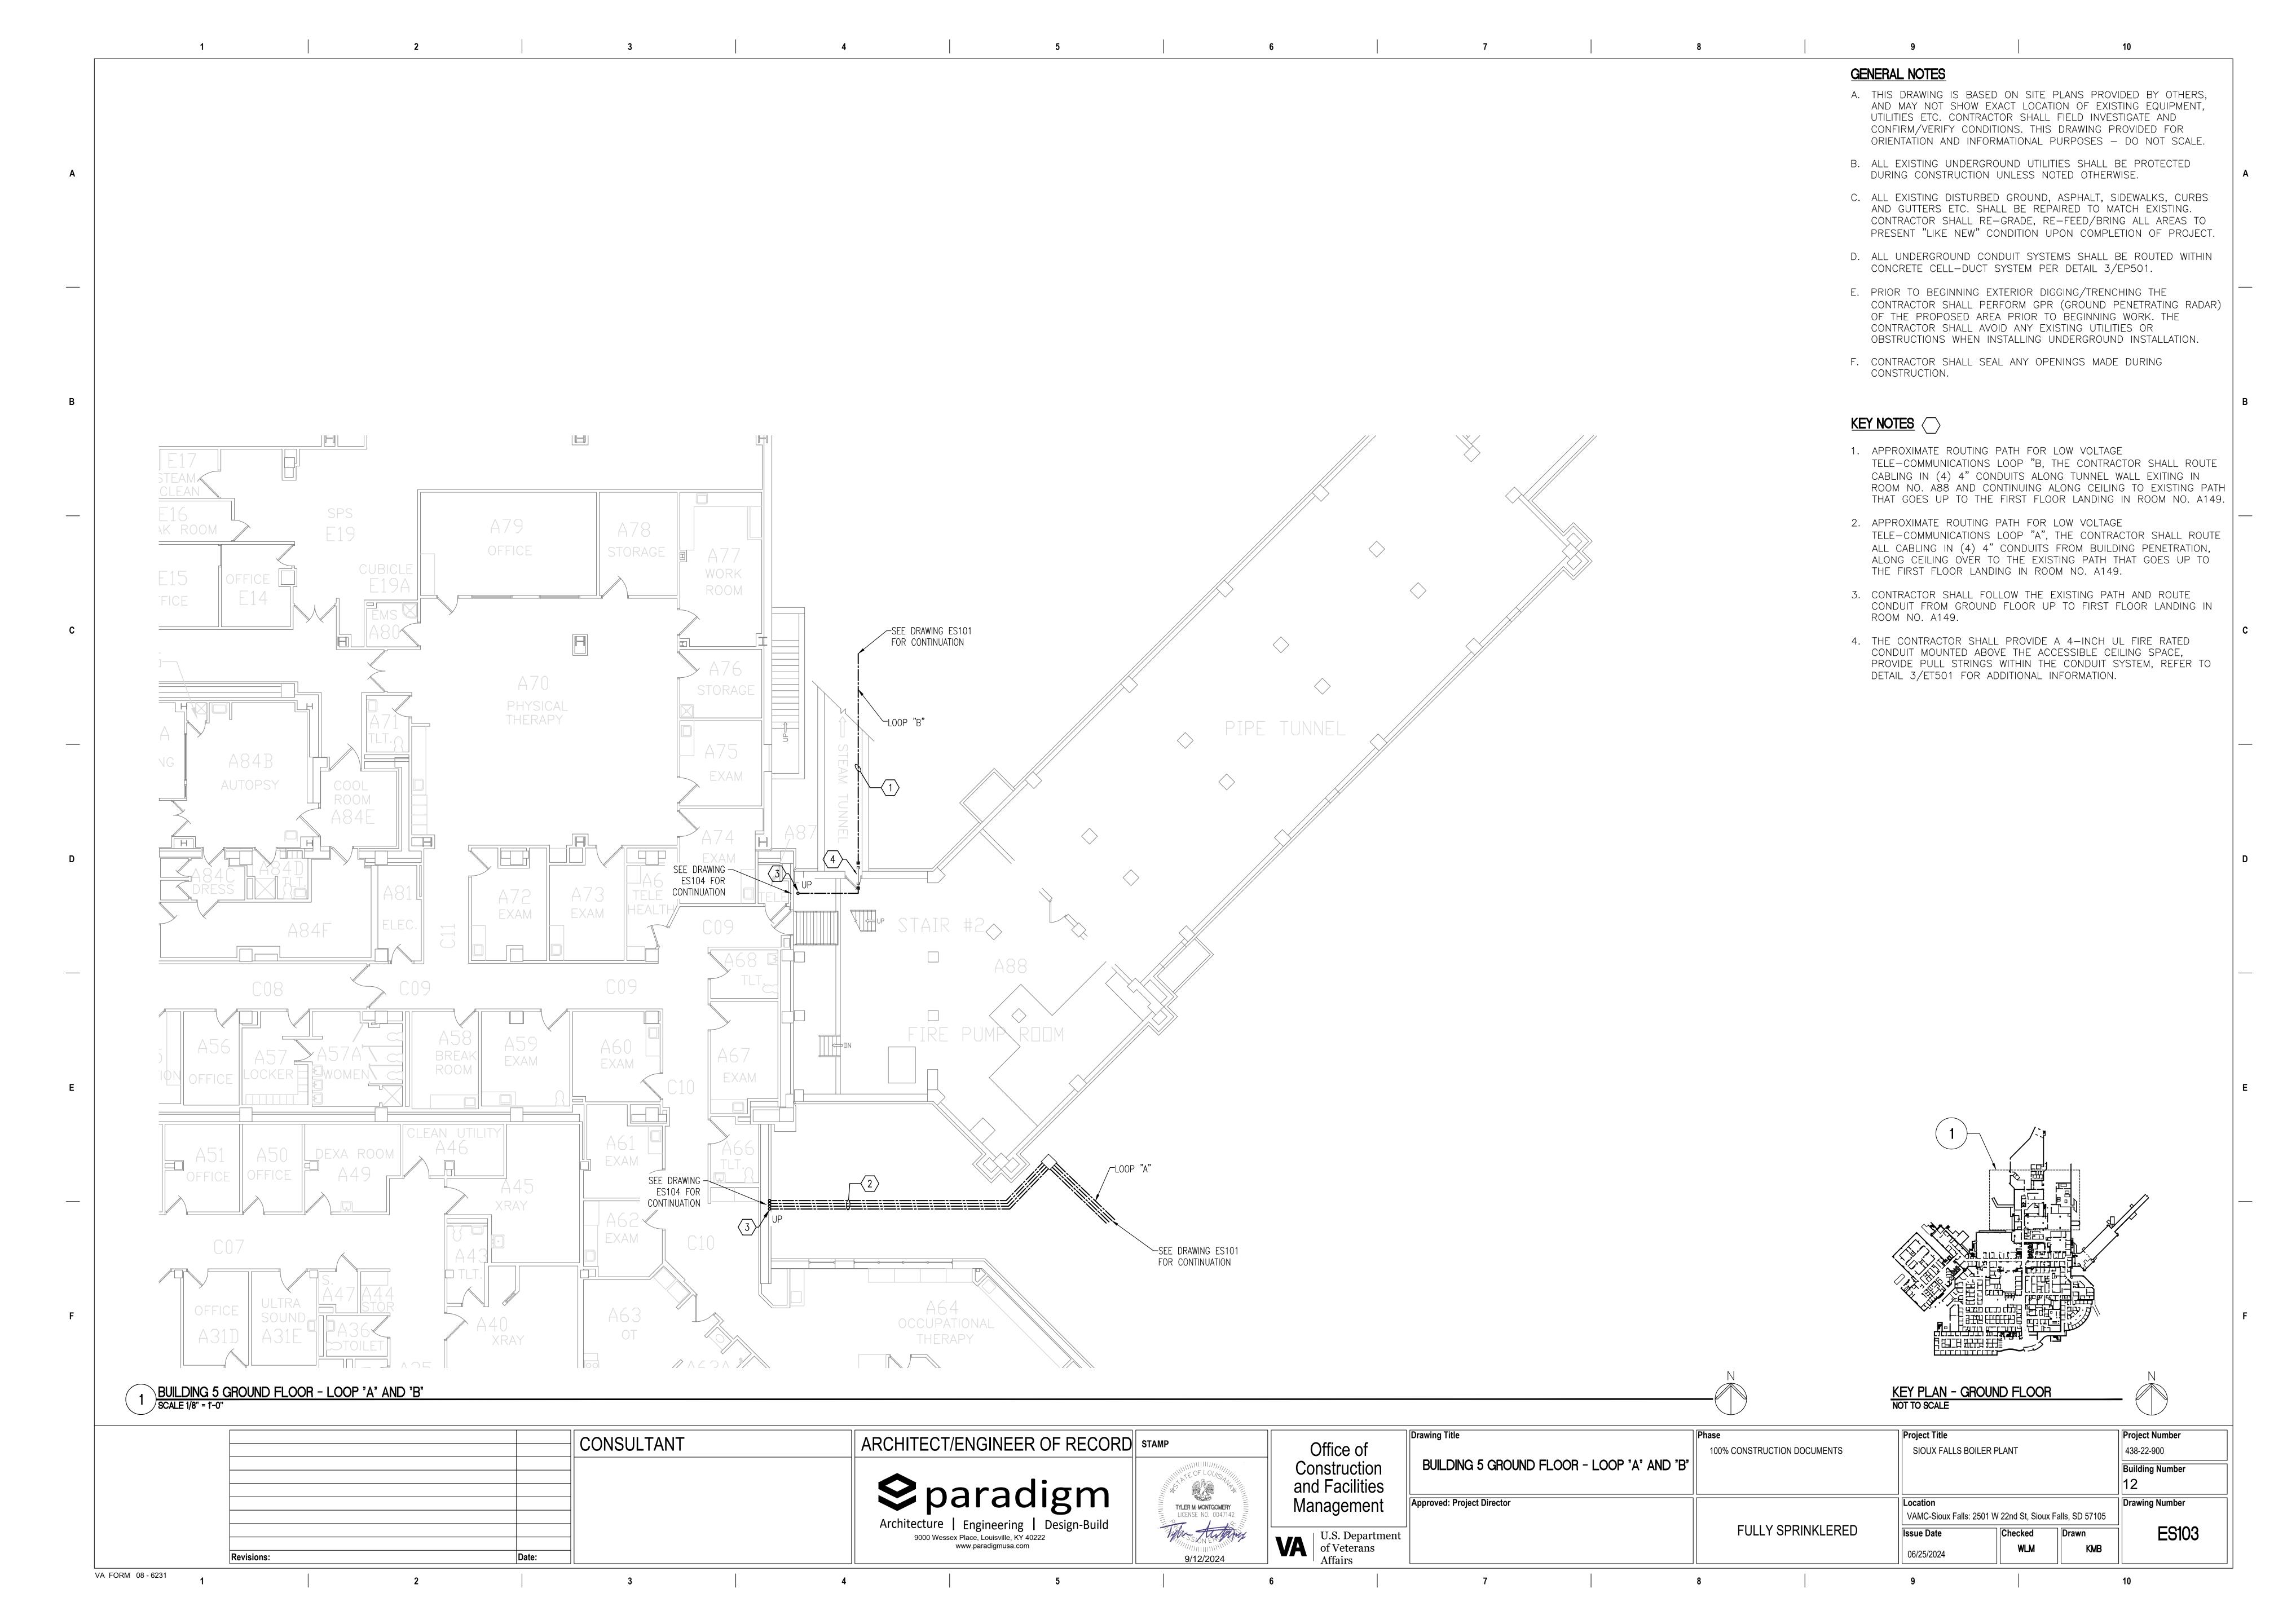

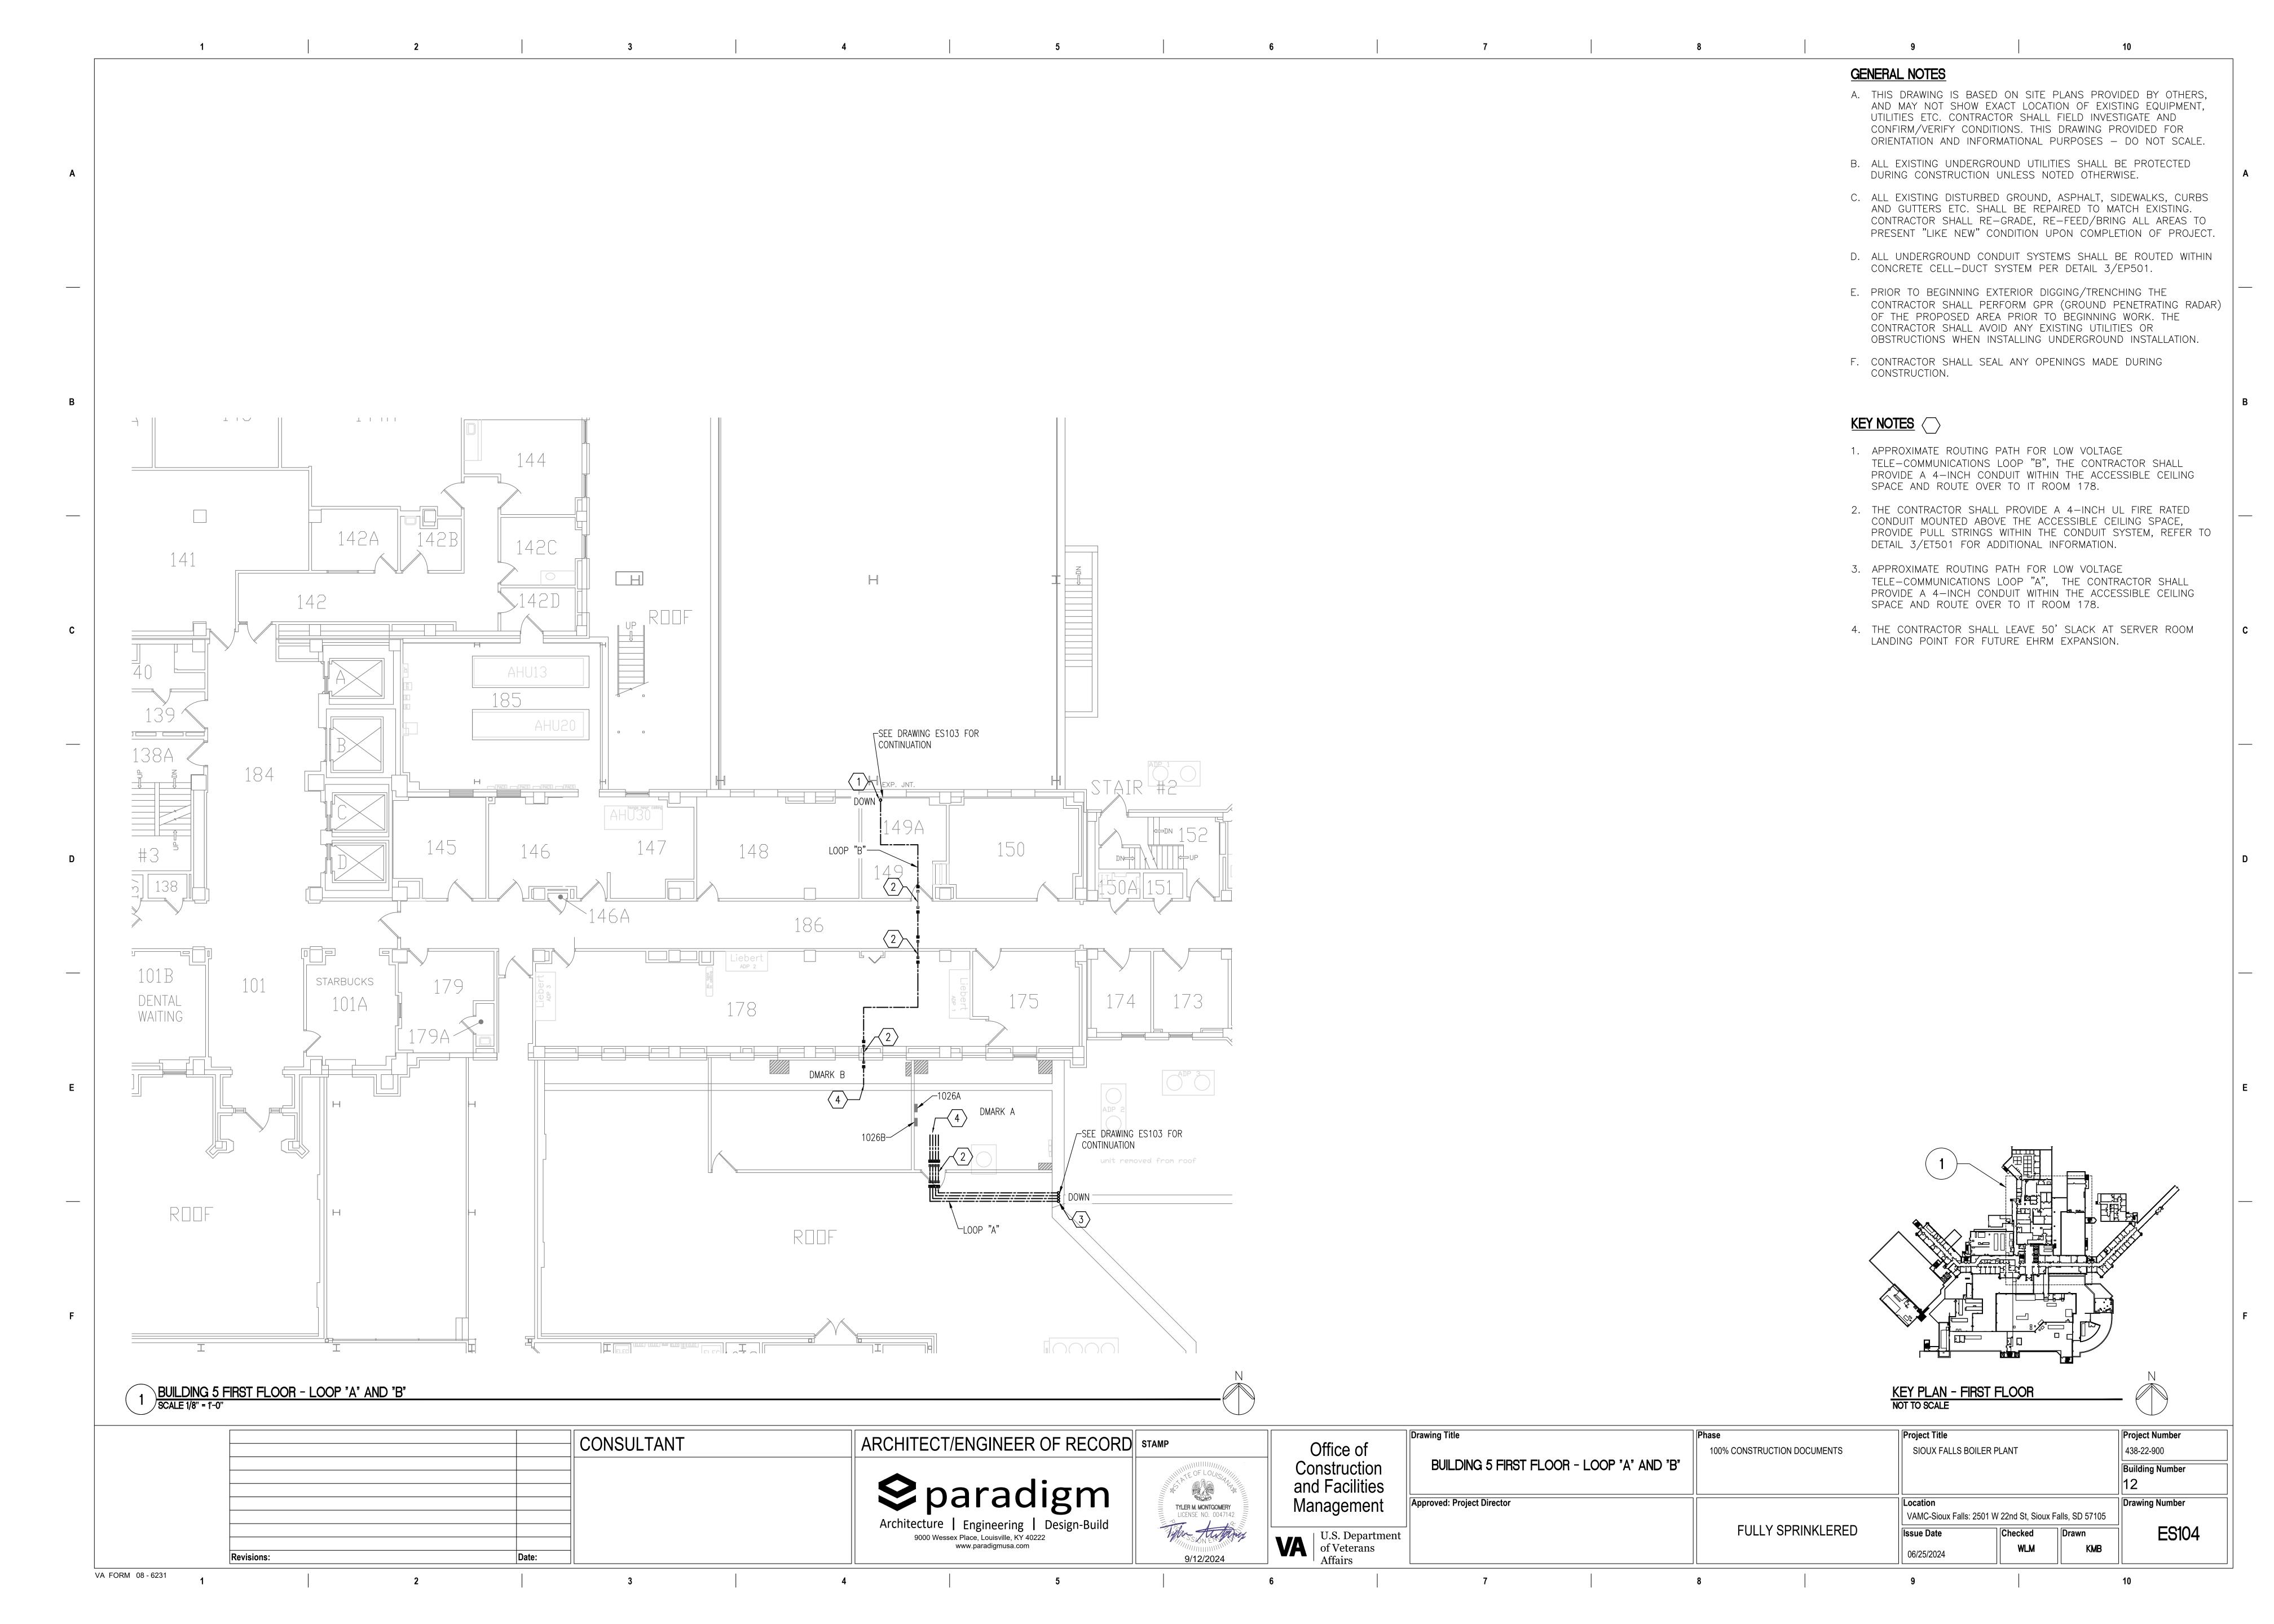

GENERAL NOTES A. THIS DRAWING IS BASED ON SITE PLANS PROVIDED BY OTHERS, AND MAY NOT SHOW EXACT LOCATION OF EXISTING EQUIPMENT, UTILITIES ETC. CONTRACTOR SHALL FIELD INVESTIGATE AND CONFIRM/VERIFY CONDITIONS. THIS DRAWING PROVIDED FOR ORIENTATION AND INFORMATIONAL PURPOSES - DO NOT SCALE. B. ALL EXISTING UNDERGROUND UTILITIES SHALL BE PROTECTED DURING CONSTRUCTION UNLESS NOTED OTHERWISE. C. ALL EXISTING DISTURBED GROUND, ASPHALT, SIDEWALKS, CURBS AND GUTTERS ETC. SHALL BE REPAIRED TO MATCH EXISTING. CONTRACTOR SHALL RE-GRADE, RE-FEED/BRING ALL AREAS TO PRESENT "LIKE NEW" CONDITION UPON COMPLETION OF PROJECT. D. ALL UNDERGROUND CONDUIT SYSTEMS SHALL BE ROUTED WITHIN CONCRETE CELL-DUCT SYSTEM PER DETAIL 3/EP501. E. PRIOR TO BEGINNING EXTERIOR DIGGING/TRENCHING THE CONTRACTOR SHALL PERFORM GPR (GROUND PENETRATING RADAR) OF THE PROPOSED AREA PRIOR TO BEGINNING WORK. THE CONTRACTOR SHALL AVOID ANY EXISTING UTILITIES OR OBSTRUCTIONS WHEN INSTALLING UNDERGROUND INSTALLATION. F. CONTRACTOR SHALL SEAL ANY OPENINGS MADE DURING CONSTRUCTION. KEY NOTES 1. XXXXX 12-LN2-76 GFI KEY PLAN - GROUND FLOOR NOT TO SCALE 1 NEW TUNNEL PLAN
SCALE 3/16" = 1'-0" Drawing Title Project Title Project Number CONSULTANT ARCHITECT/ENGINEER OF RECORD STAMP Office of 438-22-900 100% CONSTRUCTION DOCUMENTS SIOUX FALLS BOILER PLANT NEW TUNNEL PLAN Construction and Facilities **Building Number** Approved: Project Director Drawing Number Management Location TYLER M. MONTGOMERY
LICENSE NO. 0047142 VAMC-Sioux Falls: 2501 W 22nd St, Sioux Falls, SD 57105 Architecture | Engineering | Design-Build
9000 Wessex Place, Louisville, KY 40222
www.paradigmusa.com **FULLY SPRINKLERED** ES105 U.S. Department of Veterans Affairs Issue Date Checked WLM KMB 06/25/2024 Revisions: VA FORM 08 - 6231

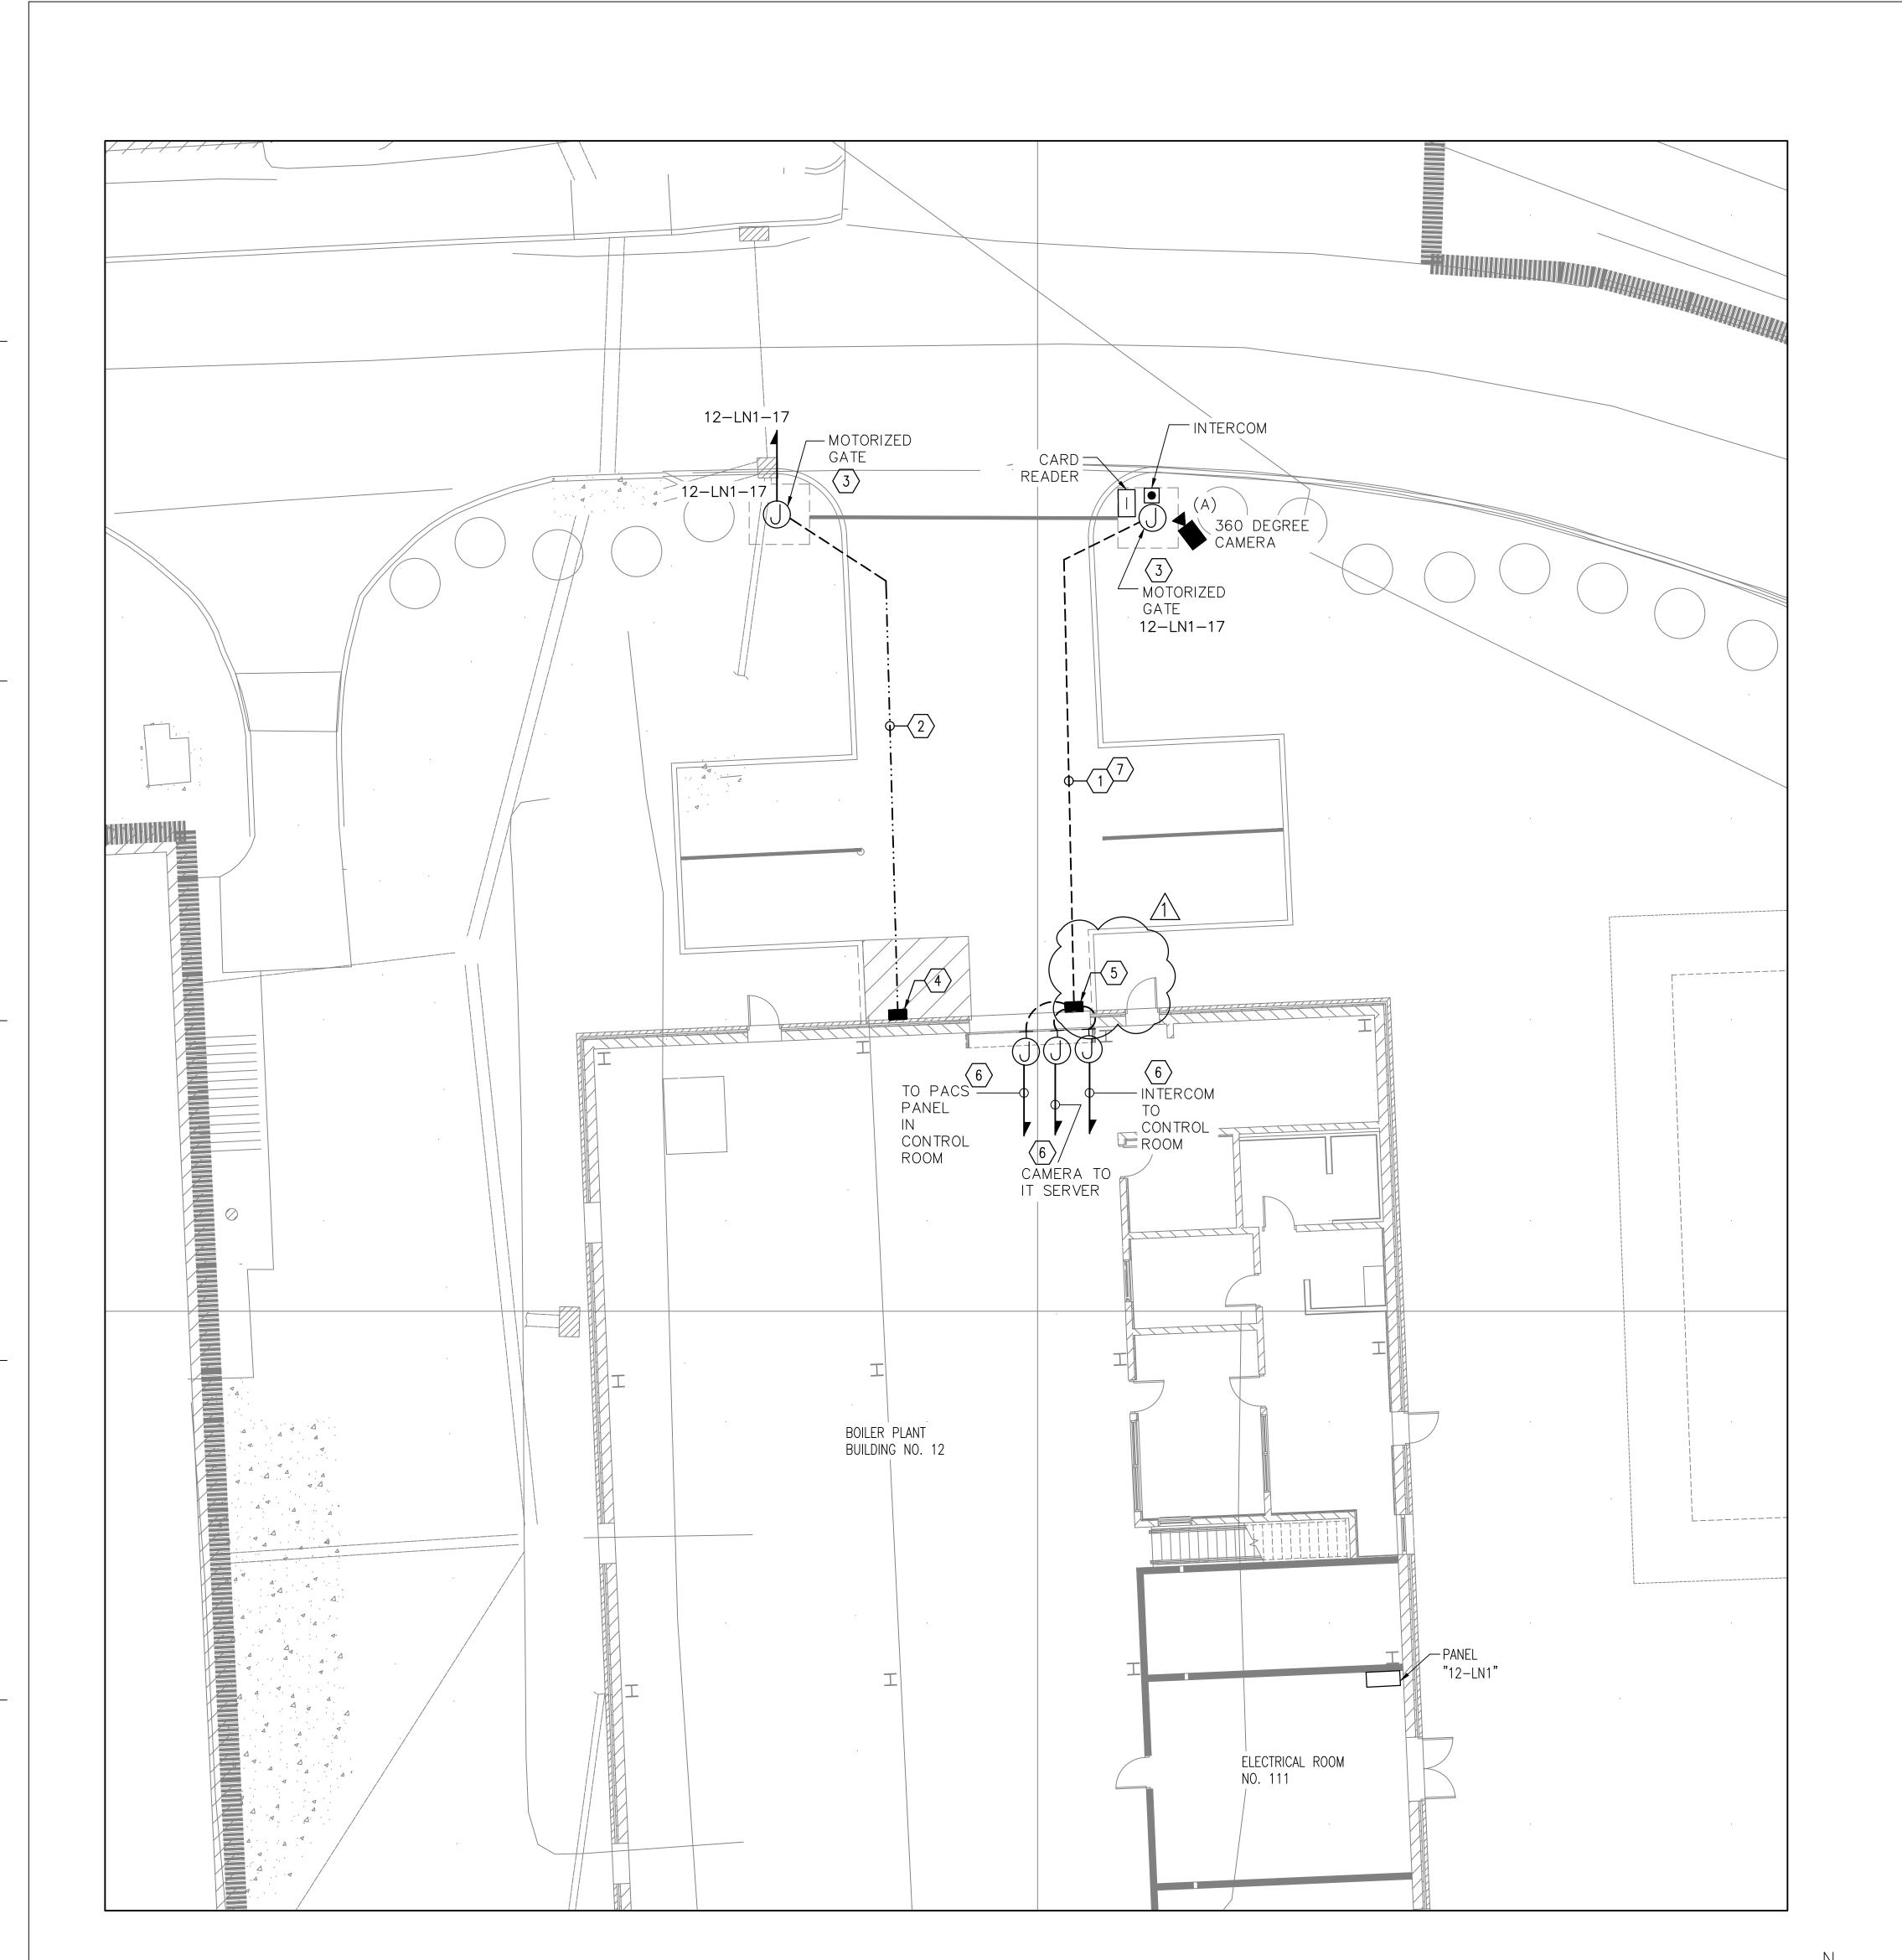

O8-09-2024 CONSULTANT

ELECTRICAL - SECURITY GATE PLAN SCALE 1/8" = 1'-0"

Revisions:

VA FORM 08 - 6231

ADDENDUM 1

MANUFACTURER AND MODEL NUMBER

MODEL NO. Q6100-E AND Q6135-LE.

CAMERA MANUFACTURED BY AXIS,

CAMERA MANUFACTURED BY AXIS,

CAMERA MANUFACTURED BY AXIS,

MODEL NO. 1P3719-PLE AND

MODEL NO. 1P3719-PLE.

SYSTEMS LEGEND

- CARD ACCESS READER
- DOOR CONTACT INTRUSION DETECTION SYSTEM.
- INTERCOM

NOTE: WIRING SHALL BE IN EMT (ELECTRICAL METALLIC

SECURITY GATE PLAN KEY NOTES

COMPLETE SYSTEM.

RADAR) AT SITE PRIOR TO DIGGING.

SITE PLAN GENERAL NOTES

1. PROVIDE 1 1/2" RIGID STEEL CONDUIT BURIED UNDERGROUND WITH PULL STRINGS.

A. THIS DRAWING IS BASED ON SITE PLANS PROVIDED BY OTHERS, AND MAY NOT SHOW EXACT LOCATION OF EXISTING EQUIPMENT, UTILITIES, ETC. CONTRACTOR SHALL FIELD INVESTIGATE AND

FOR ORIÉNTATION AND INFORMATIONAL PURPOSES — DO NOT

B. THE ROUTING PATH OF UNDERGROUND CONDUITS AND CONCRETE

C. THE CONTRACTOR SHALL PERFORM GPR (GROUND PENETRATING

E. THE CONTRACTOR SHALL INCLUDE PULL STRINGS WITHIN CONDUIT

F. THE GENERAL CONTRACTOR SHALL BE RESPONSIBLE FOR PROVIDING

THE INTERCOM SYSTEM AND ALL ACCESSORIES REQUIRED FOR A

D. ALL CAMERAS SHALL BE 360 DEGREE OF COVERAGE.

CONFIRM/VERIFY EXISTING CONDITIONS. THIS DRAWING PROVIDED

CELL-DUCT SYSTEMS SHALL BE THE SOLE RESPONSIBILITY OF THE CONTRACTOR TO COORDINATE EXACT ROUTING PATHS WITH OTHER

- 2. PROVIDE 3/4" RIGID STEEL CONDUIT BURIED UNDERGROUND WITH PULL STRINGS.
- 3. PROVIDE 120 VOLT POWER TO MOTORIZED GATE, ROUTE 3/4" RIGID STEEL CONDUIT UNDERGROUND TO PANEL AS INDICATED.
- 4. THE CONTRACTOR SHALL ROUTE 3/4" RIGID STEEL CONDUIT UNDERGROUND FROM SECURITY GATE TO PANEL AS INDICATED.
- 5. PROVIDE 1 1/4" STAINLESS STEEL "LB" MOUNTED ON SIDE OF BUILDING.
- 6. MOUNT ALONG CEILING TO DESIGNATED LOCATION AS INDICATED.
- 7. THE CONTRACTOR SHALL ROUTE CATEGORY 6a CABLING FOR CAMERA WITHIN CONDUIT SYSTEM.

CAMERA MANUFACTURED BY AXIS, MODEL NO. P3265-LVE. CAMERA MANUFACTURED BY AXIS, MODEL NO. M3058—PLVE.

M3048-PLVE.

2 CAMERA LEGEND NOT TO SCALE

360°

360°

ARCHITECT/ENGINEER OF RECORD | STAMP 9000 Wessex Place, Louisville, KY 40222 www.paradigmusa.com

Office of Construction and Facilities TYLER M. MONTGOMERY
LICENSE NO. 0047142 | U.S. Department of Veterans
Affairs

Drawing Title **Approved: Project Director**

ELECTRICAL - SECURITY GATE PLAN


Project Title SIOUX FALLS BOILER PLANT 100% CONSTRUCTION DOCUMENTS Location VAMC-Sioux Falls: 2501 W 22nd St, Sioux Falls, SD 57105 **FULLY SPRINKLERED** Issue Date Checked WLM KMB 06/25/2024


Project Number

Building Number

Drawing Number

ES106

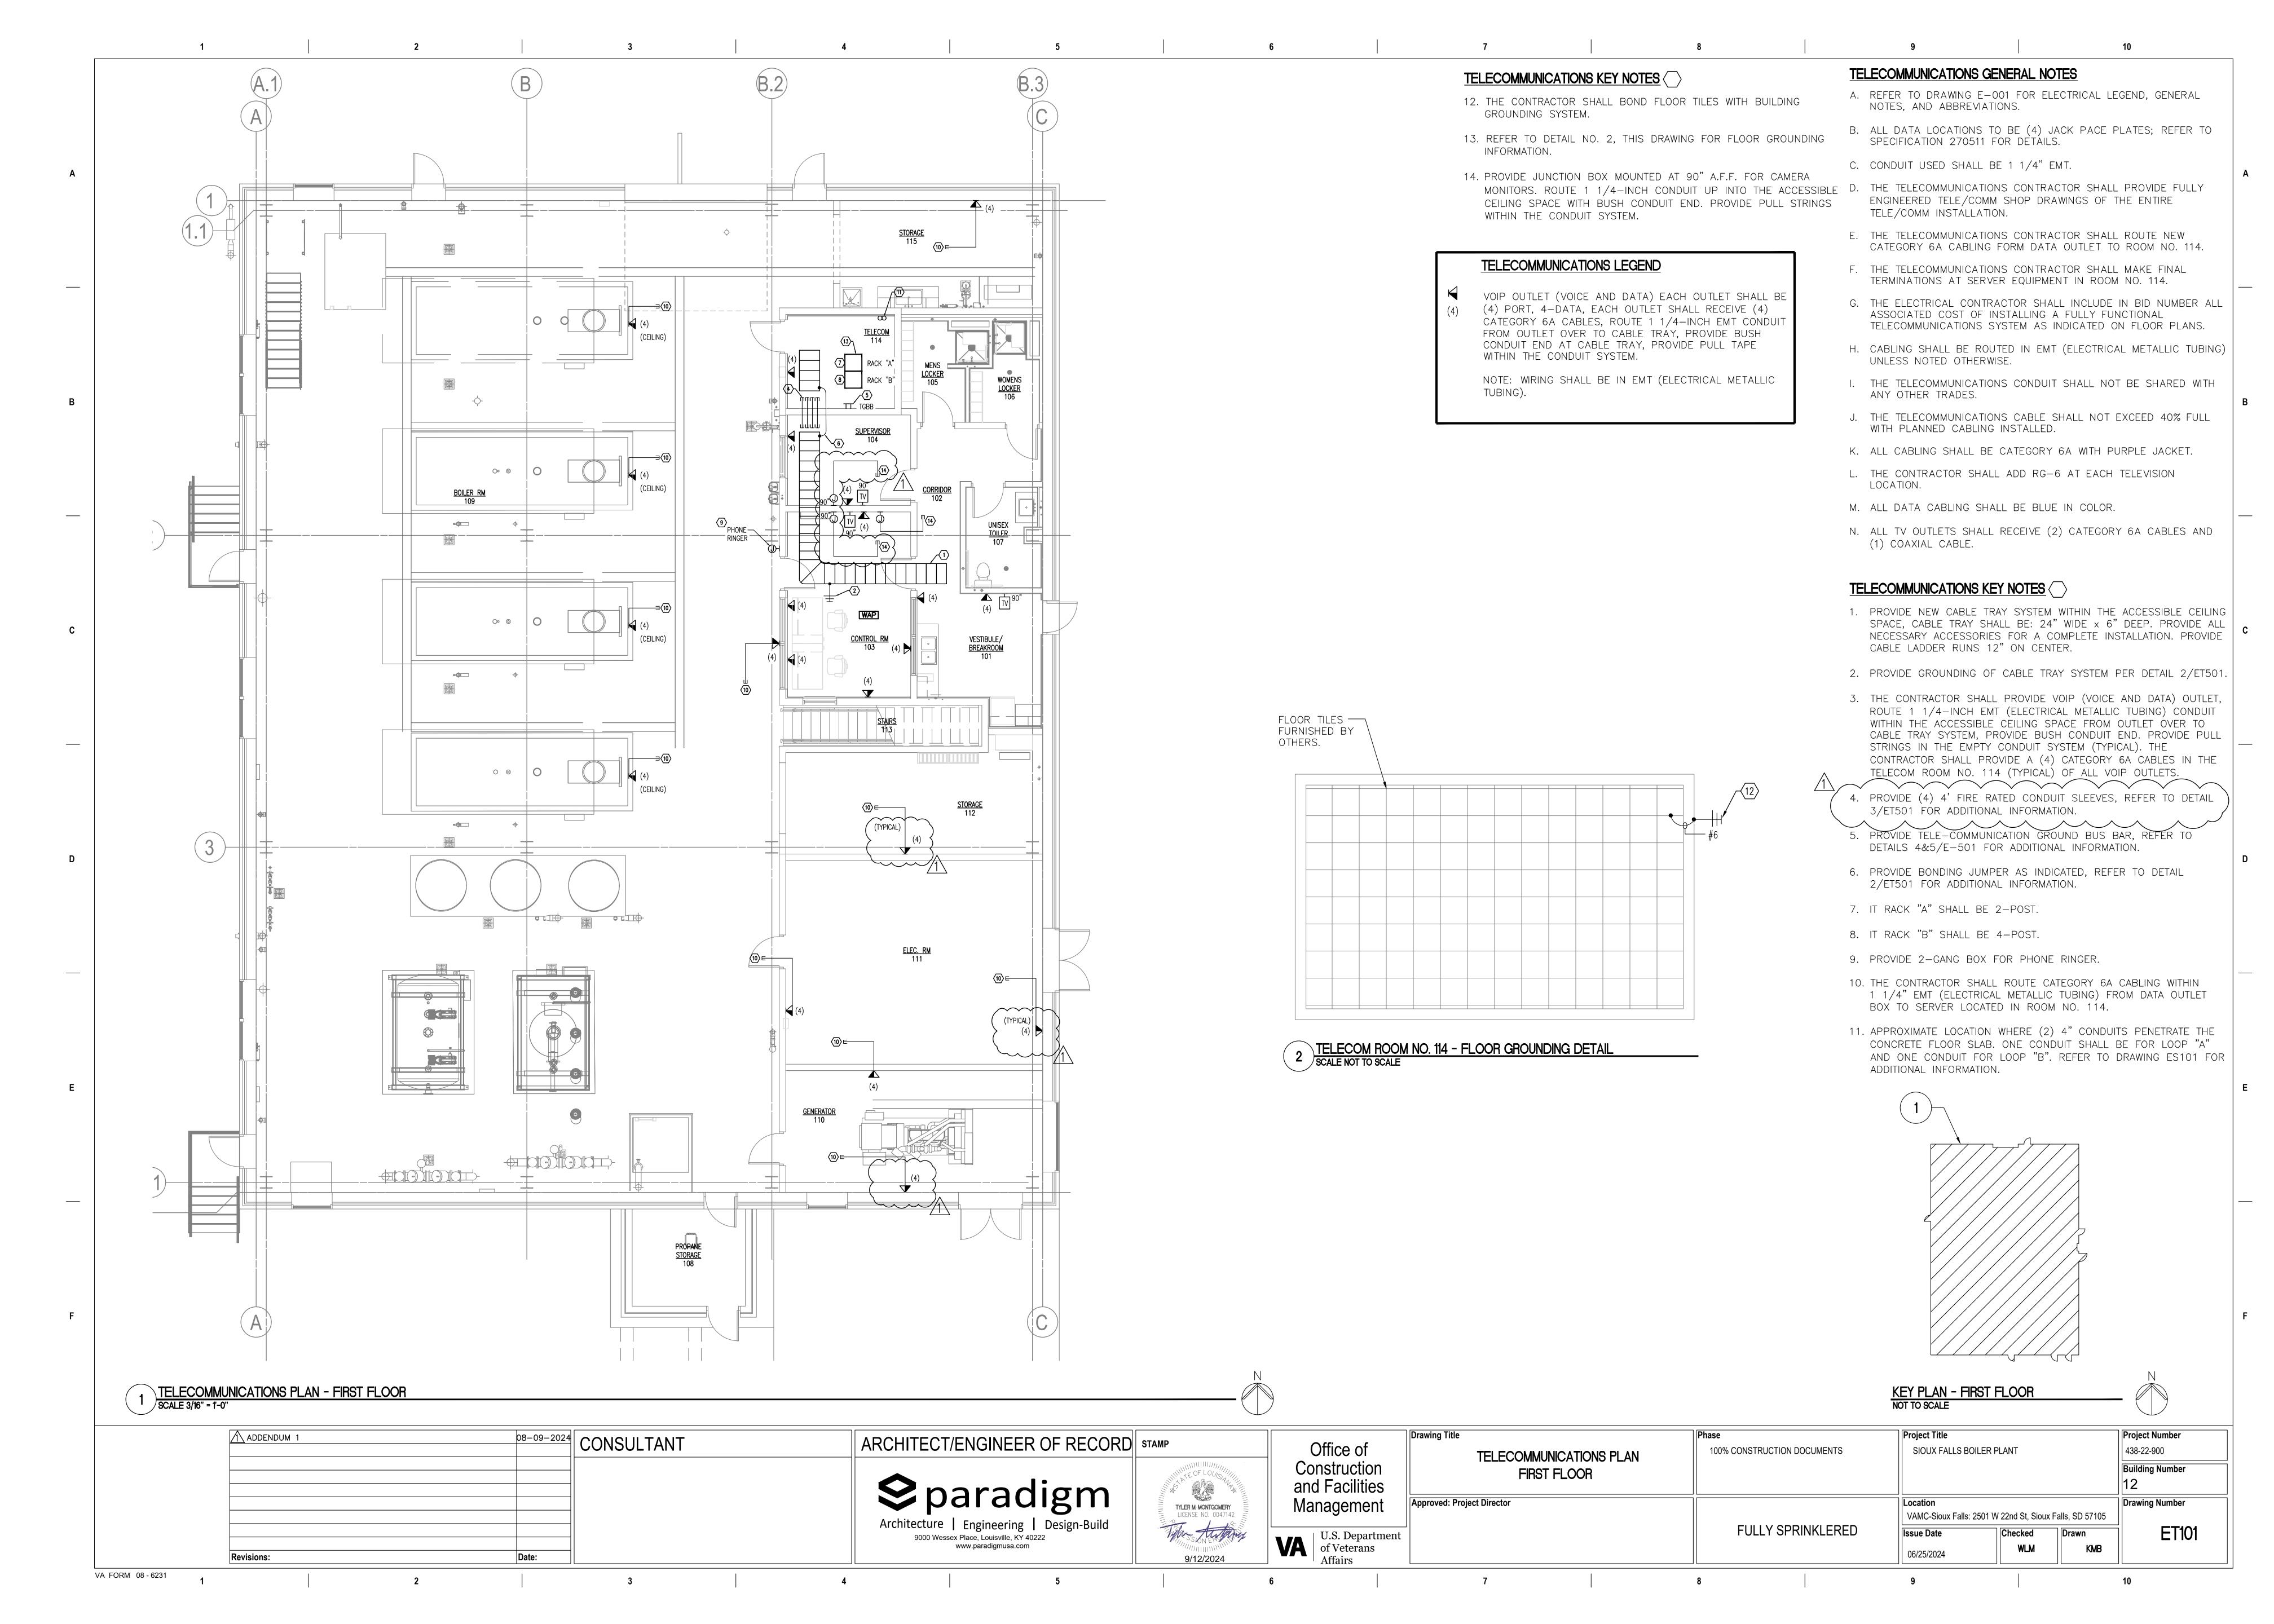

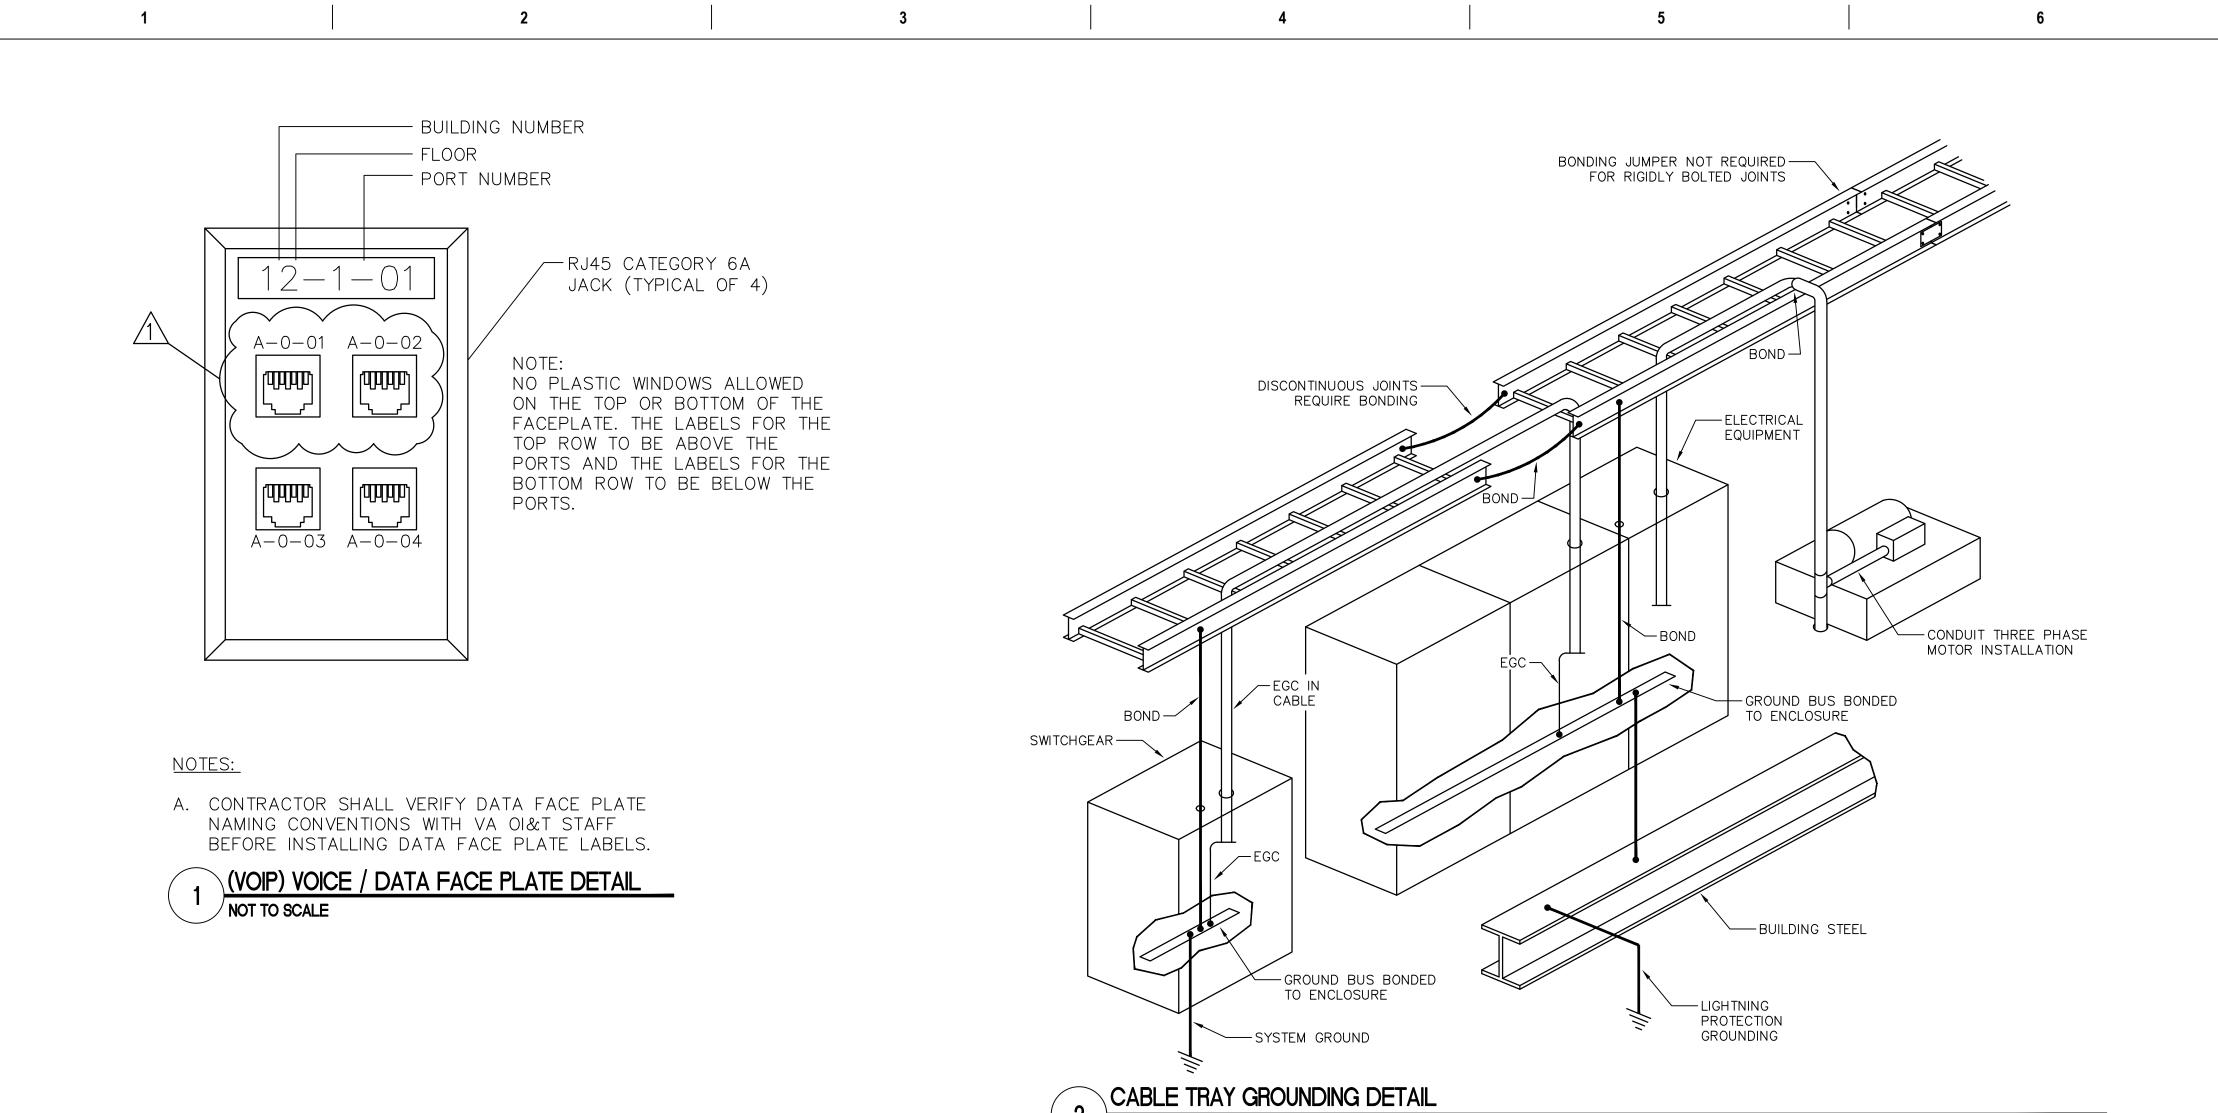





FIRE RATED CONDUIT SLEEVE (BASIS OF DESIGN)

GENERAL ELECTRICAL TELECOMMUNICATIONS PLAN NOTES

- A. REFER TO DRAWING E-001 FOR ELECTRICAL LEGEND, GENERAL NOTES, AND ABBREVIATIONS.
- B. ALL PHONE/DATA LOCATIONS TO BE (4) JACK PACE PLATES; REFER TO SPECIFICATION 270511 FOR DETAILS.
- C. ALL CABLE TRAYS TO BE 24" WIDE AND 6" DEEP UNLESS NOTED OTHERWISE.
- D. CONDUIT USED SHALL BE 1 1/4" EMT.
- E. PROVIDE GROUNDING SYSTEM PER NEC 250.96.
- F. THE CONTRACTOR SHALL COORDINATE AND PROVIDE A COMPLETE ASSEMBLY INCLUDING MOUNTING BRACKETS, THREADED RODS, MOUNTING ASSEMBLIES, RADIUS FITTINGS AND ALL OTHER FOR A COMPLETE INSTALLATION OF THE NEW CABLE TRAY SYSTEM.
- G. THE TELECOMMUNICATIONS CONTRACTOR SHALL PROVIDE FULLY ENGINEERED TELE/COMM SHOP DRAWINGS OF THE ENTIRE TELE/COMM INSTALLATION.
- H. THE TELECOMMUNICATIONS CONTRACTOR SHALL ROUTE NEW TELE/COMM CATEGORY 6 CABLING FORM DATA OUTLETS TO NEW OI&T ROOM NO.S 543 OR 341.
- I. THE SHOP DRAWING SUBMITTALS SHALL BE SIGNED BY A LICENSED RCDD (REGISTERED COMMUNICATIONS DISTRIBUTION DESIGNER)

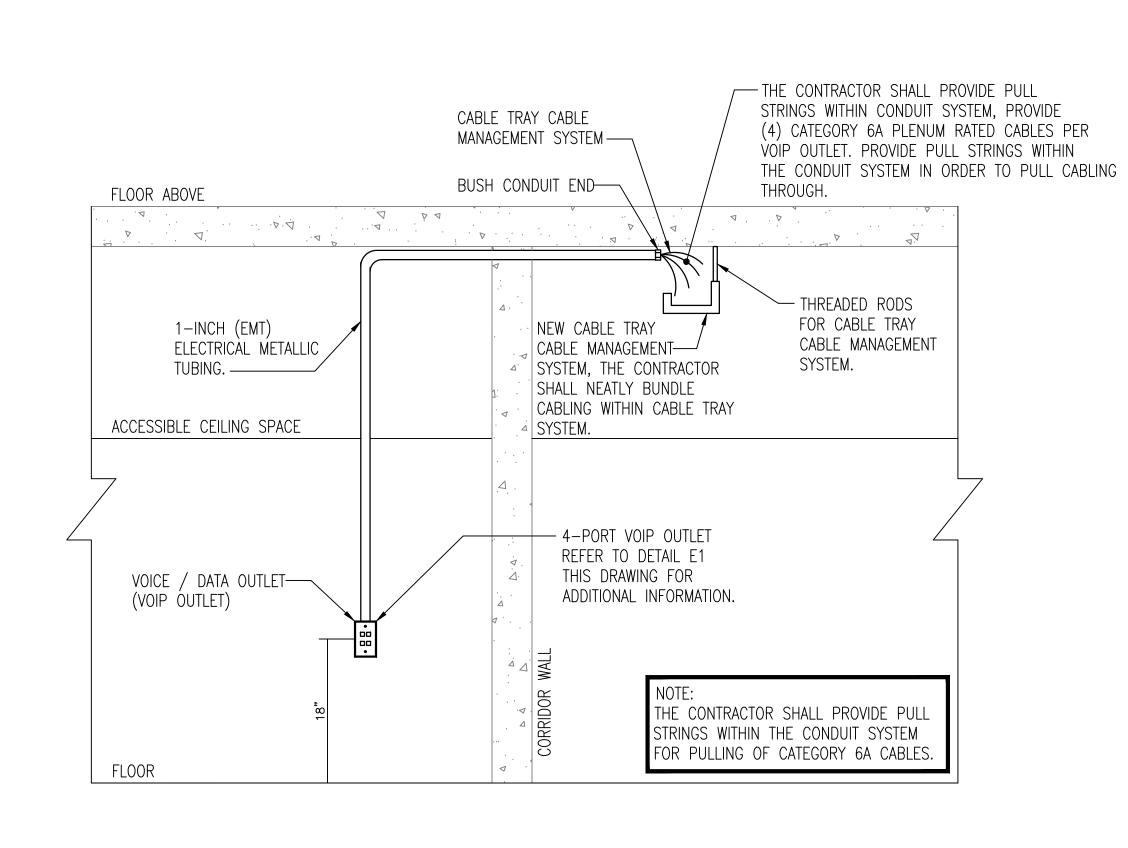


CONDUIT AND CABLE TRAY DETAIL

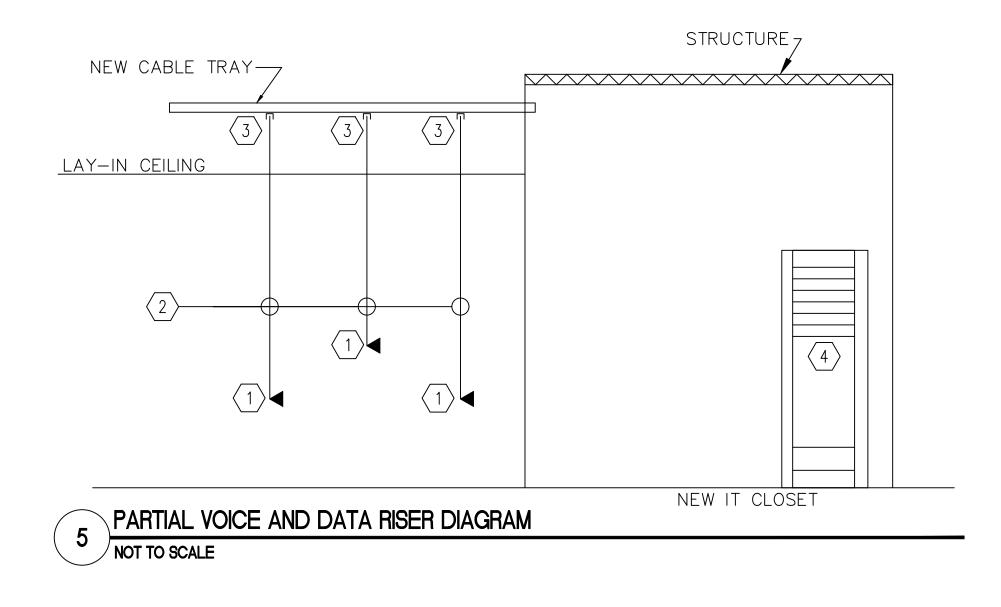


PARTIAL VOICE AND DATA RISER DIAGRAM NOTES

- VOIP (VOICE AND DATA) OUTLET. SEE SPECIFICATIONS FOR FURTHER INFORMATION.
- 2. 1 1/4" EMT (ELECTRICAL METALLIC TUBING) CONDUIT PROVIDE (4) CATEGORY 6A PLENUM RATED CABLES FROM EACH VOIP OUTLET TO EXISTING SEVER EQUIPMENT, PROVIDE PULL STRINGS WITHIN CONDUIT SYSTEM.TO PULL 6A CABLING.
- 3. PROVIDE BUSH CONDUIT END, ROUTE 1 1/4-INCH EMT (ELECTRICAL METALLIC TUBING) CONDUIT FROM VOIP OUTLET OVER TO NEW CABLE TRAY SYSTEM.
- 4. HEAD END EQUIPMENT THE CONTRACTOR SHALL PROVIDE AS REQUIRED.

ADDENDUM 1	08-09-2024		ARCHITECT/ENGINEER OF RECORD	STAMD	0.651	Drawing Title	Phase	Project Title			Project Number 438-22-900	
	CONSULTANT		ARCHITECT/ENGINEER OF RECORD	STAWIF	Office of		100% CONSTRUCTION DOCUMENTS	SIOUX FALLS BOILER PLANT				
		-		WILL TE OF LOUIS	Construction	TELECOMMUNICATIONS DETAILS					Building Number	
		• naradiam		and Facilities						12		
			paradigm	TYLER M. MONTGOMERY LICENSE NO. 0047142	Management	Approved: Project Director		Location VAMC-Sioux Falls: 2501 W 22nd St, Sioux Falls, SD 5710			Drawing Number	
		-	Architecture Engineering Design-Build				FULLY SPRINKLERED	Issue Date	·)rawn	ET501	
		1	9000 Wessex Place, Louisville, KY 40222 www.paradigmusa.com	WIND SON ENGLISH	VA U.S. Department of Veterans		OLLI OI KIIVIKLEIKED		WLM	KMB		
Revisions:	Date:			9/12/2024	Affairs			06/25/2024		KIND		
	2	2	<i>1</i> 5		6	7	Q	Q			10	

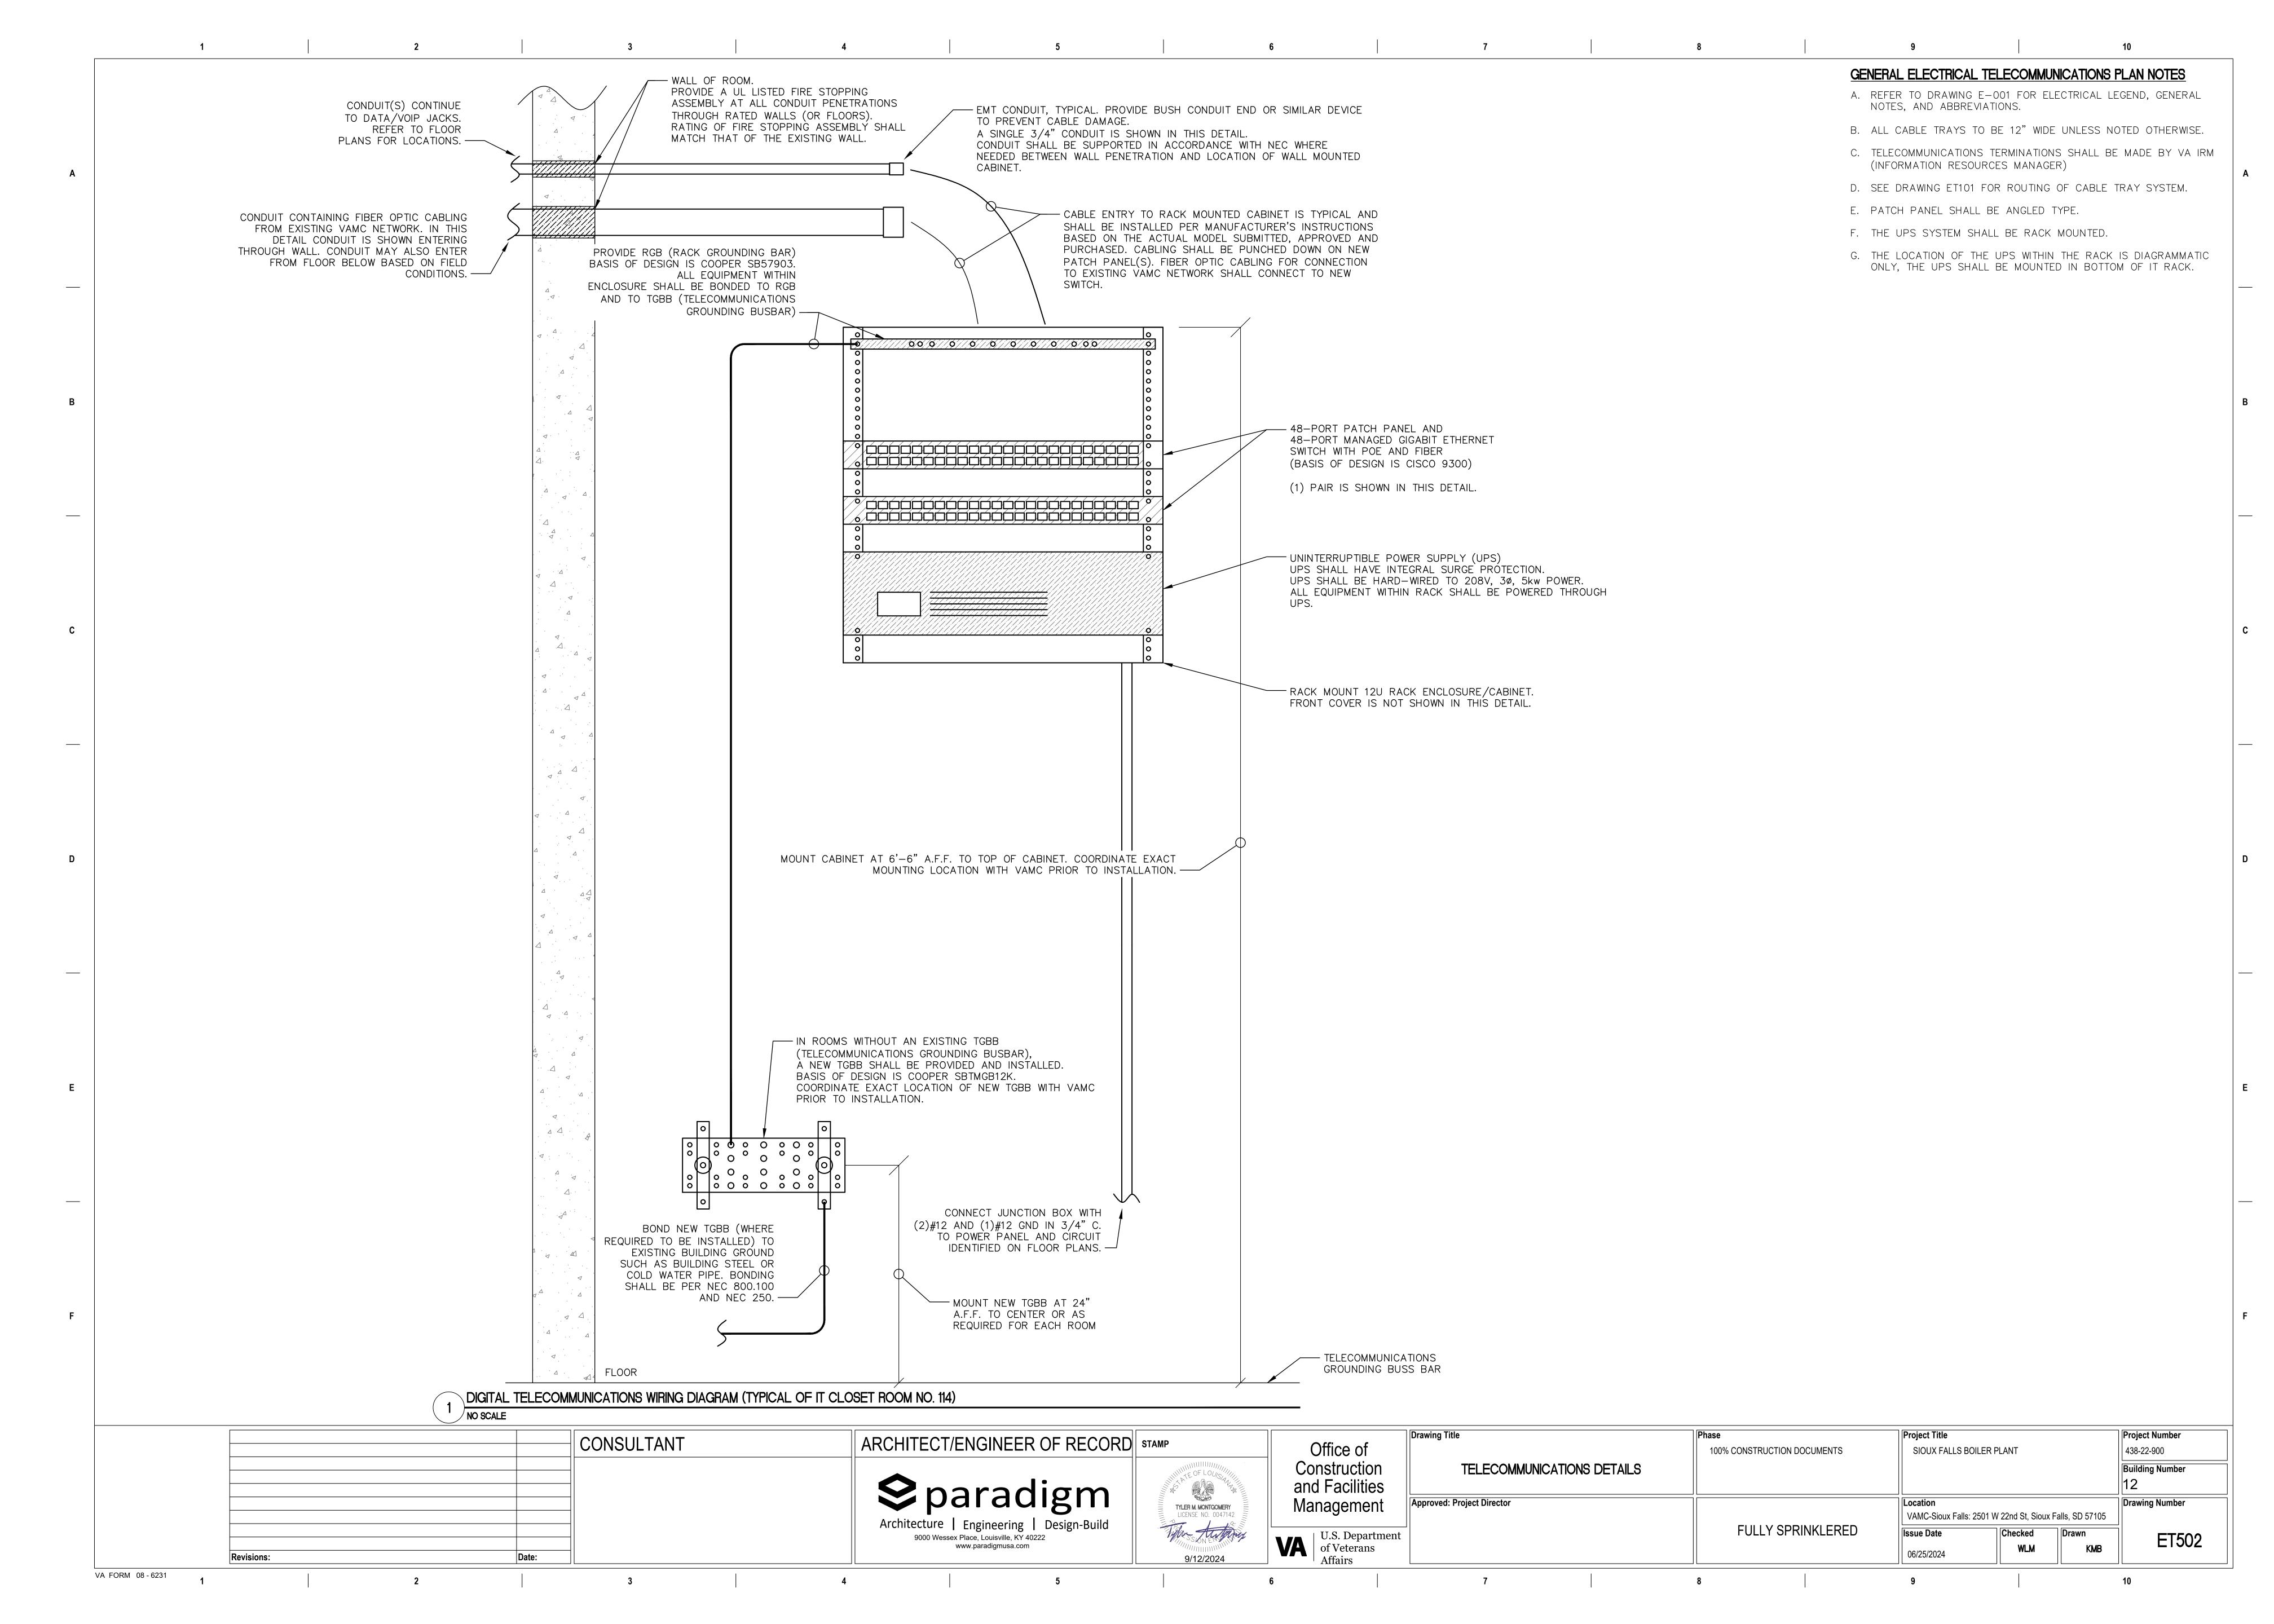

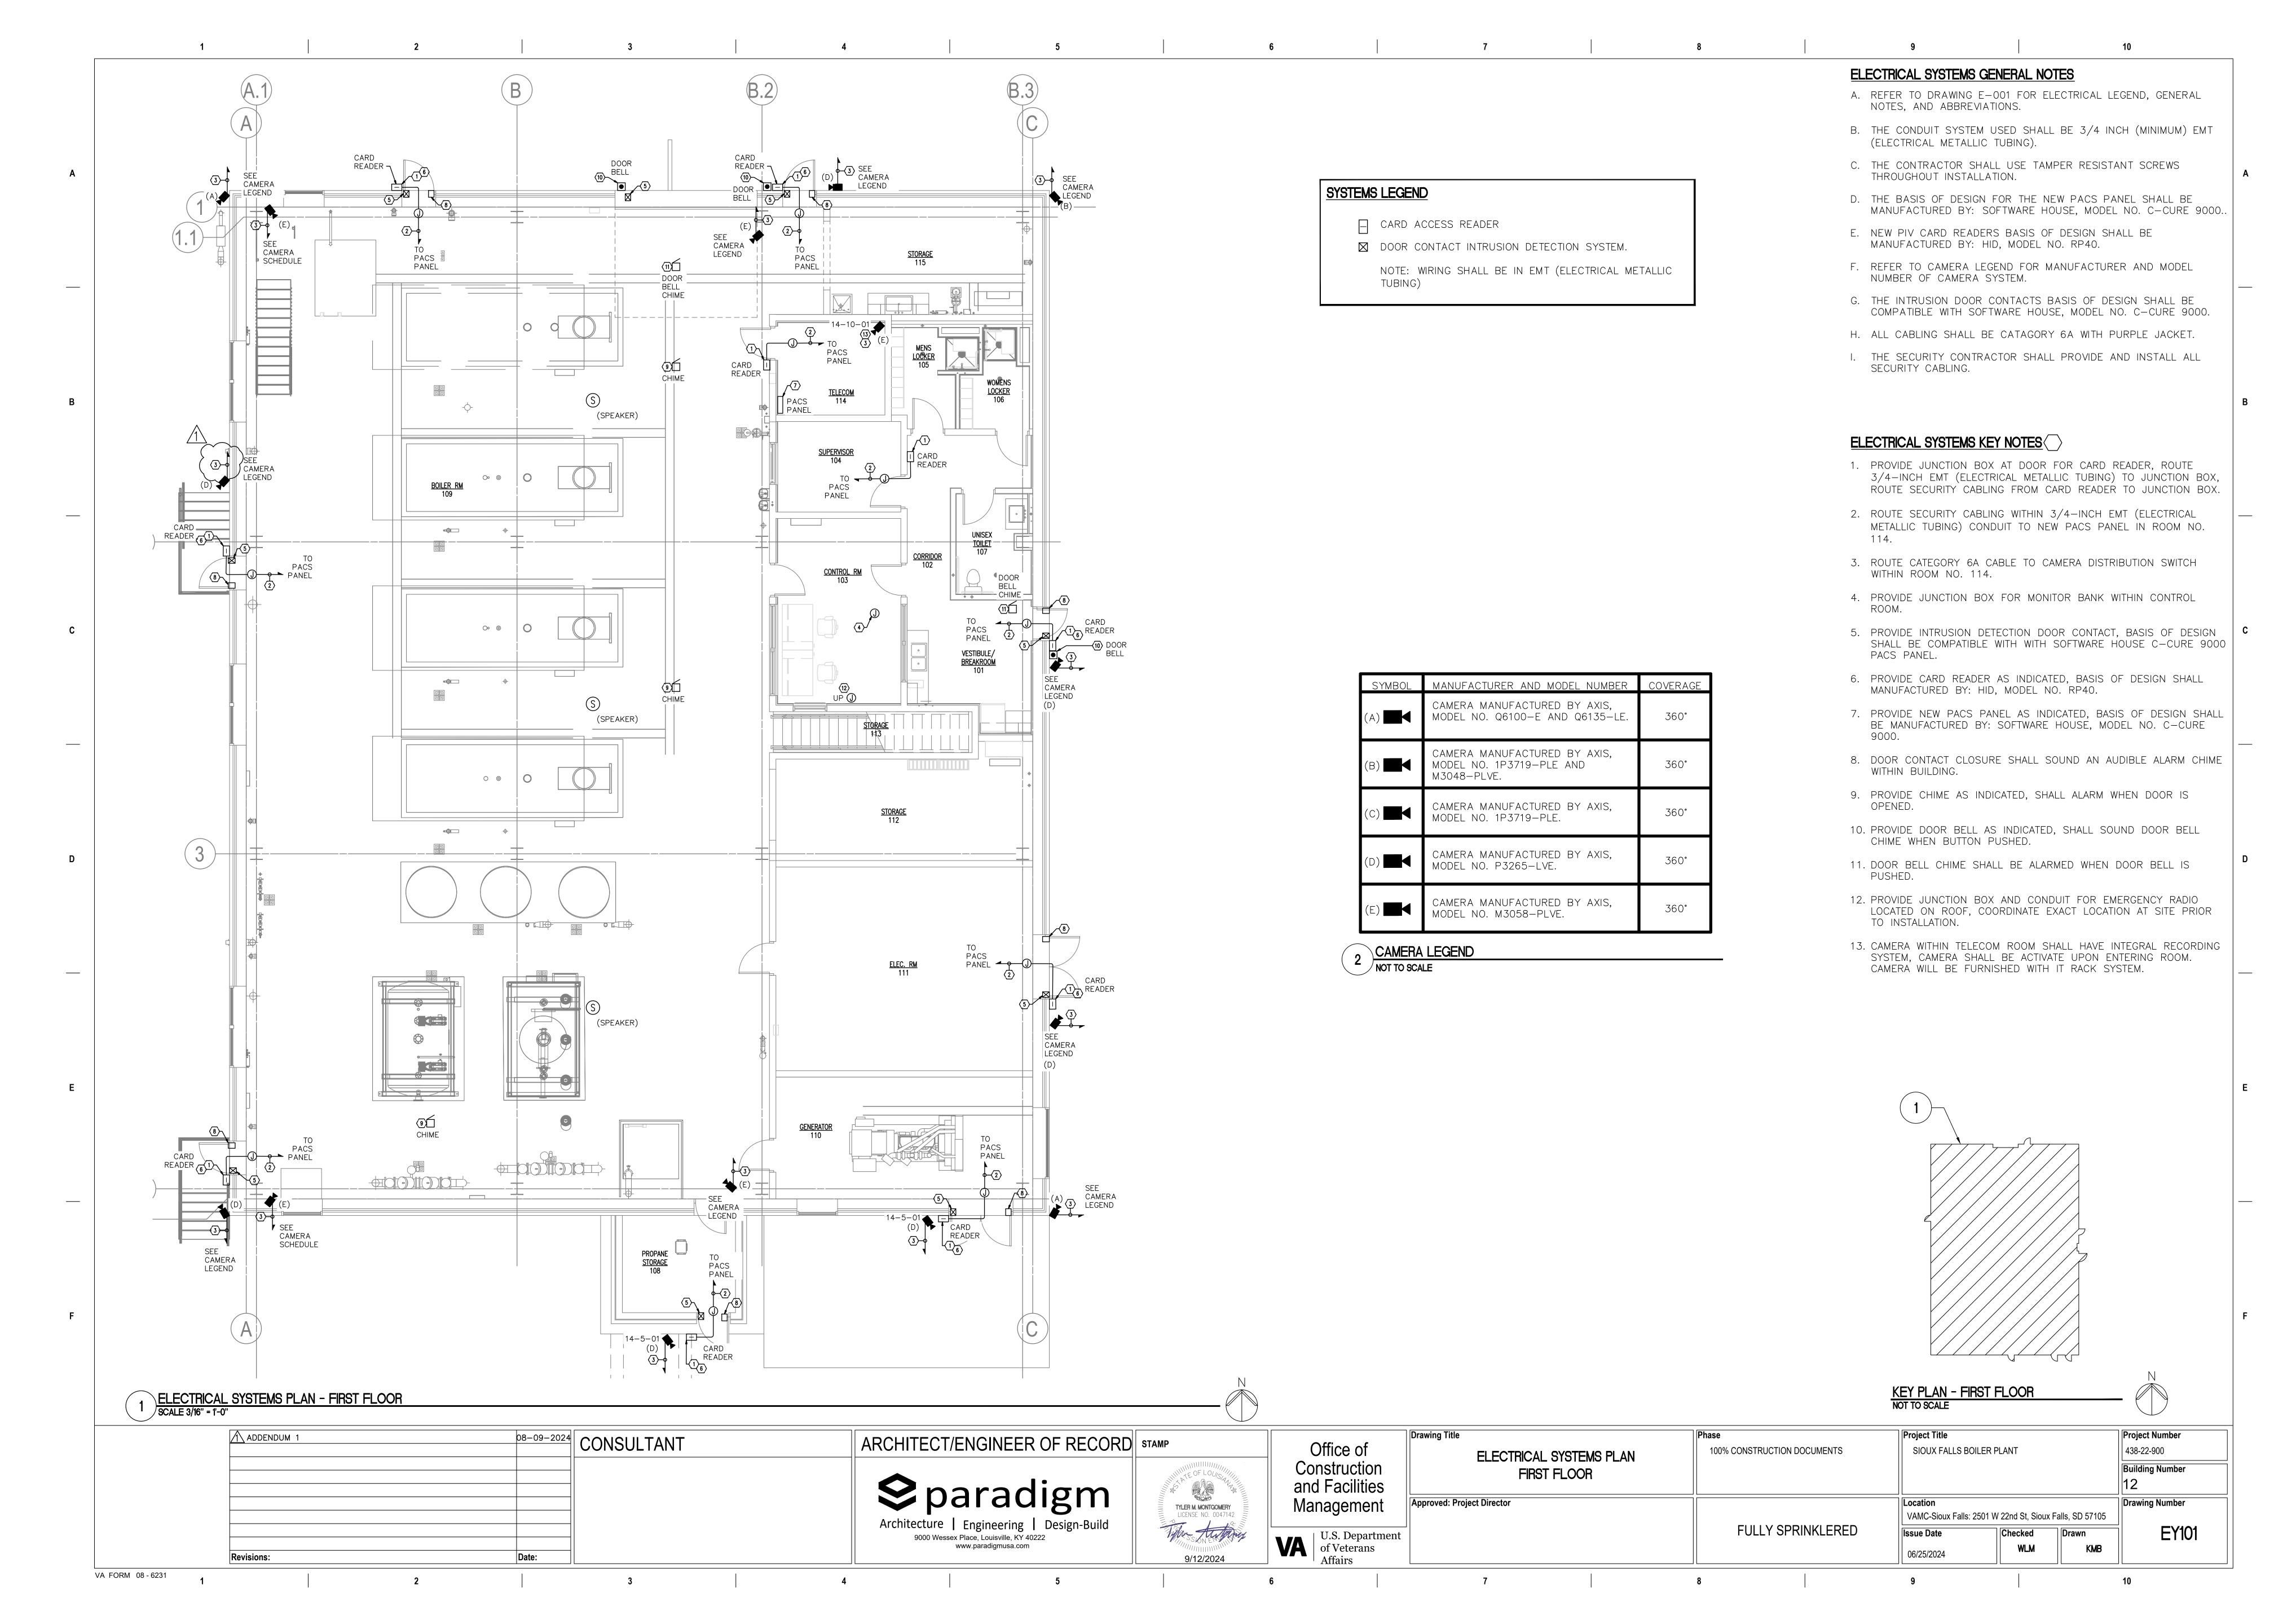


- 4-SQUARE 1" EMT CONDUIT -COORDINATE PENETRATION BOX WITH ARCHITECT PRIOR TO ROUGH-IN CAMERA MOUNTING -ACCESSORY INTENT IS FOR CAMERA MOUNT TO COVER <u>PLAN VIEW</u> WALL PENETRATION - CAMERA MOUNTING ACCESSORY └ 270 DEGREE FIELD OF VIEW PANORAMIC CAMERA - REFER TO ARCHITECTURAL DRAWINGS FOR WALL FINISH

CORNER CAMERA MOUNT AND ROUGH-IN DETAIL NOT TO SCALE

NOTES:


- 1. COORDINATE EXACT LOCATION ON SITE WITH WORK BY OTHER TRADES TO ENSURE DESIRED VIEWING AREA AND SERVICE ACCESS AFTER COMPLETION OF PROJECT TO MINIMIZE ANY POSSIBLE DAMAGE TO INSTALLED CAMERA OR ASSOCIATED CABLING.
- 2. INSTALLING CONTRACTOR SHALL FURNISH AND INSTALL FIRESTOP MATERIALS FOR CAMERA ROUGH—INS PER PROJECT REQUIREMENTS. REFER TO SPECIFICATIONS FOR FIRESTOP REQUIREMENTS.
- 3. PROVIDE CAMERA MOUNTING ACCESSORIES AS REQUIRED FOR A COMPLETE INSTALLATION OF THE SAME MANUFACTURER OF THE CAMERA AND APPROVED BY THE MANUFACTURER FOR USE WITH THE SPECIFIC MODEL NUMBER OF CAMERA INSTALLED.
- 4. SEAL WALL MOUNT BASE PLATE TO FACADE TO PREVENT WATER INFILTRATION.

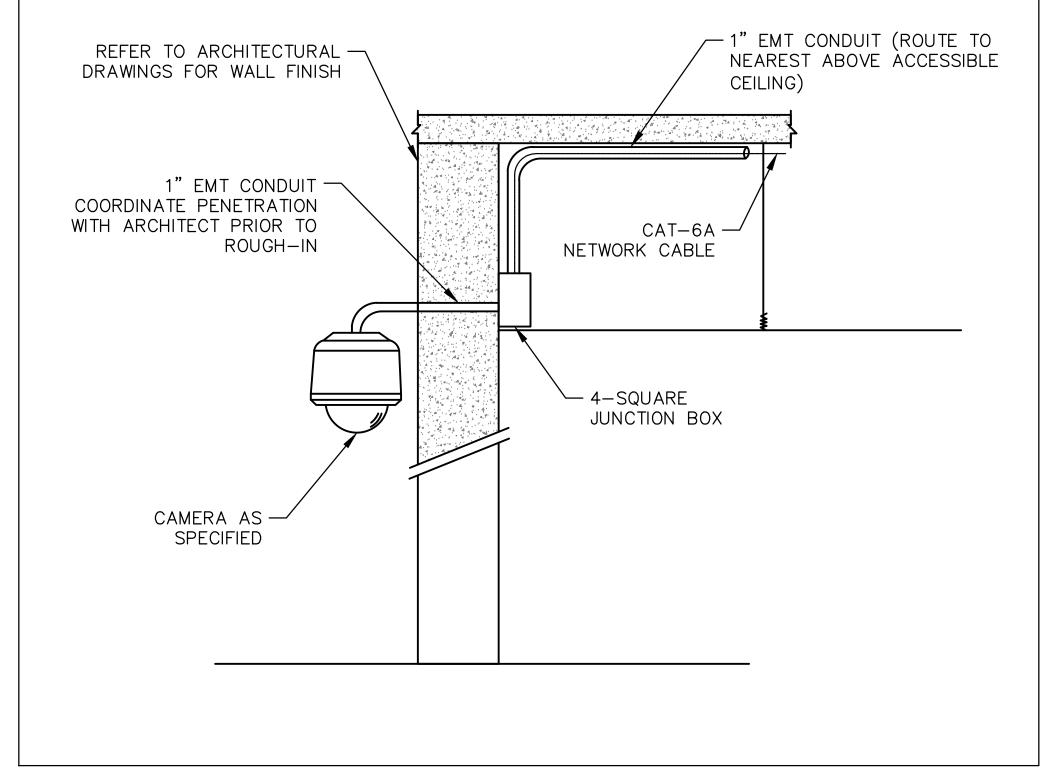

2 WALL PENDANT CAMERA MOUNT AND ROUGH-IN DETAIL NOT TO SCALE

NOTES:


- COORDINATE EXACT LOCATION ON SITE WITH WORK BY OTHER TRADES TO ENSURE DESIRED VIEWING AREA AND SERVICE ACCESS AFTER COMPLETION OF PROJECT TO MINIMIZE ANY POSSIBLE DAMAGE TO INSTALLED CAMERA OR ASSOCIATED CABLING.
- 2. INSTALLING CONTRACTOR SHALL FURNISH AND INSTALL FIRESTOP MATERIALS FOR CAMERA ROUGH—INS PER PROJECT REQUIREMENTS. REFER TO SPECIFICATIONS FOR FIRESTOP REQUIREMENTS.
- 3. PROVIDE CAMERA MOUNTING ACCESSORIES AS REQUIRED FOR A COMPLETE INSTALLATION OF THE SAME MANUFACTURER OF THE CAMERA AND APPROVED BY THE MANUFACTURER FOR USE WITH THE SPECIFIC MODEL NUMBER OF CAMERA
- 4. SEAL WALL MOUNT BASE PLATE TO FACADE TO PREVENT WATER INFILTRATION.

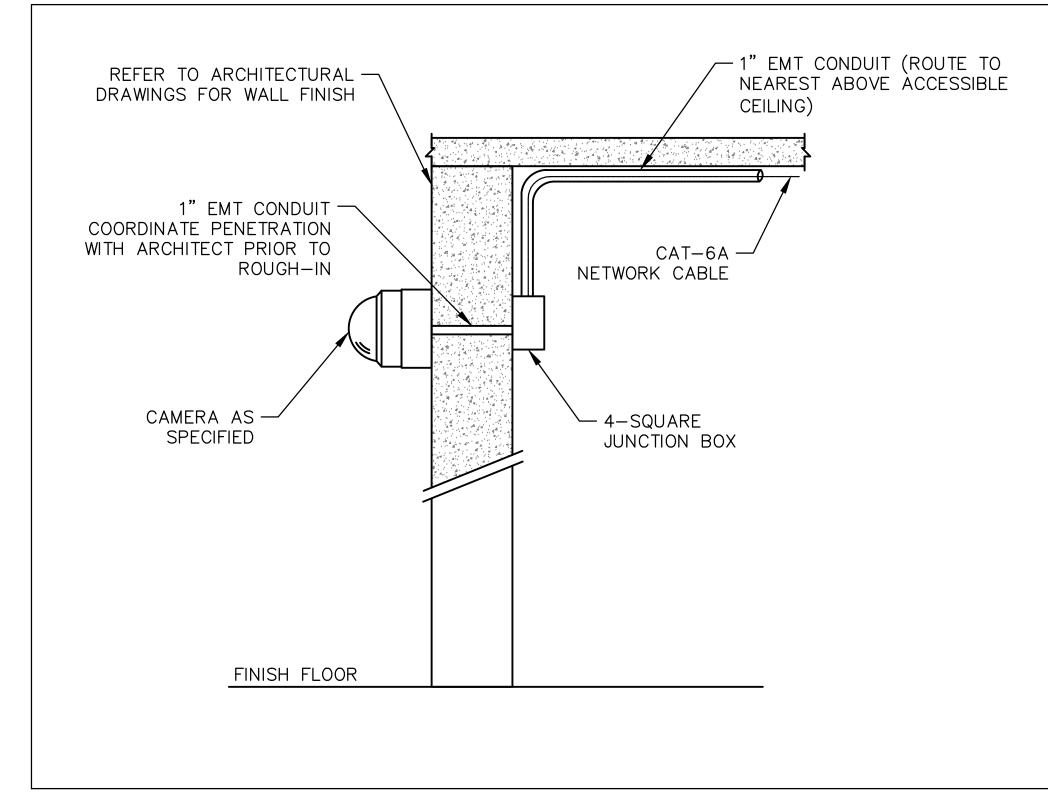

VERTICAL SURFACE MOUNT CAMERA AND ROUGH-IN DETAIL NOT TO SCALE

NOTES:


- COORDINATE EXACT LOCATION ON SITE WITH WORK BY OTHER TRADES TO ENSURE DESIRED VIEWING AREA AND SERVICE ACCESS AFTER COMPLETION OF PROJECT TO MINIMIZE ANY POSSIBLE DAMAGE TO INSTALLED CAMERA OR ASSOCIATED CABLING.
- 2. INSTALLING CONTRACTOR SHALL FURNISH AND INSTALL FIRESTOP MATERIALS FOR CAMERA ROUGH—INS PER PROJECT REQUIREMENTS. REFER TO SPECIFICATIONS FOR FIRESTOP REQUIREMENTS.
- 3. PROVIDE CAMERA MOUNTING ACCESSORIES AS REQUIRED FOR A COMPLETE INSTALLATION OF THE SAME MANUFACTURER OF THE CAMERA AND APPROVED BY THE MANUFACTURER FOR USE WITH THE SPECIFIC MODEL NUMBER OF CAMERA
- 4. SEAL WALL MOUNT BASE PLATE TO FACADE TO PREVENT WATER INFILTRATION.

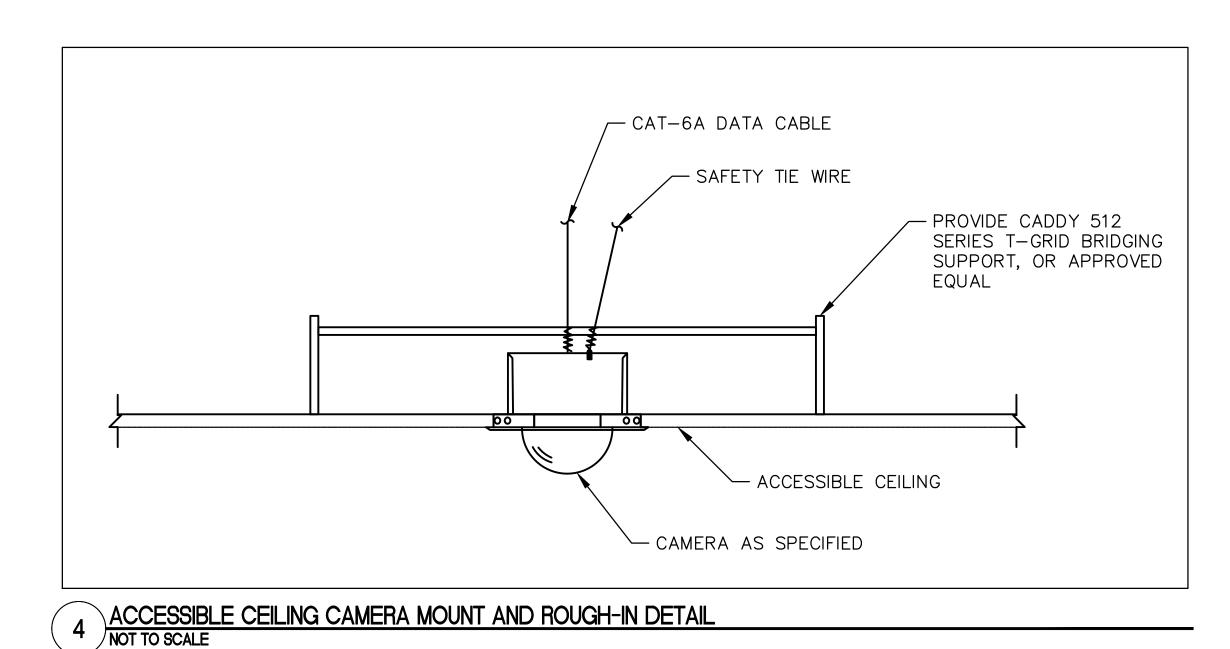

NOTES:

VA FORM 08 - 6231

- 1. COORDINATE EXACT LOCATION ON SITE WITH WORK BY OTHER TRADES TO ENSURE DESIRED VIEWING AREA AND SERVICE ACCESS AFTER COMPLETION OF PROJECT TO MINIMIZE ANY POSSIBLE DAMAGE TO INSTALLED CAMERA OR ASSOCIATED CABLING.
- INSTALLING CONTRACTOR SHALL FURNISH AND INSTALL FIRESTOP MATERIALS FOR CAMERA ROUGH—INS PER PROJECT REQUIREMENTS. REFER TO SPECIFICATIONS FOR FIRESTOP REQUIREMENTS.

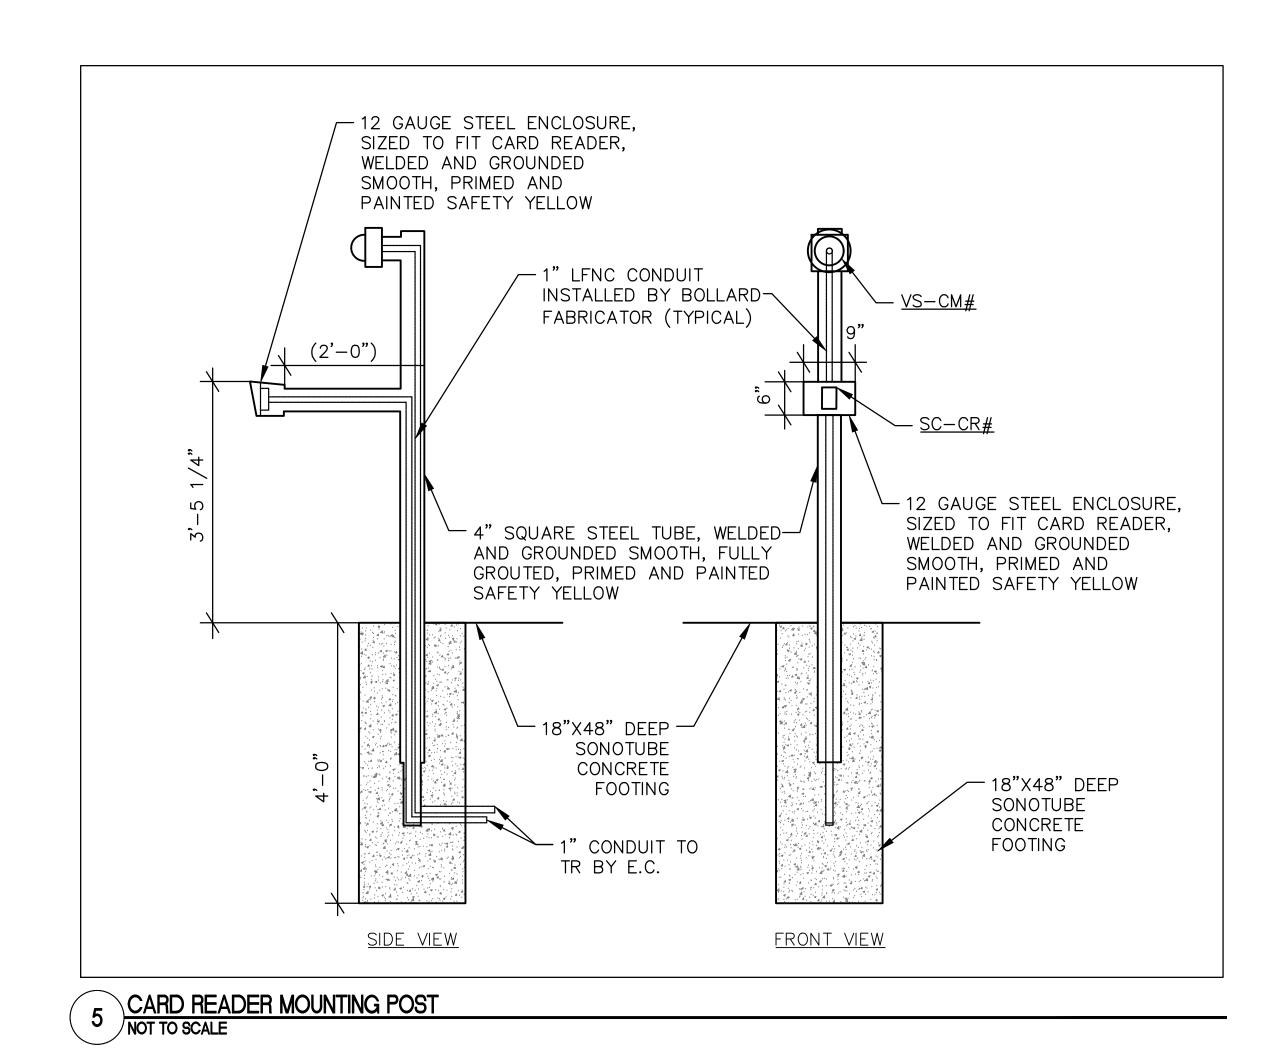

Project Title Project Number Drawing Title CONSULTANT ARCHITECT/ENGINEER OF RECORD | STAMP Office of 438-22-900 100% CONSTRUCTION DOCUMENTS SIOUX FALLS BOILER PLANT Construction SYSTEMS DETAILS **Building Number** and Facilities **Approved: Project Director** Drawing Number Management TYLER M. MONTGOMERY
LICENSE NO. 0047142 VAMC-Sioux Falls: 2501 W 22nd St, Sioux Falls, SD 57105 Architecture | Engineering | Design-Build **FULLY SPRINKLERED** EY501 Issue Date Checked of Veterans
Affairs | U.S. Department 9000 Wessex Place, Louisville, KY 40222 www.paradigmusa.com WLM KMB 06/25/2024 Revisions:

FIRE ALARM LEGEND (NOT ALL SYMBOLS WILL APPLY TO THIS WORK) FIRE ALARM PULL STATION: MOUNTED 48" AFF TO CENTERLINE OF STATION. COMBINATION SPEAKER WITH ADJUSTABLE CANDELA STROBE LIGHT. WALL MOUNTED 90" AFF TO TOP. CEILING MOUNT WHERE INDICATED. NUMBER INDICATES CANDELA RATING OF STROBE. 'WP' INDICATES WEATHERPROOF UNIT. ADJUSTABLE CANDELA STROBE LIGHT. WALL MOUNTED 90" AFF TO TOP. CEILING MOUNT WHERE INDICATED. NUMBER INDICATES CANDELA RATING OF STROBE. REFER TO SPECIAL REQUIREMENTS IN SLEEPING AREAS. 'NS' INDICATES NON-SUPERVISED 120 VOLT REMOTE VISUAL SIGNAL 177 CANDELA, CONNECTED TO NON-SUPERVISED SMOKE DETECTOR. SFS SPRINKLER FLOW SWITCH

'S' INDICATES LOCATED IN SUPPLY PLENUM

'R' INDICATES LOCATED IN RETURN PLENUM

T TEST STATION FOR DUCT SMOKE DETECTOR

STS SPRINKLER TAMPER SWITCH

DUCT SMOKE DETECTOR:

MONITOR MODULE

SMOKE DETECTOR

BFP BACK FLOW PREVENTOR

DH DOOR HOLDER

ABBREVIATIONS ALTERNATING CURRENT AMERICANS WITH DISABILITIES ACT ABOVE FINISHED FLOOR ABOVE FINISHED GRADE AWG AMERICAN WIRE GAUGE PB BLDG BUILDING PANEL CONDUIT CANDELA RATING CLG CEILING CHANNEL CKT CIRCUIT CENTERLINE CONCRETE MASONRY UNIT SF CONC CONCRETE CONT'D CONTINUED CONTRACTING OFFICER'S REPRESENTATIVE TYP CABINET UNIT HEATER DIRECT CURRENT DISH WASHER ELECTRICAL CONTRACTOR EXHAUST FAN VA EQUIPMENT GROUNDING CONDUCTOR END OF LINE EUH ELECTRIC UNIT HEATER EWC ELECTRIC WATER COOLER WATT FIRE ALARM CONTROL PANEL WITH GARBAGE DISPOSAL WIRING GROUNDING ELECTRODE CONDUCTOR GROUND FAULT INTERRUPTER GND GROUND HORSEPOWER

(NOT ALL ABBREVIATIONS WILL APPLY TO THIS WORK) NORMALLY CLOSED OR NURSE CALL NATIONAL ELECTRICAL CODE NATIONAL FIRE PROTECTION ASSOCIATION NORMALLY OPEN NUMBER PUBLIC ADDRESS PUSH BUTTON POLYVINYL CHLORIDE REFRIGERATOR RIGID STEEL CONDUIT ROOF TOP UNIT SUPPLY FAN SOLID STATE SWBD1 SWITCHBOARD, NUMBER AS INDICATED TYPICAL **TELEVISION** UNDERGROUND UNDERWRITERS LABORATORIES UNINTERRUPTIBLE POWER SUPPLY DEPARTMENT OF VETERAN AFFAIRS VOLT-AMPERE VA MEDICAL CENTER VOICE OVER INTERNET PROTOCOL WEATHERPROOF TRANSFORMER EXPLOSION-PROOF HERTZ LOCATION OF RELOCATED DEVICE OR **EQUIPMENT** JUNCTION BOX REMOVE AND RELOCATE EXISTING DEVICE OR EQUIPMENT THOUSAND CIRCULAR MIL REMOVE EXISTING DEVICE OR EQUIPMENT THOUSAND VOLTS (KILOVOLT) EXISTING DEVICE OR EQUIPMENT TO REMAIN THOUSAND VOLT-AMPS EXISTING DEVICE OR EQUIPMENT TO BE THOUSAND WATTS (KILOWATT) REMOVED AND REPLACED AT SAME LOCATION LIGHT EMITTING DIODE LIGHTING MCC MOTOR CONTROL CENTER MCCB MOLDED CASE CIRCUIT BREAKER

GENERAL NOTES

A. NOT ALL SYMBOLS INDICATED IN THE LEGEND, OR LISTED ABBREVIATIONS, APPEAR ON THE DRAWINGS. COORDINATE WORK ACCORDINGLY. COMPLY WITH

SPECIFICATIONS AND NOTES BELOW AS APPLICABLE. ALL PENETRATIONS THROUGH FLOORS, RATED WALLS AND PARTITIONS SHALL BE SEALED WITH UL APPROVED FIRE SEALANT MATERIAL TO MAINTAIN FIRE AND/OR

SMOKE RATING FOR THE SEPARATION. REFER TO SPECIFICATIONS. ALL CONDUITS, ENCLOSURES, CONDUIT BODIES AND THEIR COVERS CONTAINING FIRE ALARM SYSTEM CONDUCTORS SHALL BE PAINTED RED.

PROVIDE WIRE MARKERS TO IDENTIFY CABLES FOR ALL SYSTEMS AT THE ORIGIN, PULL BOXES, AND TERMINATION POINTS. LABELS SHALL BE SELF ADHESIVE OR HEAT SHRINK TYPE. REFER TO SPECIFICATIONS.

SOME WORK UNDER THIS CONTRACT WILL REQUIRE WORK DUTIES TO BE PERFORMED AFTER NORMAL WORKING HOURS. DETERMINATION OF SPECIFIC WORK DUTIES TO BE PERFORMED AFTER HOURS MUST BE MADE BY VA STAFF AT THEIR CONVENIENCE. POSSIBLE WORK REQUIRING AFTER HOURS APPROVAL INCLUDES: POWER OUTAGES AND DISRUPTION OF SERVICES. EXTREME NOISE AND/OR VIBRATION, CUTTING AND PATCHING OF CONCRETE, AND DELIVERIES OF EQUIPMENT.

CARE SHOULD BE TAKEN BY ALL CONTRACTORS TO AVOID DAMAGING OR DISTURBING EXISTING CONSTRUCTION AND FINISHES. CONTRACTORS SHALL BE RESPONSIBLE FOR MAKING ANY REPAIRS NECESSARY TO RECTIFY DAMAGE AND RESTORE EXISTING CONSTRUCTION AND FINISHES TO UNDAMAGED STATE UPON COMPLETION OF WORK AT NO EXPENSE TO THE VA. REPAIR OR REPLACE AND REFINISH, TO THE SATISFACTION OF THE VA, ANY CEILING, FLOOR, OR WALL SURFACES OR STRUCTURES THAT MAY BE DAMAGED IN THE PROCESS OF WORK.

REFER TO SHEET FA001 FOR LEGEND, ABBREVIATIONS, AND GENERAL NOTES.

PROVIDE NEW FIRE ALARM SYSTEM AS INDICATED, REFER TO FLOOR PLAN FOR LOCATIONS OF DEVICES, REFER TO FIRE ALARM MATRIX SUMMARY FOR ADDITIONAL INFORMATION.

PROVIDE SUFFICIENT COMMUNICATION LOOP CIRCUITS TO SERVE MAXIMUM NUMBER OF ADDRESSES RECOMMENDED BY FIRE ALARM SYSTEM MANUFACTURER PLAN AN ADDITIONAL 50%.

REFER TO FIRE ALARM PLANS FOR LOCATIONS.


NOT ALL SYMBOLS INDICATED IN THE LEGEND, OR LISTED ABBREVIATIONS, APPEAR ON THE DRAWINGS. COORDINATE WORK ACCORDINGLY. COMPLY WITH SPECIFICATIONS AND NOTES BELOW AS APPLICABLE.


DASHED SYMBOLS INDICATE ITEMS THAT ARE BEING COMPLETELY REMOVED.

M. ALL DEMOLITION WORK SHALL COMPLY WITH MEDICAL CENTER REQUIREMENTS AND PROCEDURES.

N. UNLESS NOTED, OR OTHERWISE SHOWN OR SPECIFIED, ALL MATERIALS AND EQUIPMENT REMOVED OR DEMOLISHED (EXCEPT THAT WHICH IS TO BE SALVAGED OR RELOCATED) AS DIRECTED BY DRAWINGS AND SPECIFICATIONS SHALL BECOME THE PROPERTY OF THE CONTRACTOR AND SHALL BE DISPOSED OF LEGALLY.


NEW FIRE ALARM DEVICES SHALL BE COMPATIBLE WITH EXISTING FIRE ALARM SYSTEM MANUFACTURED BY NOTIFIER.

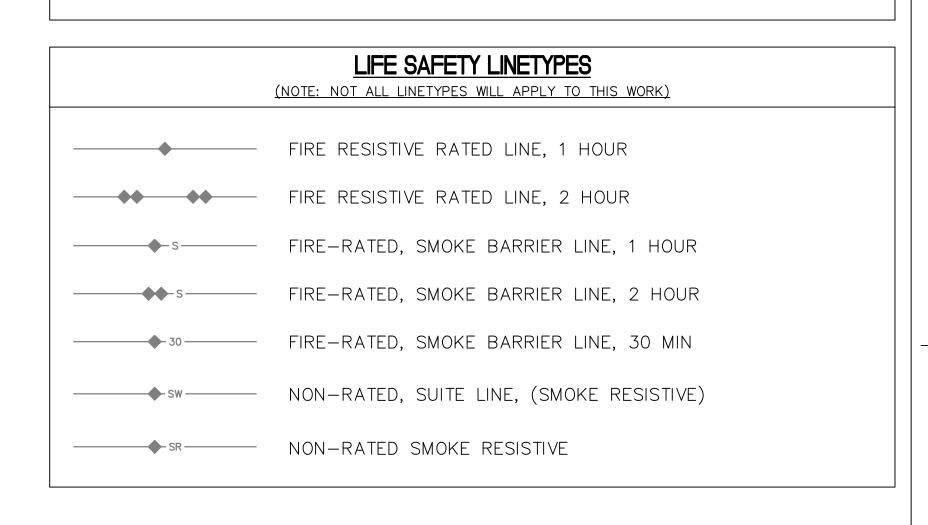


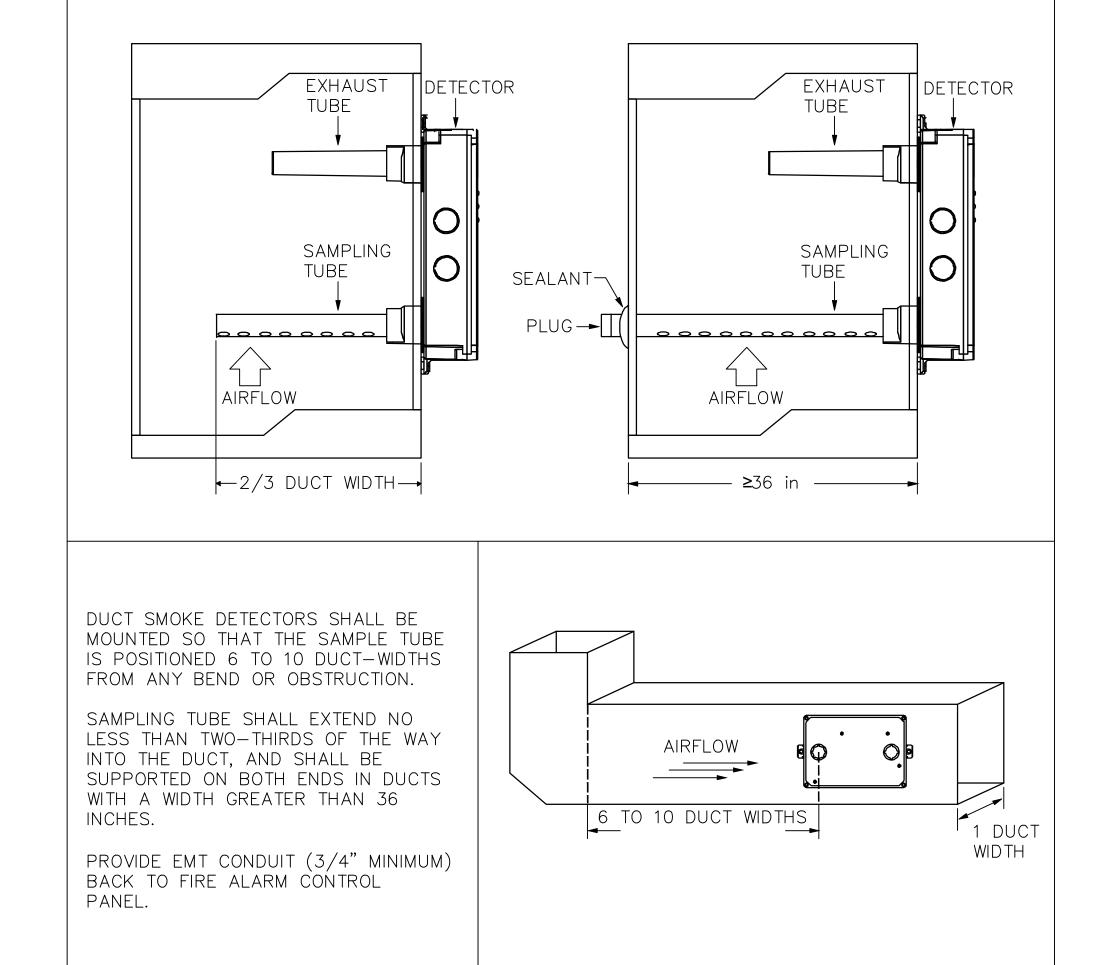

DUCT SMOKE DETECTOR INSTALLATION DETAIL

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MCB MAIN CIRCUIT BREAKER

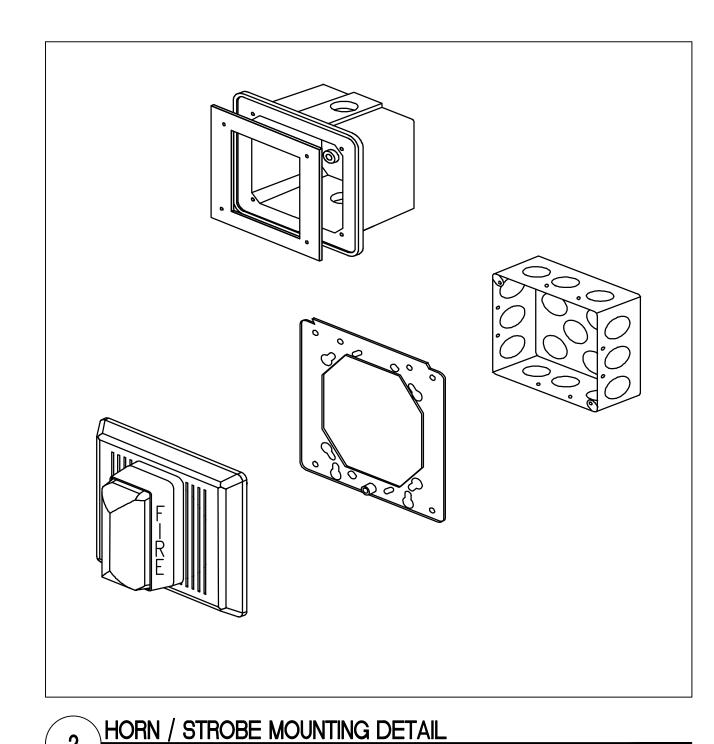
MANUAL PULL STATIONS

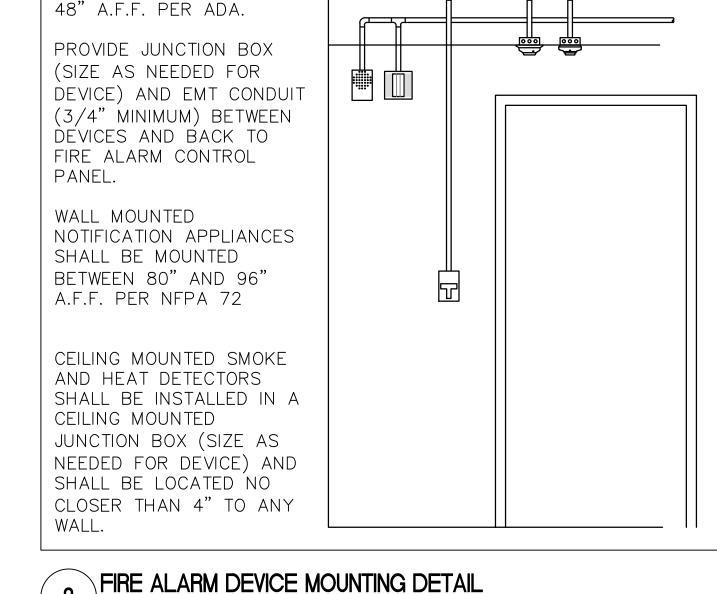
SHALL BE MOUNTED AT

MICROWAVE OR MICROPHONE

MANHOLE

Project Title Drawing Title **Project Number** CONSULTANT ARCHITECT/ENGINEER OF RECORD STAMP Office of 100% CONSTRUCTION DOCUMENTS SIOUX FALLS BOILER PLANT FIRE ALARM LEGEND, Construction **Building Number** GENERAL NOTES AND ABBREVIATIONS and Facilities **Approved: Project Director Drawing Number** Management TYLER M. MONTGOMERY
LICENSE NO. 0047142 VAMC-Sioux Falls: 2501 W 22nd St, Sioux Falls, SD 57105 Architecture | Engineering | Design-Build **FULLY SPRINKLERED** FA001 Checked | U.S. Department 9000 Wessex Place, Louisville, KY 40222 of Veterans www.paradigmusa.com WLM KMB 06/25/2024 Revisions:

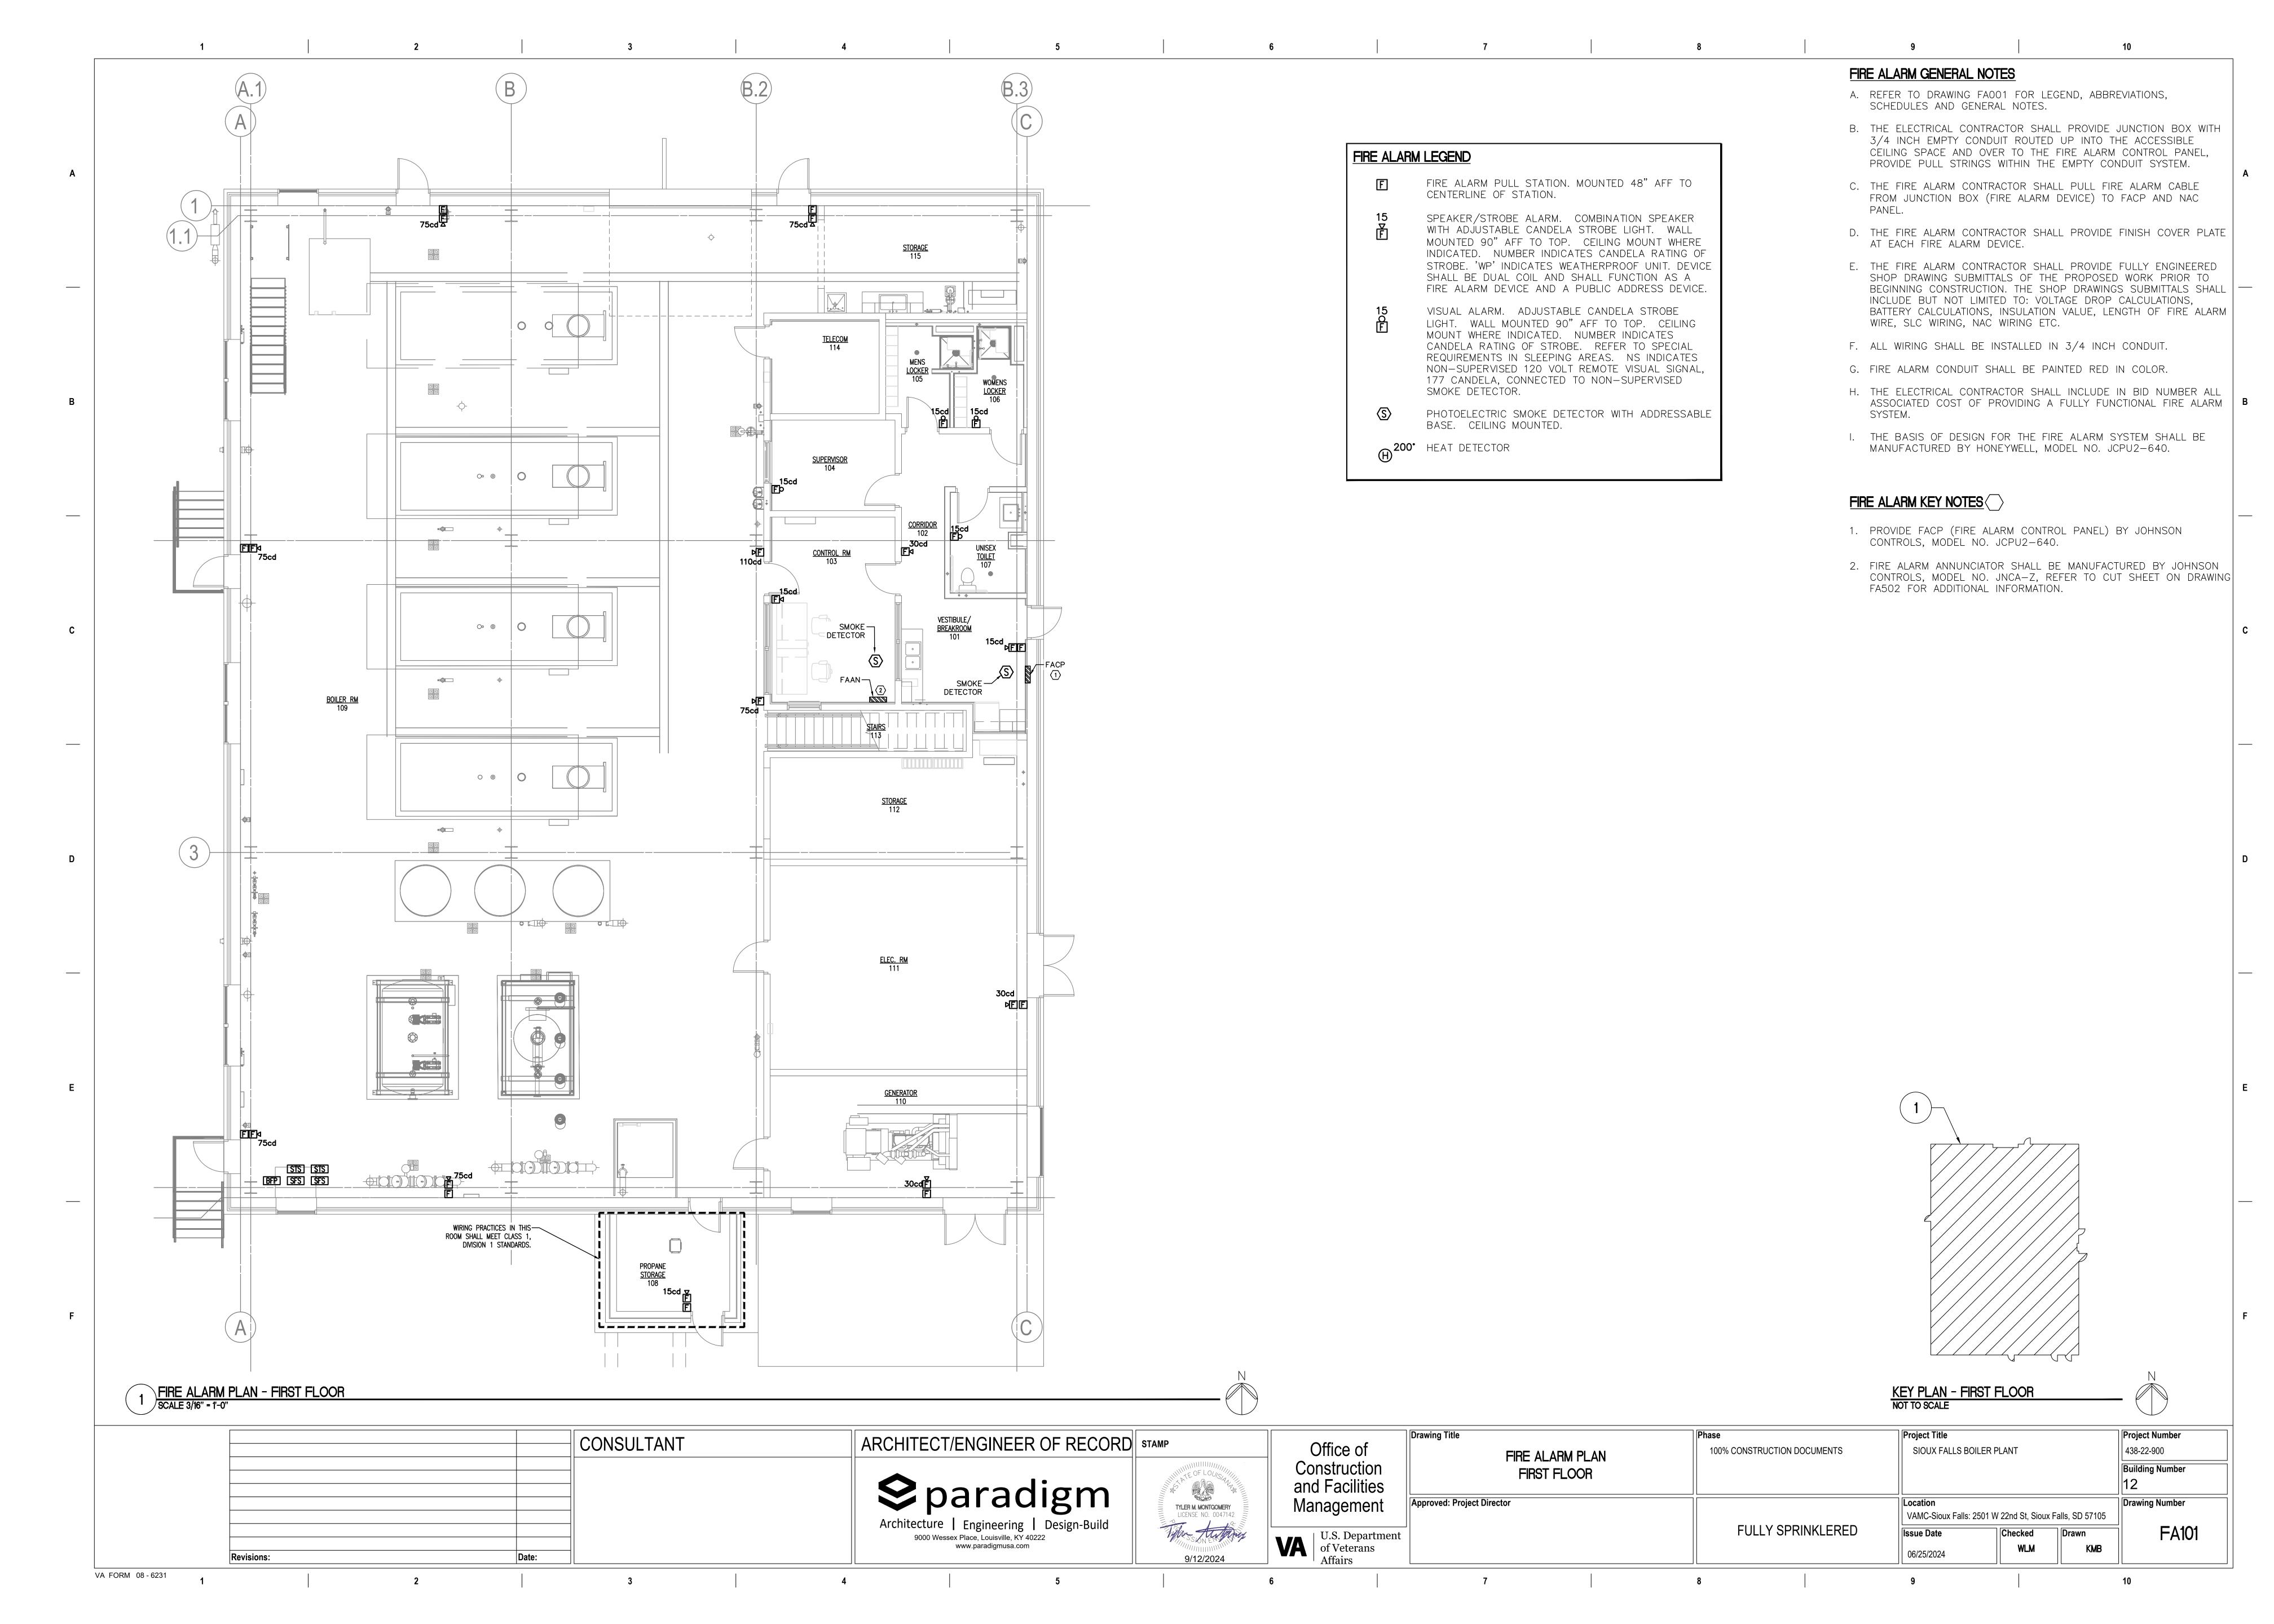

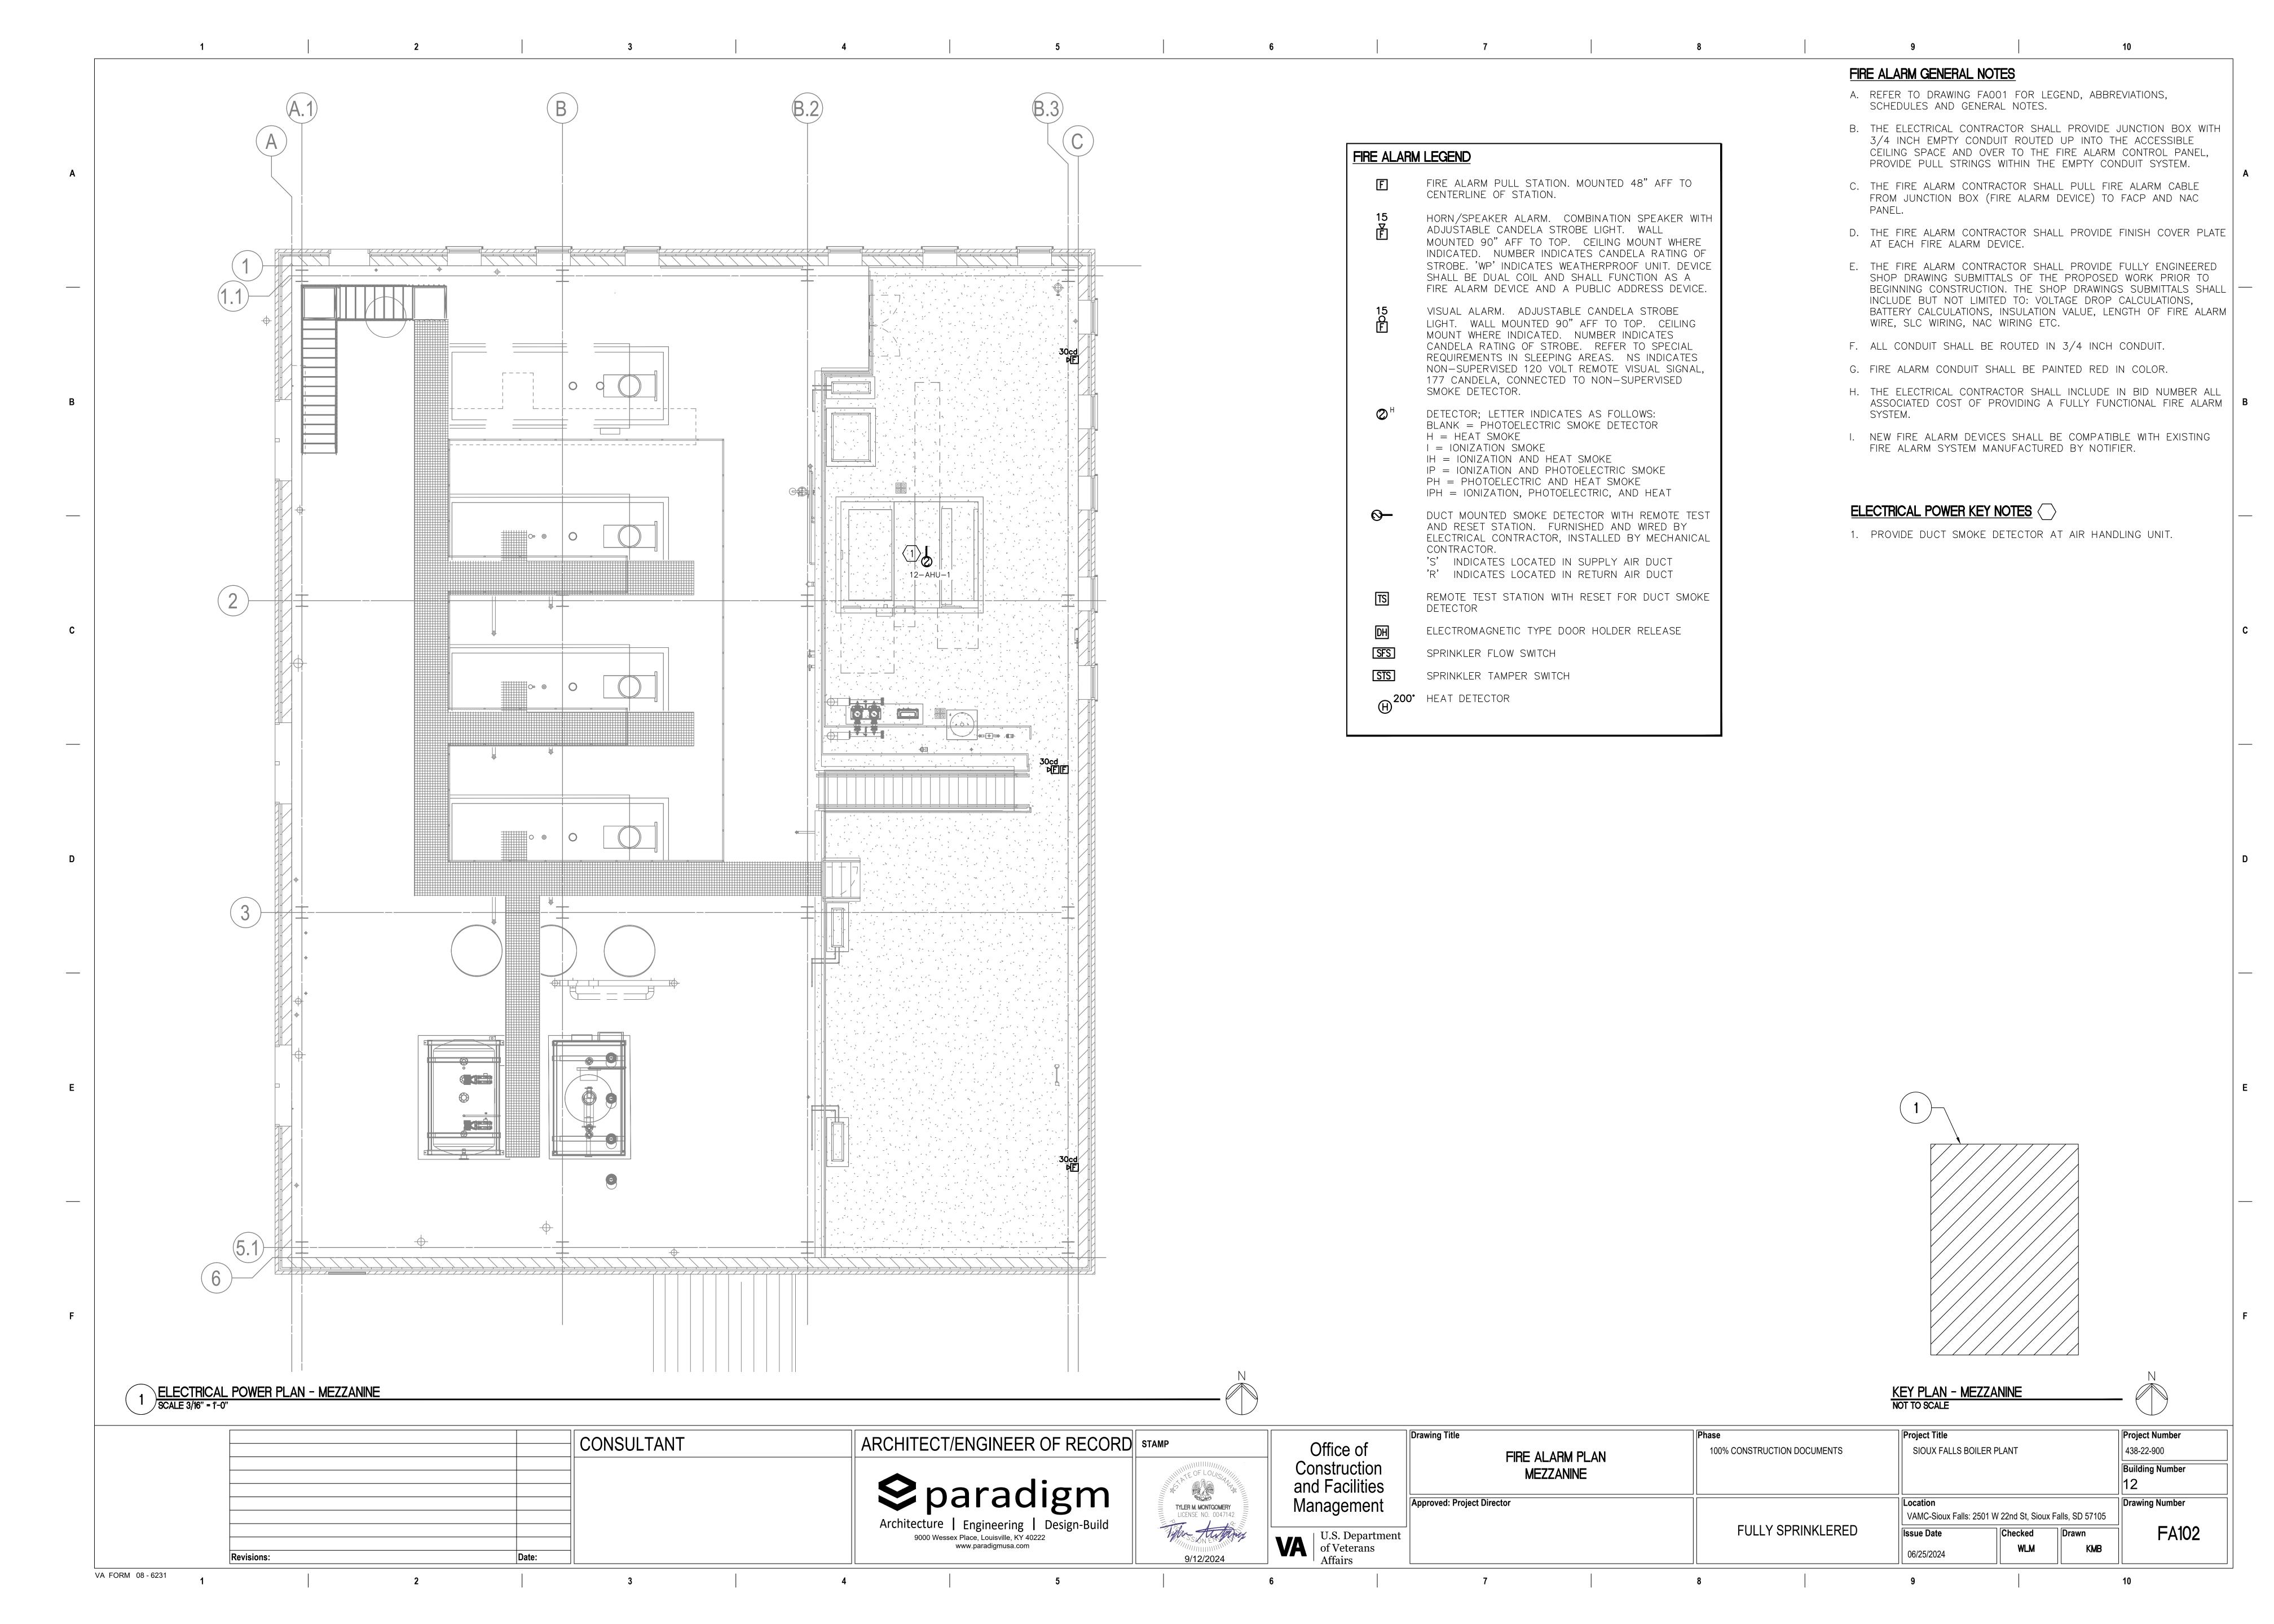

PARTIAL FIRE ALARM RISER DIAGRAM SCALE: NOT TO SCALE

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	IRAL N FOR SEE	FOR FOR ONLY MAY ON ONLY ONS.		SIGNAL JR T FOR SPONSE	JKE ON	ERS	AIR	ATOR	ATOR O R.	KED	ROM AENT.	ABLE
INPUT DEVICE	ENE ARN NOI NON E).	STAI USE E, HE D H UGS UT C	3. NOTIFY FIRE DEPARTMENT	4. INITIATE SUPERVISORY SIGNAL TO A 24—HOUR MANNED POINT FOR IMMEDIATE RESPONSE	5. CLOSE ASSOCIATED SMOKE BARRIER DOORS ON THE FLOOR.	SE DAMPERS N	7. SHUT DOWN AIR HANDLER	RECALL ELEVATOR	9. INITIATE ELEVATOR SHUT DOWN AND DISCONNECT ELEVATOR POWER.	OPEN***LOCKED RESS DOORS ON OOR OF FIRE GIN.	11. DISCONNECT FUEL SOURCE FROM COOKING EQUIPMENT.	T APPLICABLE
	1. SOUNE BUILDING OTHER AN HIGH RISI HEALTH (2. NOTIFY NECESSARY FOR RESPON HEALTH CARI AMBULATORY CARE**, AN RISE BUILDIN RISE BUILDIN (ALARM SIGN BE DIFFEREN DIFFERENT F	3. NO DEPAR	4. INIT SUPER TO A MANNE IMMEDI	5. CLC ASSOC BARRIE THE FI	6. CLOSE ON FAN	7. SHU HANDLI	8. REC	9. INIT SHUT I DISCONELEVAT	10. OPE EGRESS FLOOR (ORIGIN.	11. DIS FUEL S COOKIN	12. NOT
DUCT SMOKE DETECTOR				Xp		X	Xa					
AREA SMOKE DETECTOR	X	X	X							X		
DOOR RELEASE SMOKE DETECTOR												X
ELEVATOR SMOKE DETECTOR												X
MANUAL PULL STATION	X	X	X							X		
ELEVATOR MACHINE ROOM HEAT DETECTOR												X
GENERATOR ROOM HEAT DETECTOR	X	X	X									
SPRINKLER WATER FLOW / PRESSURE SWITCH	X	X	X		X					X		
WATER CONTROL VALVE TAMPER				X								
FIRE PUMP (ANY CONDITION REQUIRED BY NFPA)												X
HIGH / LOW PRESSURE DRY-PIPE SPRINKLER SYSTEM				X								
KITCHEN HOOD SUPPRESSION SYSTEM												X
GAS EXTINGUISHING SYSTEMS												X
DRY PIPE VALVE ROOM TEMPERATURE ALARM												X
DEDICATED FIRE WATER STORAGE TANK LOW LEVEL												X
DEDICATED FIRE WATER STORAGE TANK LOW TEMPERATURE												X

A-DO NOT PROVIDE DUCT DETECTORS IN DEDICATED (100%) EXHAUST FANS, THEY SHOULD CONTINUE TO RUN. B-THE FACILITY IS PERMITTED TO SOUND THE GENERAL ALARM OR NOTIFY NECESSARY STAFF IN LIEU OF INITIATING A SUPERVISORY SIGNAL TO BE CONSISTENT WITH THE OPERATION OF EXISTING SYSTEMS.

NOTE: FACP FOR BUILDING NO. 12 MUST ANNUNCIATE TO MONITORING COMPANY AUTO-DIALER IS LOCATED IN BUILDING NO. 5 ROOM NO. E23.

2 INPUT/OUTPUT MATRIX DETAIL SCALE: NOT TO SCALE

ARCHITECT/ENGINEER OF RECORD | STAMP CONSULTANT Architecture | Engineering | Design-Build 9000 Wessex Place, Louisville, KY 40222 www.paradigmusa.com Revisions:

TYLER M. MONTGOMERY
LICENSE NO. 0047142

Office of Construction and Facilities Management U.S. Department of Veterans Affairs

Approved: Project Director

C. ALL NEW CONDUITS INSTALLED INSIDE SHALL BE EMT (ELECTRICAL METALLIC TUBING).


D. THE FIRE ALARM CONTRACTOR SHALL PROVIDE CUTTING AND PATCHING ON ALL WALL OR CEILING OPENINGS.

E. THE ROUTING PATH OF FIRE ALARM CIRCUITS AND GROUPING OF FIRE ALARM DEVICES ON EACH FIRE ALARM CIRCUIT ARE DIAGRAMMATIC ONLY, THE CONTRACTOR SHALL ROUTE AND GROUP FIRE ALARM DEVICES IN THE MOST EFFICIENT MANNER, THE CONTRACTOR SHALL SUBMIT FIRE ALARM SHOP DRAWING OF THE FIRE ALARM SYSTEM PRIOR TO BEGINNING CONSTRUCTION.

F. THE FIRE ALARM INSTALLATION SHALL BE THE RESPONSIBILITY OF THE CONTRACTOR, INCLUDING BUT NOT LIMITED TO: NEW FIRE ALARM DEVICES, JUNCTION BOX, CONDUIT, FIRE ALARM CABLING ETC. THE PROGRAMMING OF THE FIRE ALARM SYSTEM SHALL BE BY: NORTHEAST INTEGRATED SYSTEMS.

FIRE ALARM RISER KEYED NOTES:

- 1. NEW FACP (FIRE ALARM CONTROL PANEL), LOCATED IN BREAK ROOM NO. 101, THE CONTRACTOR SHALL ROUTE NEW FIRE ALARM CABLING FROM FIRE ALARM DEVICE TO NEW FACP AND NAC PANEL AS INDICATED, THE CONTRACTOR SHALL INCLUDE IN BID NUMBER ALL ASSOCIATED COST OF PROGRAMMING NEW FIRE ALARM DEVICES ONTO THE EXISTING SYSTEM.
- 2. THE CONTRACTOR SHALL PROVIDE FIRE ALARM CIRCUITING PER MANUFACTURER RECOMMENDATIONS (TYPICAL).
- 3. THE CONTRACTOR SHALL ROUTE NEW COPPER FIRE ALARM CONDUCTORS UNDERGROUND FROM EXISTING BOILER PLANT FACP TO NEW FACP LOCATED IN NEW BOILER PLANT.
- 4. THE FIRE ALARM CONTRACTOR SHALL CONNECT COPPER FIRE ALARM CABLING TO EXISTING FACP LOCATED IN EXISTING BOILER PLANT.
- 5. PROVIDE FIRE ALARM ANNUNCIATOR AS INDICATED.

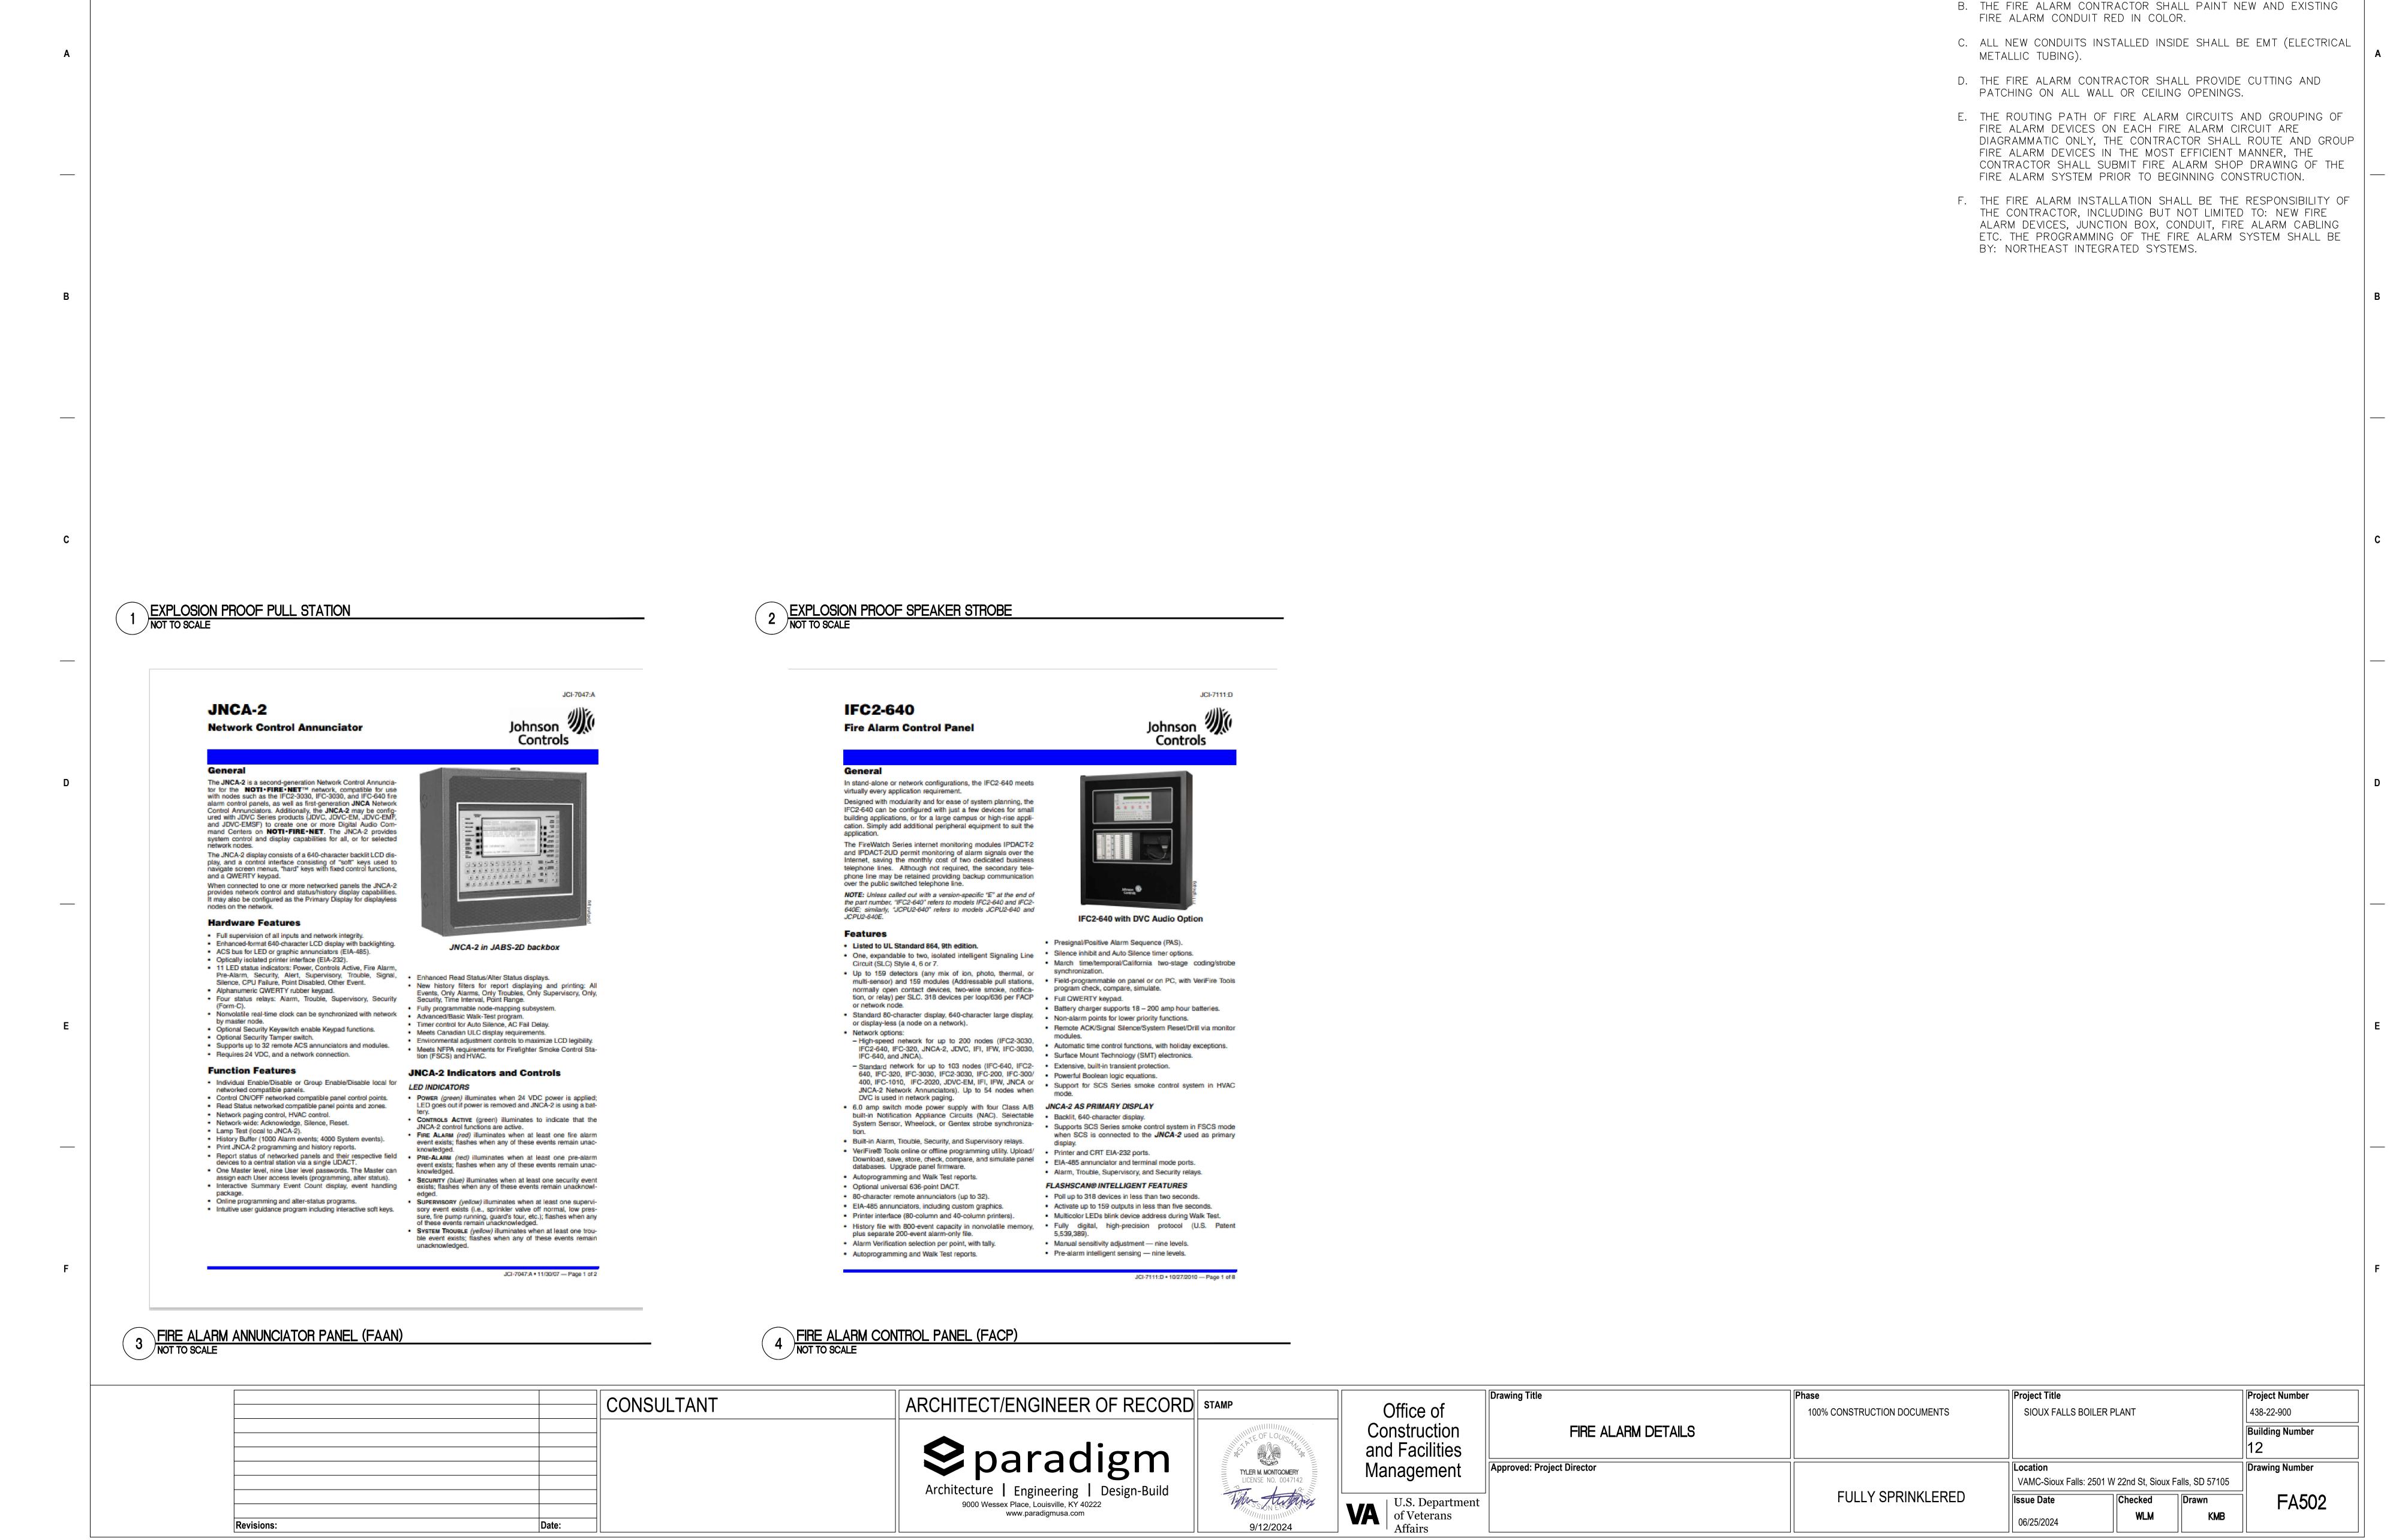

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FIRE ALARM RISER DIAGRAM GENERAL NOTES:

AND ABBREVIATIONS.

A. REFER TO SHEET E-001 FOR ELECTRICAL LEGEND, GENERAL NOTES,