

- 1. REFER TO SHEETS E-001 AND E-002 FOR ABBREVIATIONS, SYMBOLS AND NOTES. 2. REFER TO SHEET 50-E-131 FOR LOCATION OF PANEL 50-EQB-3 AND PARTIAL
- SINGLE LINE DIAGRAM (ATTIC).
- 3. REFER TO SERIES E-700 SHEETS FOR PANELBOARD SCHEDULES AND LIGHTING FIXTURE SCHEDULE.

FROM DUST, DEBRIS AND PHYSICAL DAMAGE AT ALL TIMES.


- 4. REFER TO ARCHITECTURAL DRAWINGS FOR ICRA BARRIER LOCATIONS AND ALL WORK ASSOCIATED WITH CEILINGS.
- 5. ADHERE TO ALL ICRA REQUIREMENTS LISTED ON GIOO1 AND IN SPECIFICATIONS. THE DIFFERENT WORK SPACES ICRA LEVEL HAS BEEN DEFINED BY THE VA AS LEVEL 3 UNLESS OTHERWISE INDICATED. ALL EQUIPMENT IN THE ROOM SHALL BE PROTECTED
- 6. AVOID CEILING-MOUNTED AND WALL-MOUNTED DEVICES (I.E. SIGNAGE, LIGHTING FIXTURE, FIRE ALARM, NURSE CALL, WAPS, ETC.) WHEN LOCATING ICRA WALLS. WHERE DEVICES CANNOT BE AVOIDED, THE CONTRACTOR SHALL TEMPORARILY RELOCATE THE DEVICE AND REINSTALL AT ORIGINAL LOCATION AFTER REMOVAL OF ICRA WALL.
- 7. REFER TO SPECIFICATION 02 82 11 APPENDIX A1 FOR ABATEMENT REPORT. THE CONTRACTOR SHALL ADHERE TO AND FOLLOW THE ABATEMENT REPORT FOR ALL KNOWN ABATEMENT LOCATIONS.
- 8. REFER TO MECHANICAL AND PIPING DRAWINGS FOR LOCATIONS OF MECHANICAL EQUIPMENT AND ROUTING OF PIPING/DUCT WORK.
- 9. CONDENSING UNITS AND PACKAGED AHU'S: UNITS ARE PROVIDED WITH A FACTORY WIRED 120V RECEPTACLE SHOWN IN GRAY-SCALE (FOR REFERENCE ONLY).

#### 

1. PROVIDE 30A/3P/25AF FUSED DISCONNECT SWITCH IN NEMA 3R ENCLOSURE. CONNECT TO ADJACENT CU AND INDICATED CIRCUIT WITH (3)#10 + (1)#10G IN 3/4"C. PROVIDE GALVANIZED STEEL FRAME WITH GALVANIZED HARDWARE FOR MOUNTING OF DISCONNECT SWITCH ON WALL.

Sloud Upgra	PRINTS OF THIS DRAWING SHALL NOT BE USED FOR ANY PURPOSE WHATSOEVER WITHOUT THE SEAL AND SIGNATURE OF THE PROFESSIONAL ENGINEER.	PROJECT TEAM		ENGINEER OF RECORD	MILLER-REMICK LLC PROFESSIONAL ENGINEER	Office of	Drawing Title ELECTRICAL	Phase 100% CONSTRUCTION	Project Title UPGRADE SPS HVAC &	Project Number 656-18-300
011 St (		MEP Engineers + Architects 1173 Research Way	701 Forest Ave	Miller-Remick LLC  M.E.P. & Structural Engineering A Service Disabled Veteran Owned		Construction and Facilities	BASEMENT - POWER PLAN	DOCUMENTS NOT FOR CONSTRUCTION	ENVIRONMENTAL CONTROLS	Building Number 50
\0376_CCCxA\0	NO. DESCRIPTION DATE	Forest, VA 24551 1-866-267-6839	Portland, ME 04103 (207) 828-4511 wbrcinc.com	Small Business  1010 KINGS HIGHWAY SOUTH CHERRY HILL, NEW JERSEY 08034 PHONE: (856)429-4000 FAX: (856)429-5002  MR PROJECT NO: 0376-0011		Management U.S. Department of Veterans Affairs	Approved: Project Director	FULLY SPRINKLERED	ST. CLOUD VA MEDICAL CENTER, MN  Issue Date  2022-07-15  Checked  Drawn  DR	Drawing Number 50-E-101

5

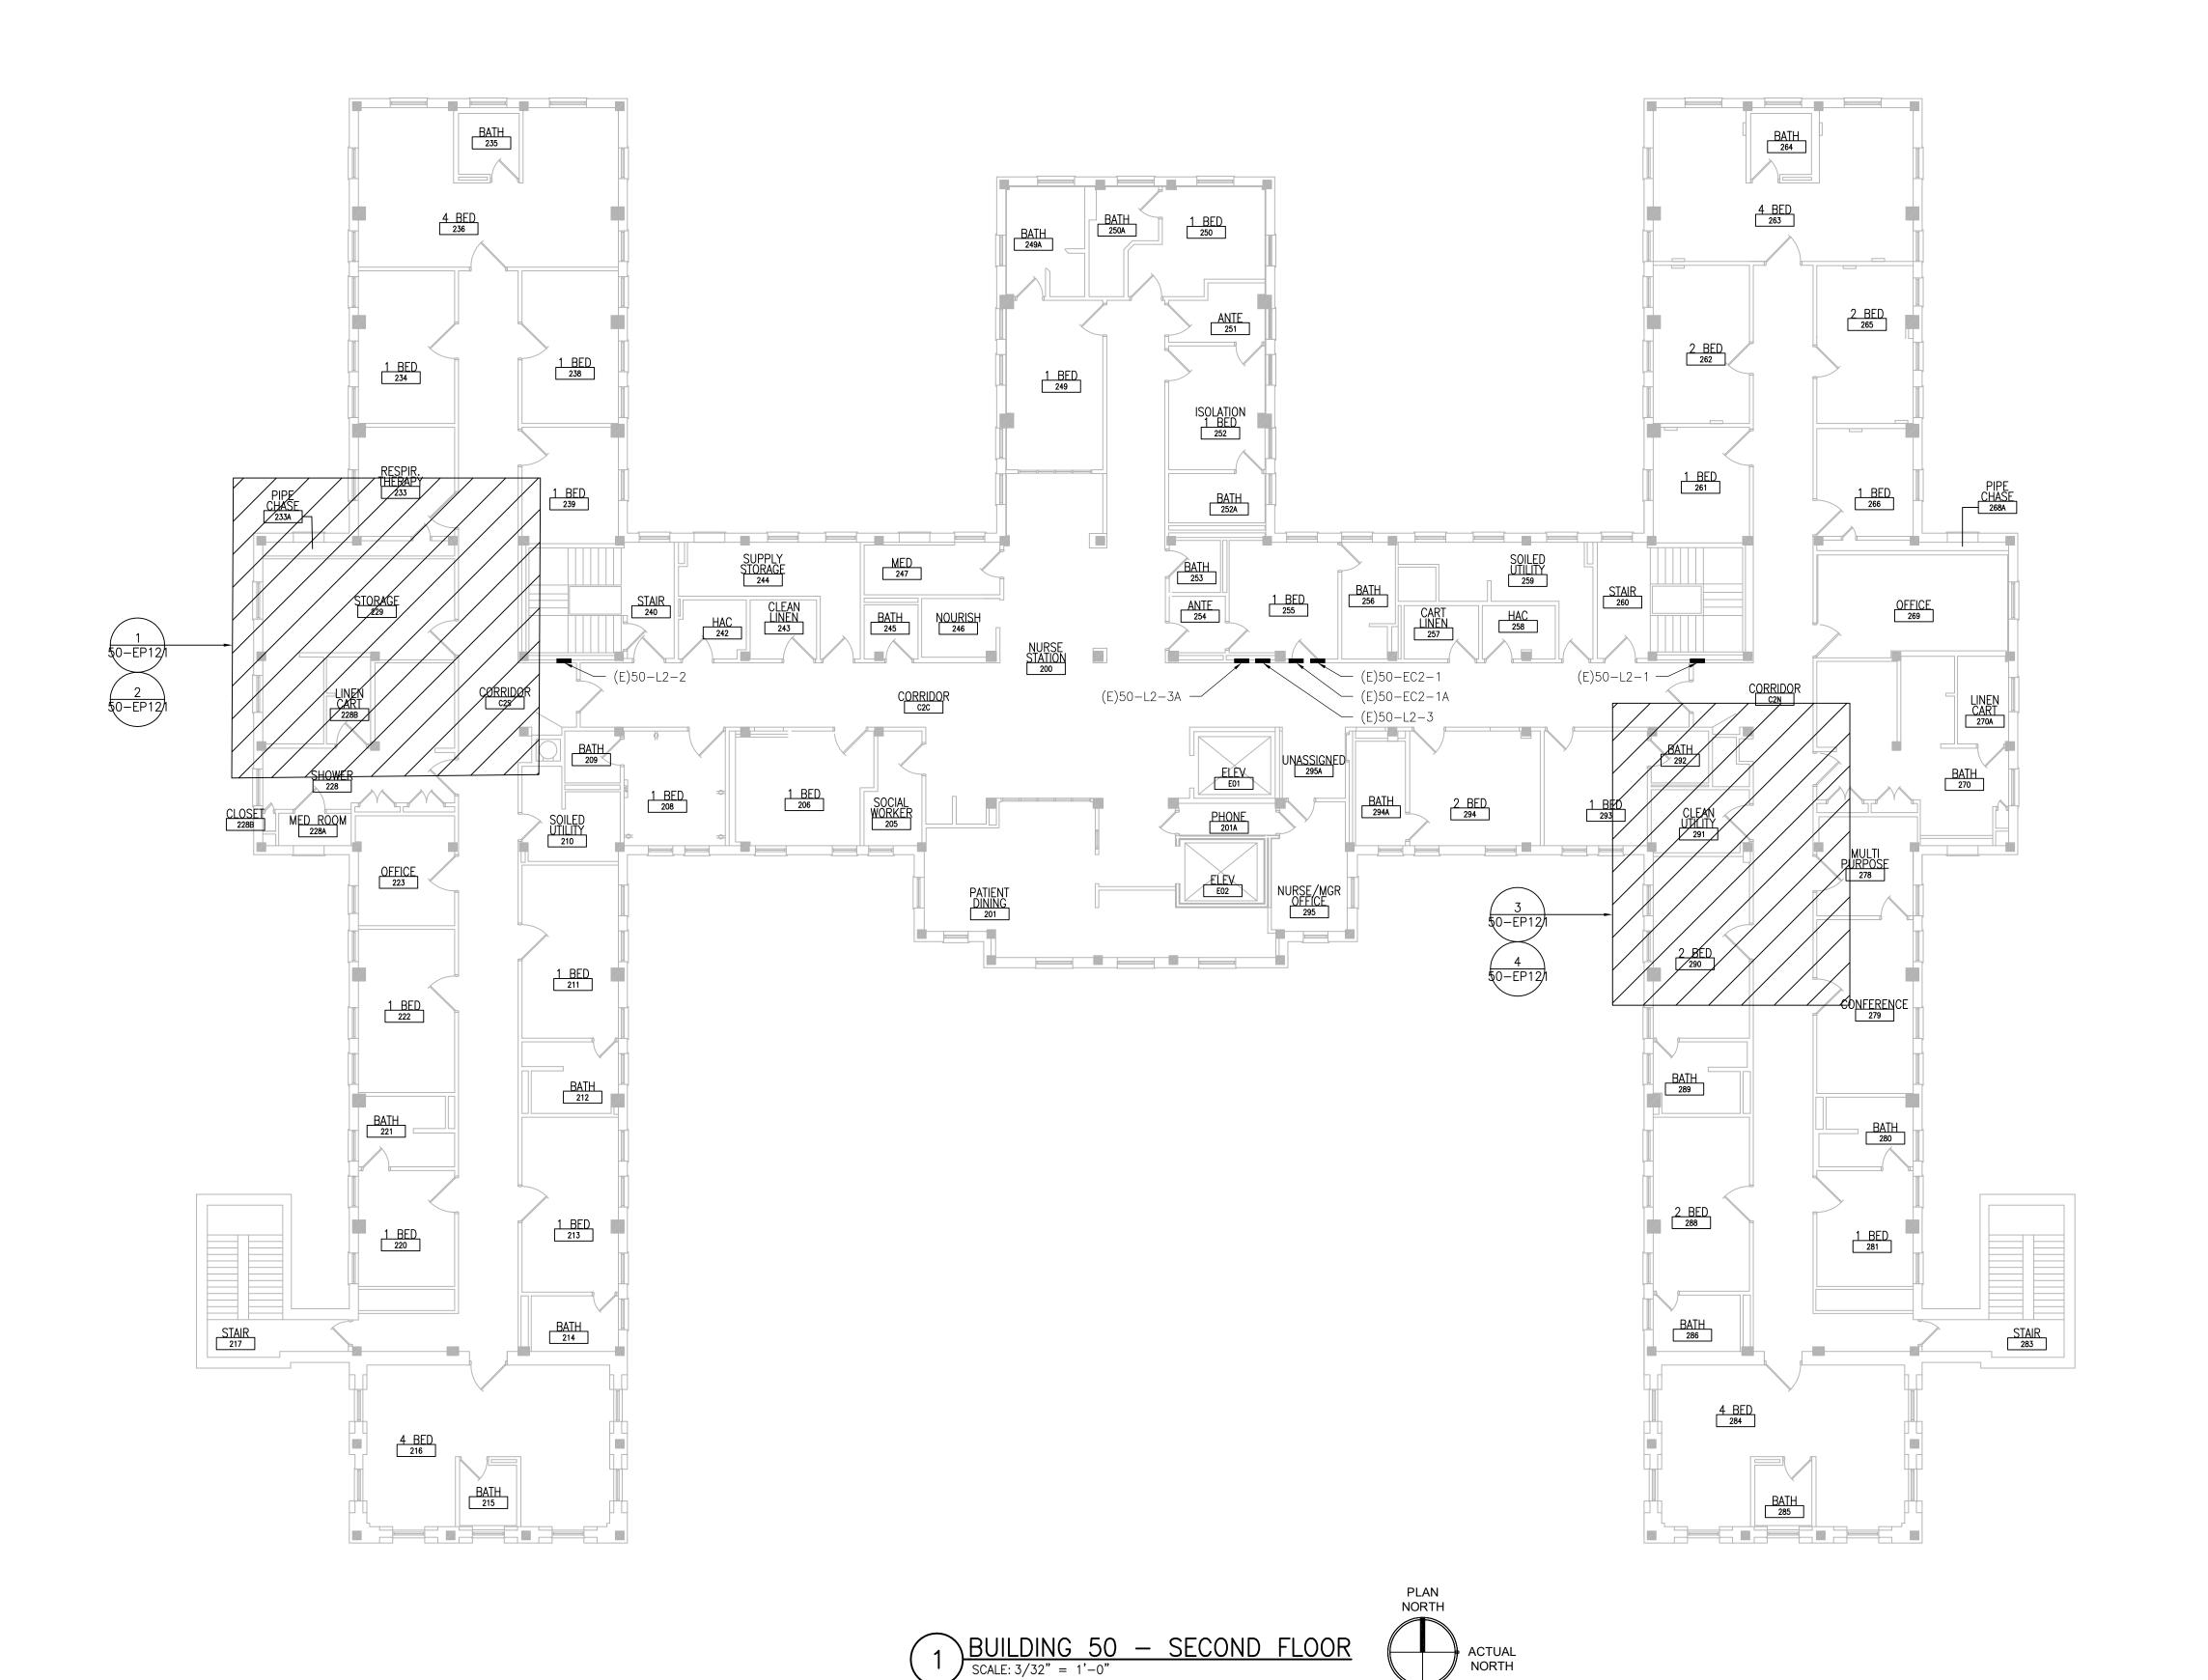

1. REFER TO SHEETS E-001 AND E-002 FOR ABBREVIATIONS, SYMBOLS AND NOTES.

2. REFER TO ARCHITECTURAL DRAWINGS FOR ICRA BARRIER LOCATIONS AND ALL WORK ASSOCIATED WITH CEILINGS.

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6. COORDINATE ACCESS PROCEDURES, PROTECTION OF EXISTING RME STORAGE RACKS/EQUIPMENT, CLEANUP AND WORK HOURS WITH THE VA.

7. REFER TO MECHANICAL AND PIPING DRAWINGS FOR LOCATIONS OF MECHANICAL FOLIPMENT AND ROLLTING OF PIPING/DUICT WORK


EQUIPMENT AND ROUTING OF PIPING/DUCT WORK.

PRINTS OF THIS DRAWING SHALL NOT BE USED FOR ANY PURPOSE WHATSOEVER WITHOUT THE SEAL AND SIGNATURE OF THE PROFESSIONAL ENGINEER. Project Title Drawing Title Project Number MILLER-REMICK LLC PROFESSIONAL ENGINEER ENGINEER OF RECORD Office of 656-18-300 **ELECTRICAL** 100% CONSTRUCTION UPGRADE SPS HVAC & DOCUMENTS NOT FOR CONSTRUCTION SECOND FLOOR - POWER PLAN Miller-Remick LLC

M.E.P. & Structural Engineering
A Service Disabled Veteran Owned
Small Business Construction **ENVIRONMENTAL CONTROLS Building Number** and Facilities MEP Engineers + Architects 1173 Research Way 701 Forest Ave Portland, ME 04103 Approved: Project Director Management Drawing Number Forest, VA 24551 1-866-267-6839 (207) 828-4511 1010 KINGS HIGHWAY SOUTH CHERRY HILL, NEW JERSEY 08034 ST. CLOUD VA MEDICAL CENTER, MN FULLY SPRINKLERED PHONE: (856)429-4000 50-E-121 Checked Drawn U.S. Department of Veterans Affairs FAX: (856)429-5002 MR PROJECT NO: 0376-0011 RC DR 2022-07-15 DESCRIPTION DATE


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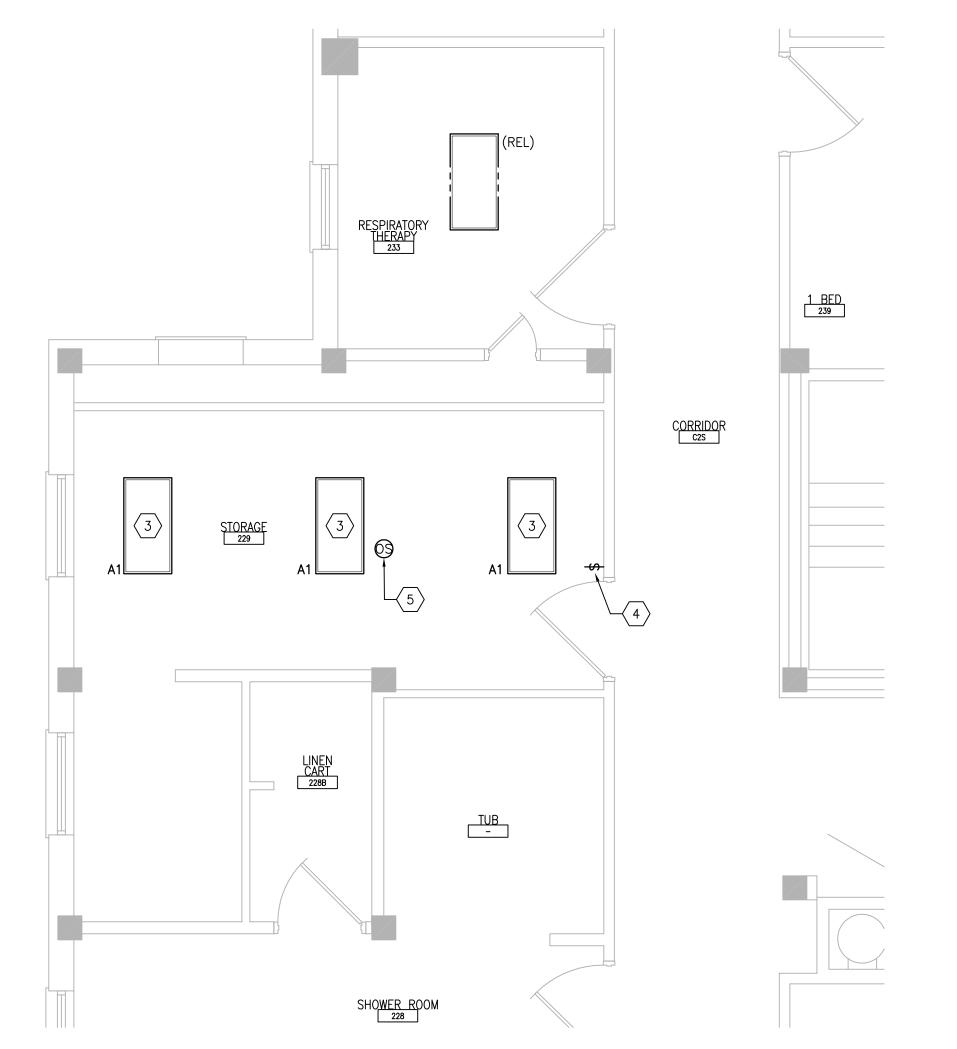
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VA FORM 08-6231


DESCRIPTION

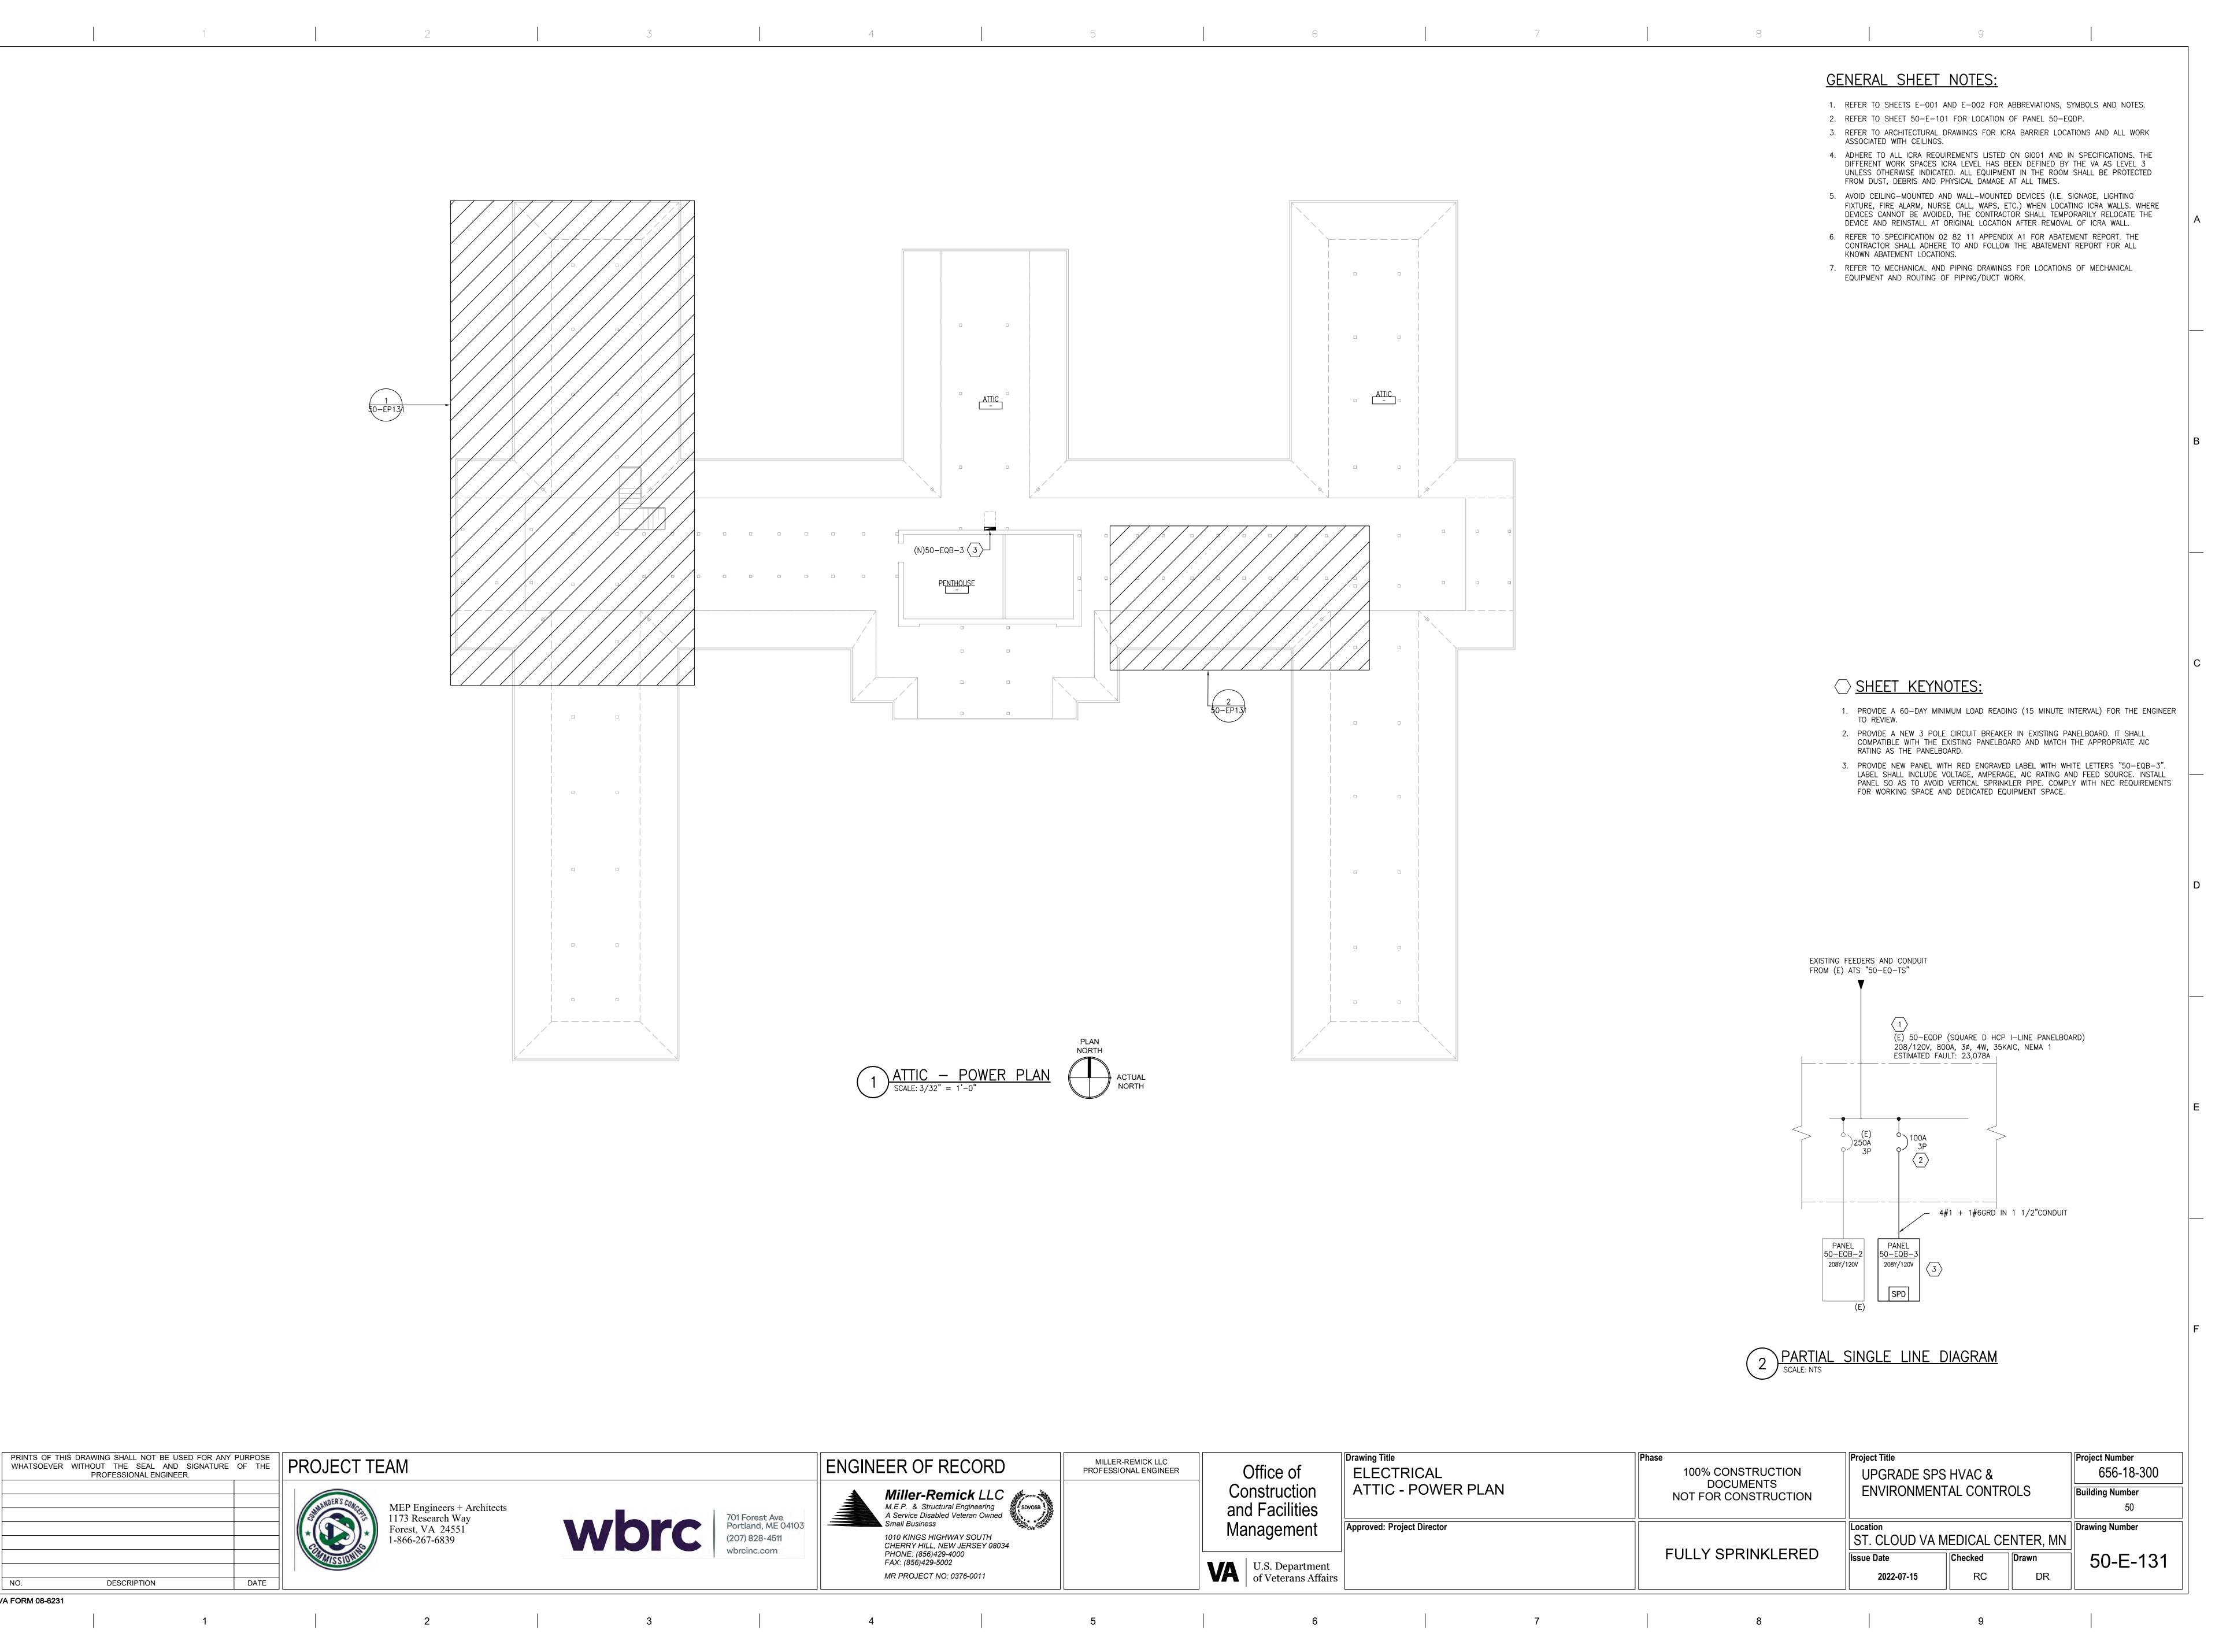




SECOND FLOOR ROOM 229 - NEW WORK

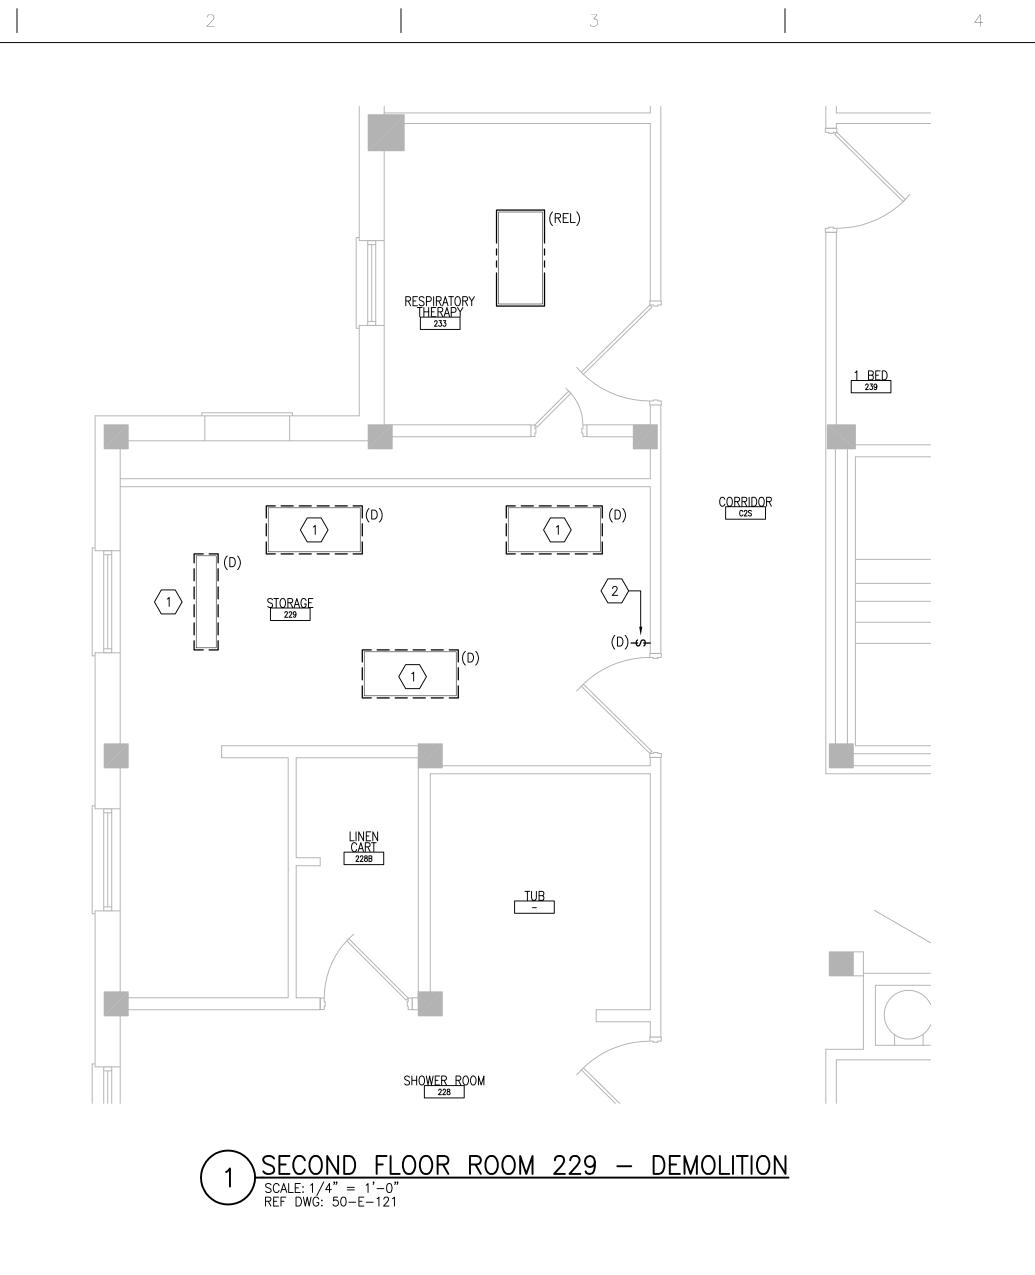SCALE: 1/4" = 1'-0"
REF DWG: 50-E-121

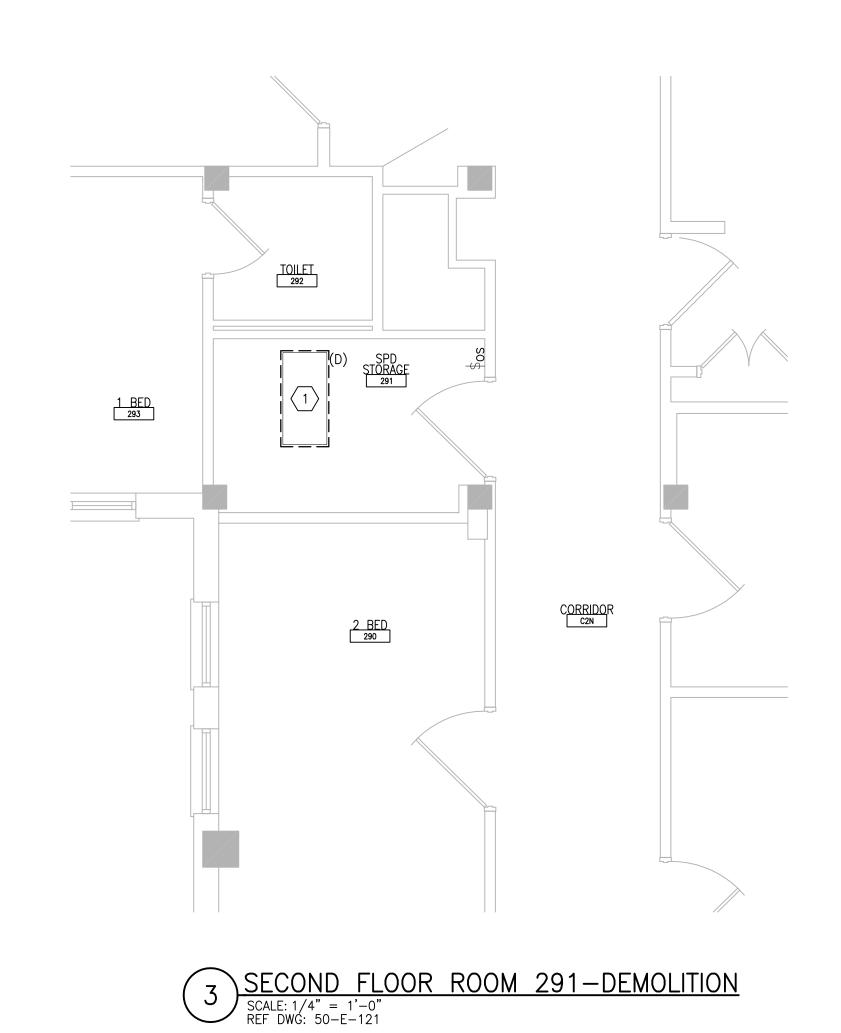

VA FORM 08-6231

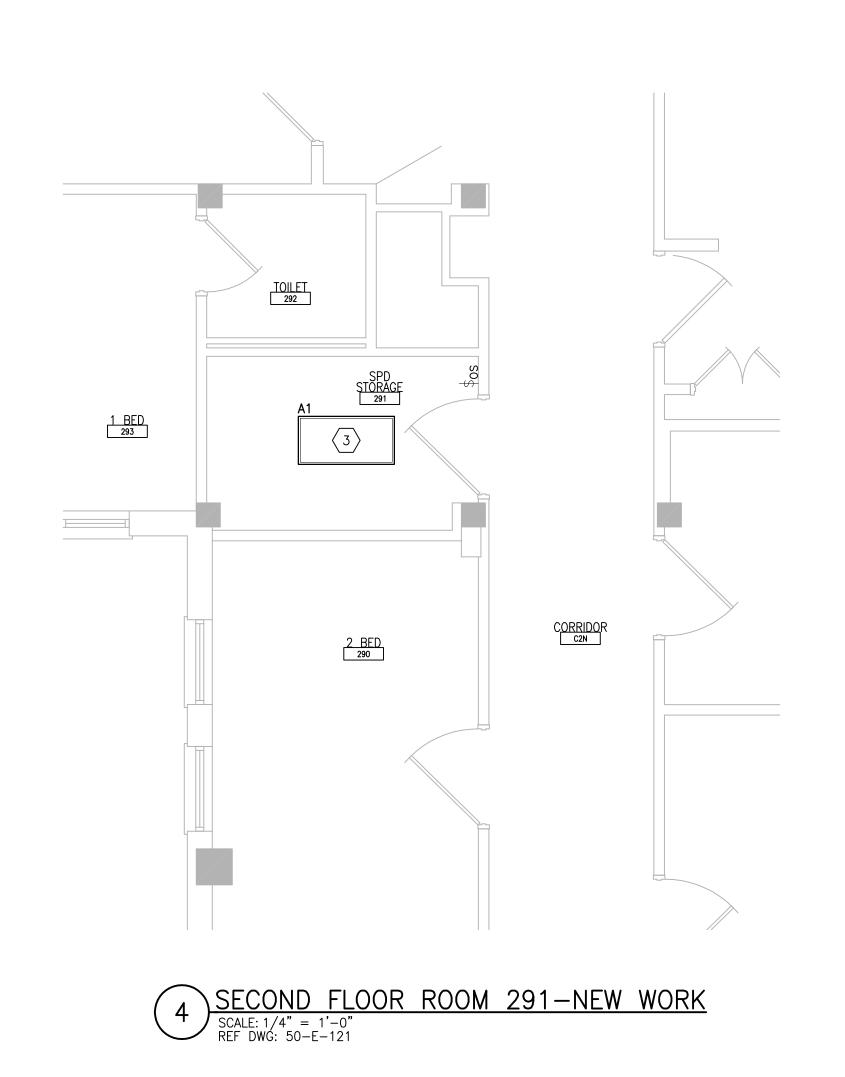

#### **GENERAL SHEET NOTES:**


ASSOCIATED WITH CEILINGS.

- 1. REFER TO SHEETS E-001 AND E-002 FOR ABBREVIATIONS, SYMBOLS AND NOTES.
- 2. REFER TO SERIES E-700 SHEETS FOR PANELBOARD SCHEDULES AND LIGHTING FIXTURE SCHEDULE.
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- 8. REFER TO MECHANICAL AND PIPING DRAWINGS FOR LOCATIONS OF MECHANICAL EQUIPMENT AND ROUTING OF PIPING/DUCT WORK.
- 9. DEVICE/LIGHTING FIXTURE LABELED AS (REL) SHALL BE DISCONNECTED AND REMOVED DURING CONSTRUCTION. UPON INSTALLATION OF NEW CEILING IN THE SPACE,
- RE-INSTALL AND CONNECT EXISTING DEVICE/LIGHTING FIXTURE. PROTECT WIRING AND DEVICE/LIGHTING FIXTURE DURING CONSTRUCTION.
- 10. OCCUPANCY SENSOR WALL SWITCH OR CEILING MOUNTED OCCUPANCY WITH WALL SWITCH SHOWN ON DRAWING SHALL BE CONNECTED TO NEW LIGHTING FIXTURE(S) WITHIN THE SAME SPACE.

#### 


1. DISCONNECT AND REMOVE EXISTING LIGHTING CIRCUIT. PROTECT BRANCH CIRCUIT


- 2. DISCONNECT AND REMOVE EXISTING SWITCH. RETAIN BACK BOX AND ASSOCIATED CONDUIT AND WIRING.
- 3. PROVIDE NEW LIGHTING FIXTURE AND CONNECT TO EXISTING LIGHTING BRANCH CIRCUIT PREVIOUSLY FEEDING DEMOLISHED LIGHTING FIXTURE. CONNECT TO EXISTING ROOM LIGHTING CONTROLS. PROVIDE ADDITIONAL CONDUIT AND WIRING AS NEEDED.
- 4. PROVIDE NEW SWITCH INSTALLED IN EXISTING BACK BOX. CONNECT TO EXISTING LIGHTING BRANCH CIRCUIT.
- 5. PROVIDE NEW CEILING-MOUNTED OCCUPANCY SENSOR. MAKE FINAL CONNECTIONS.

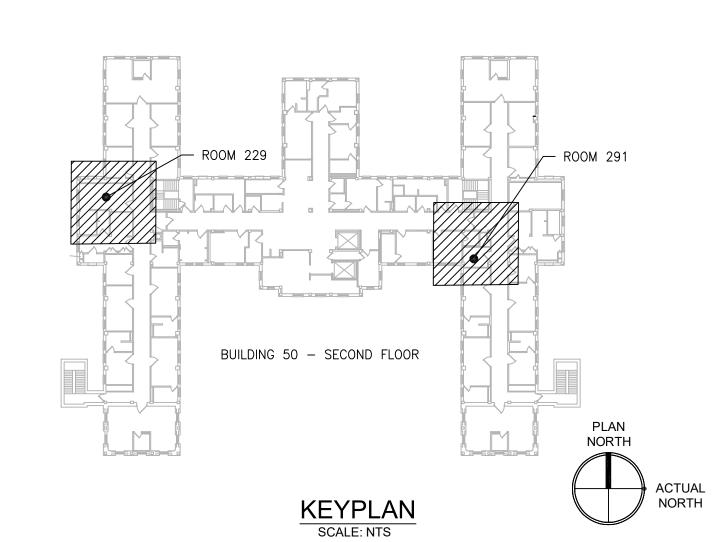

PRINTS OF THIS DRAWING SHALL NOT BE USED FOR ANY PURPOSE WHATSOEVER WITHOUT THE SEAL AND SIGNATURE OF THE PROFESSIONAL ENGINEER. Project Title Drawing Title Project Number MILLER-REMICK LLC PROFESSIONAL ENGINEER PROJECT TEAM ENGINEER OF RECORD Office of 656-18-300 **ELECTRICAL** UPGRADE SPS HVAC & 100% CONSTRUCTION DOCUMENTS NOT FOR CONSTRUCTION SECOND FLOOR - DEMOLITION & NEW Miller-Remick LLC

M.E.P. & Structural Engineering
A Service Disabled Veteran Owned
Small Business Construction **ENVIRONMENTAL CONTROLS Building Number** WORK PART PLANS and Facilities MEP Engineers + Architects 1173 Research Way 701 Forest Ave Portland, ME 04103 Approved: Project Director Management Drawing Number Forest, VA 24551 1-866-267-6839 (207) 828-4511 1010 KINGS HIGHWAY SOUTH CHERRY HILL, NEW JERSEY 08034 ST. CLOUD VA MEDICAL CENTER, MN **FULLY SPRINKLERED** PHONE: (856)429-4000 Checked Drawn 50-EP121 FAX: (856)429-5002 U.S. Department of Veterans Affairs RC DR MR PROJECT NO: 0376-0011 2022-07-15 DESCRIPTION DATE

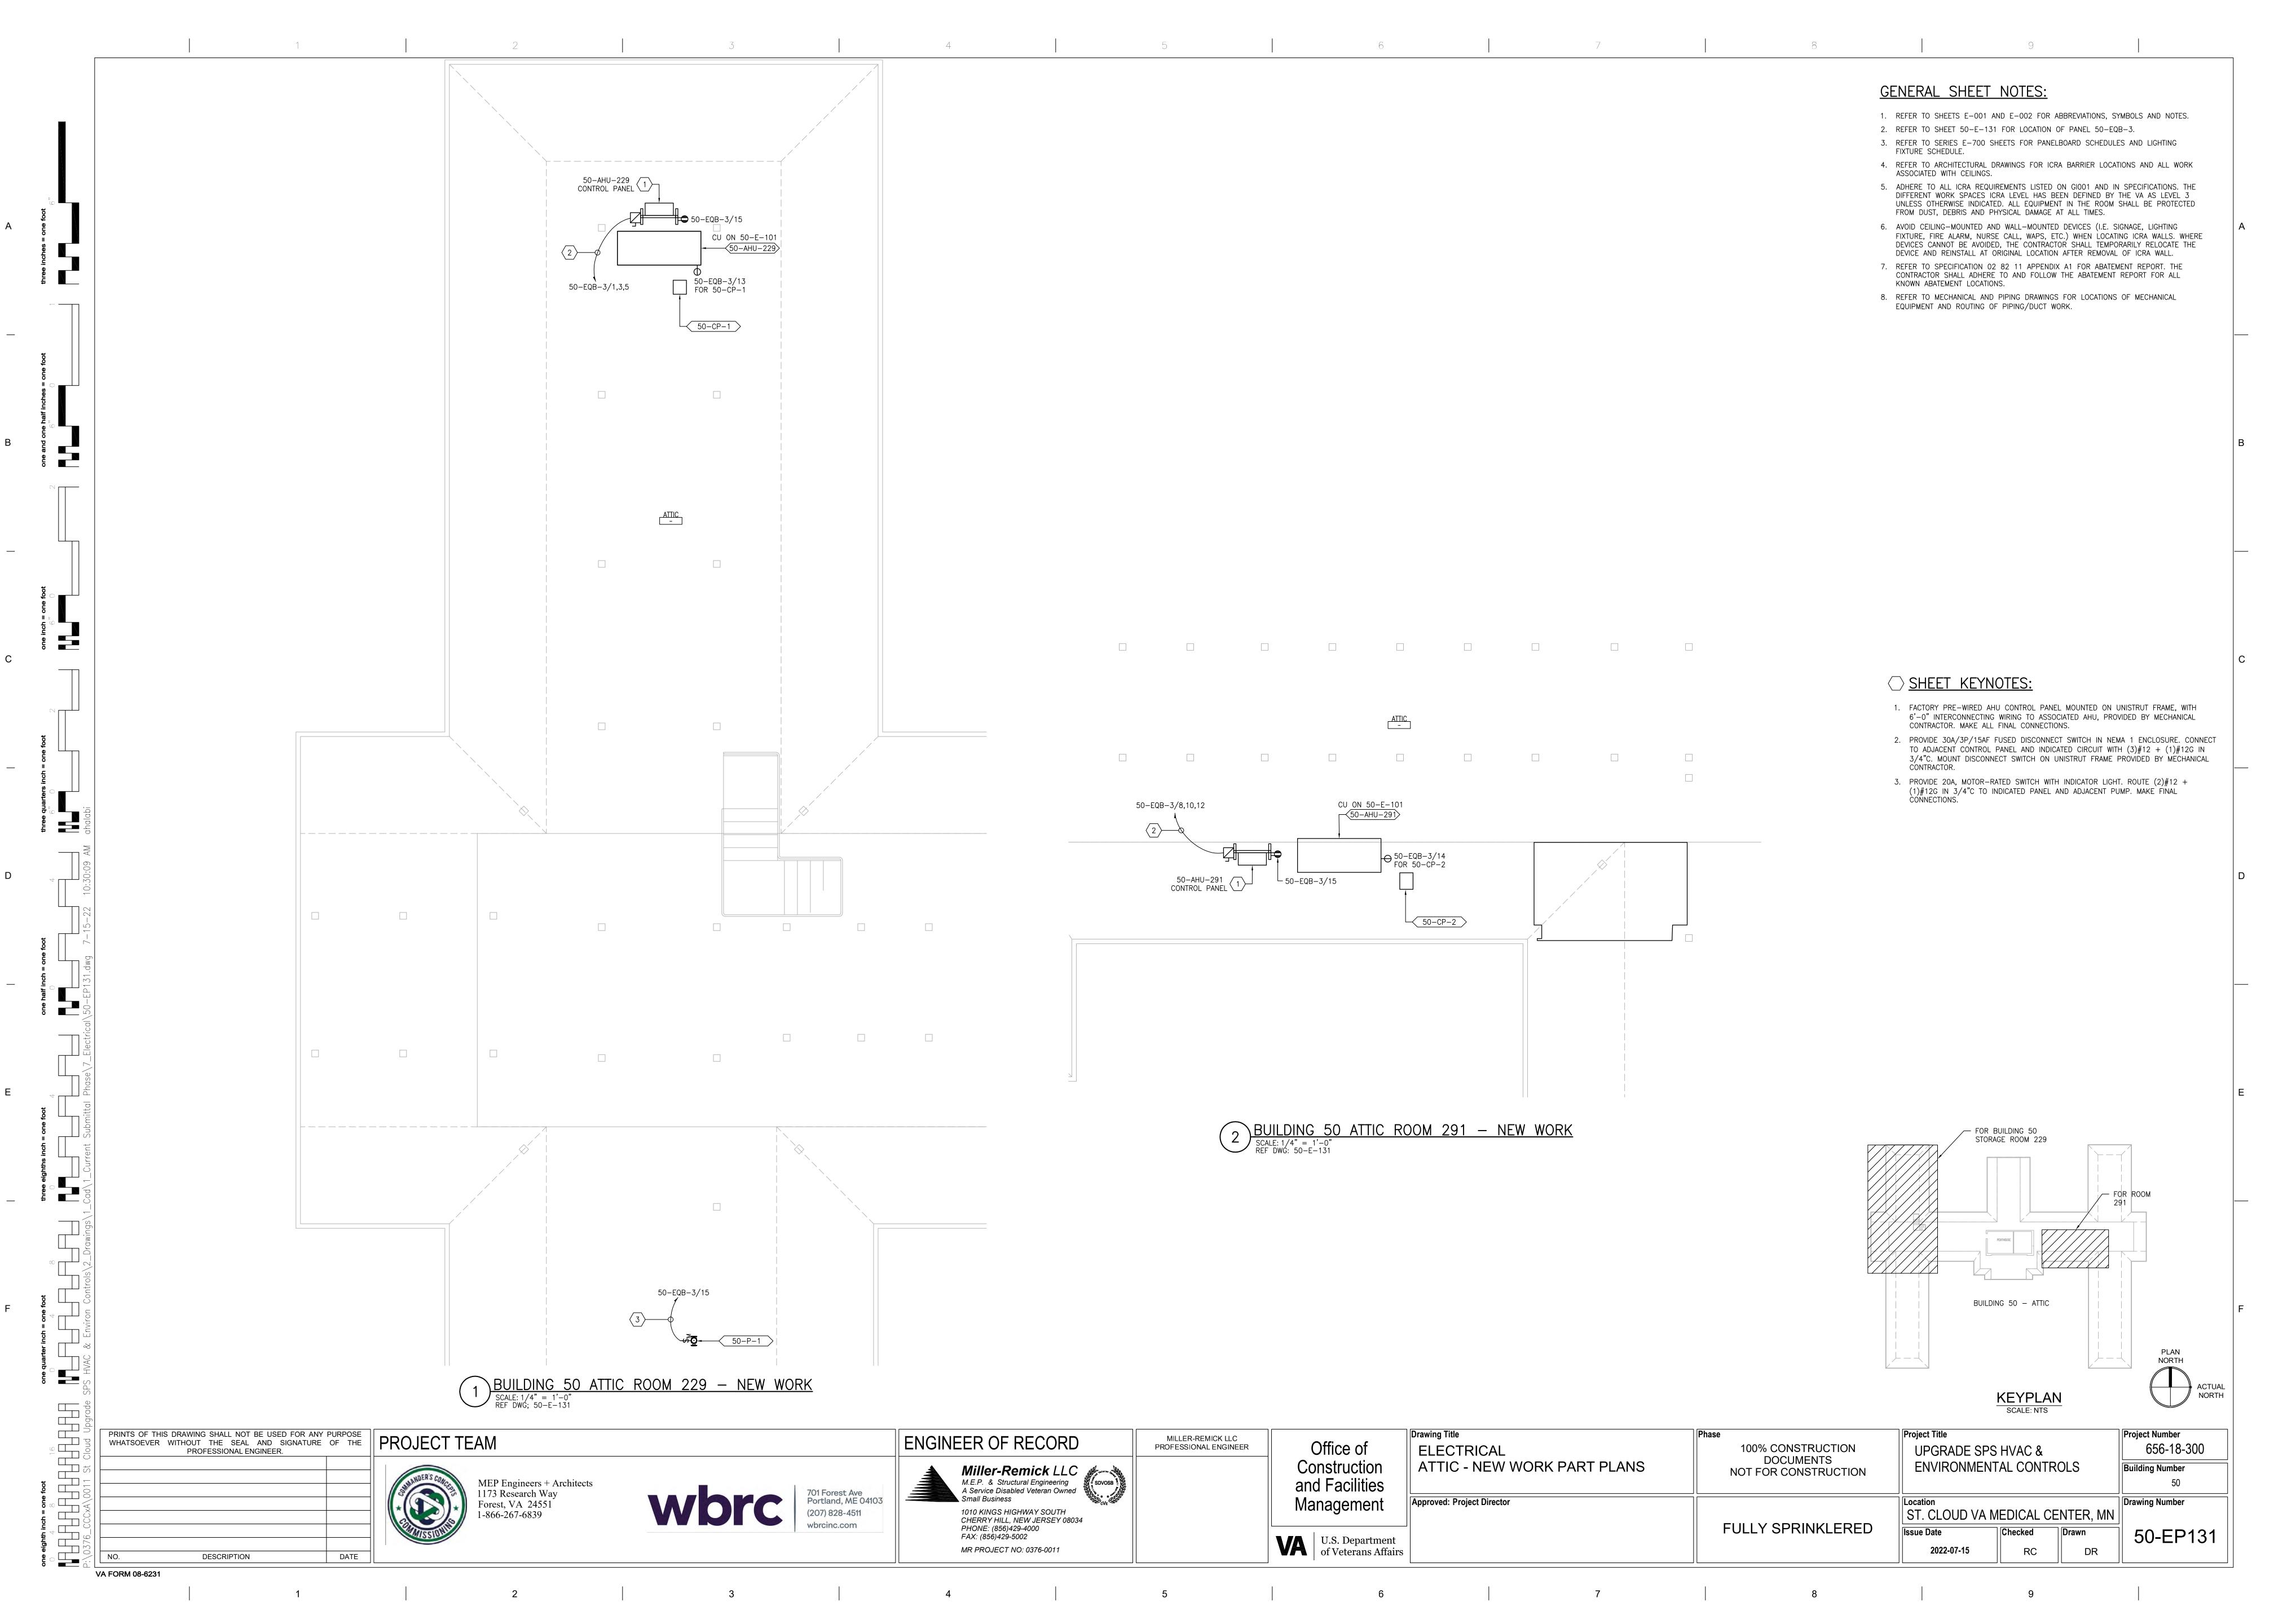

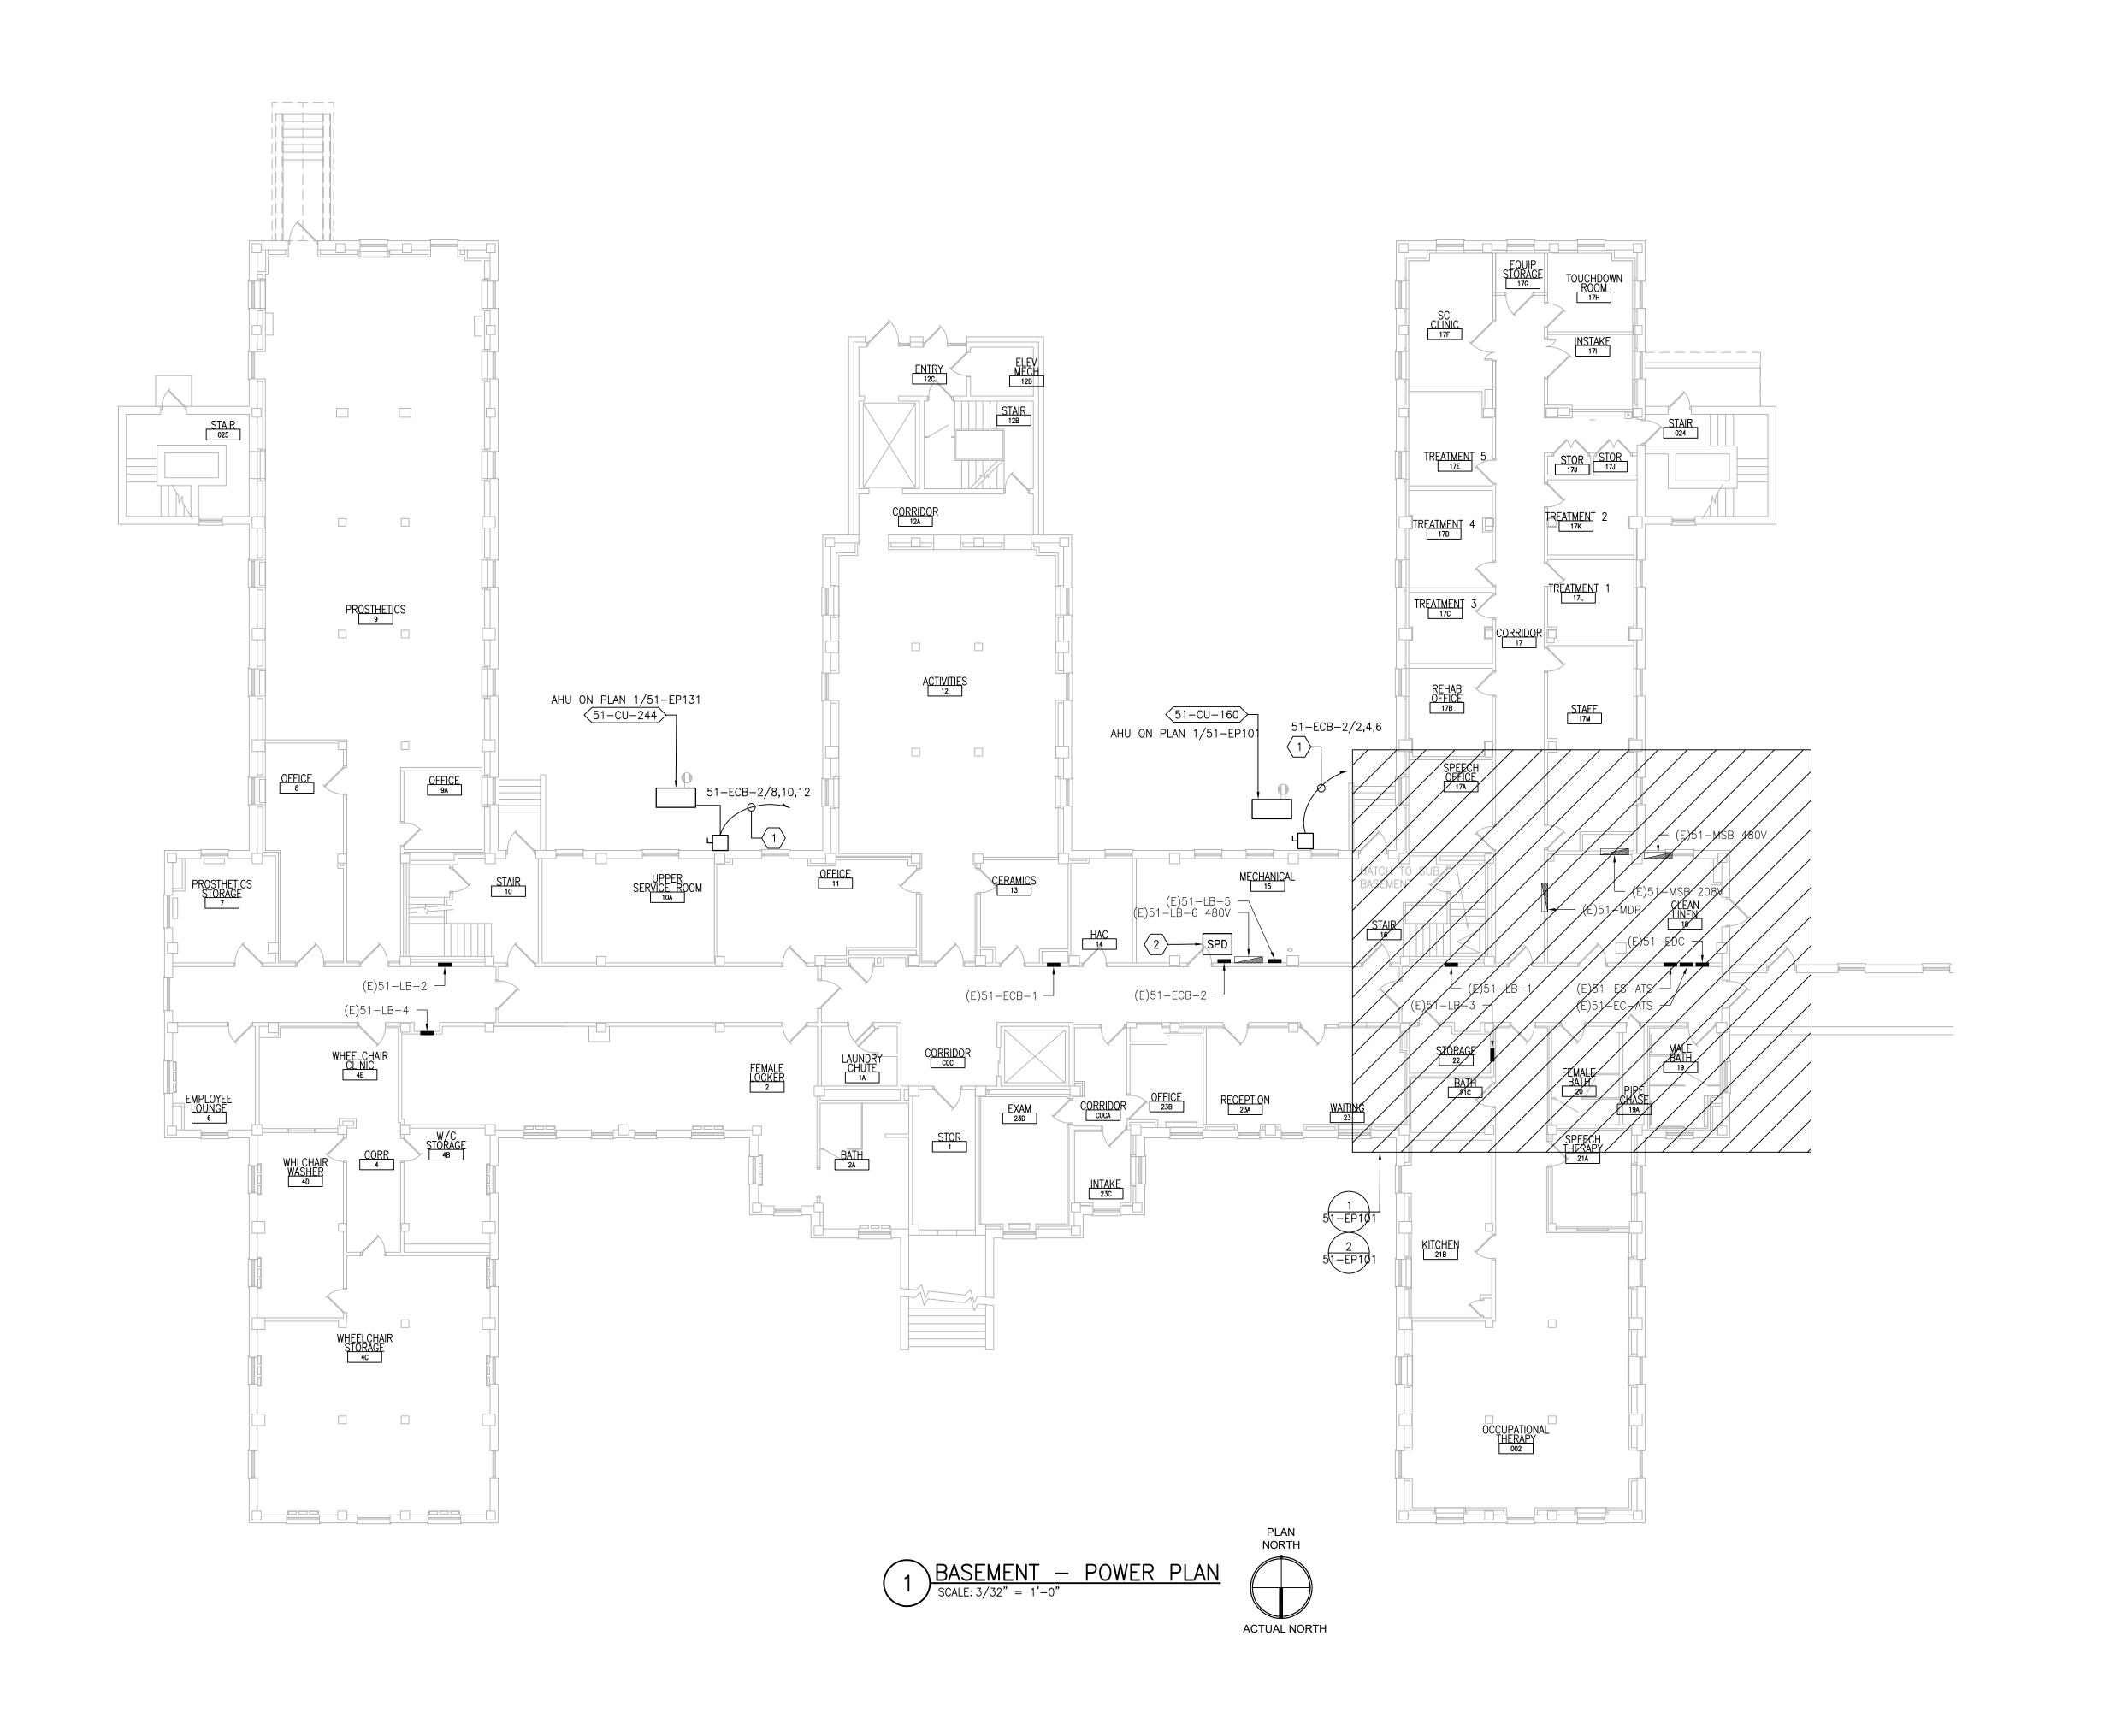

ENGINEER OF RECORD

701 Forest Ave Portland, ME 04103

(207) 828-4511

3

Miller-Remick LLC

M.E.P. & Structural Engineering
A Service Disabled Veteran Owned
Small Business

1010 KINGS HIGHWAY SOUTH CHERRY HILL, NEW JERSEY 08034

PHONE: (856)429-4000

MR PROJECT NO: 0376-0011

FAX: (856)429-5002

MILLER-REMICK LLC

PROFESSIONAL ENGINEER

5

Drawing Title

**ELECTRICAL** 

Approved: Project Director

BASEMENT - POWER PLAN

Office of

Construction

and Facilities

Management

U.S. Department of Veterans Affairs

VA FORM 08-6231

PRINTS OF THIS DRAWING SHALL NOT BE USED FOR ANY PURPOSE WHATSOEVER WITHOUT THE SEAL AND SIGNATURE OF THE PROFESSIONAL ENGINEER.

DESCRIPTION

DATE

MEP Engineers + Architects 1173 Research Way

Forest, VA 24551 1-866-267-6839

### **GENERAL SHEET NOTES:**

- 1. REFER TO SHEETS E-001 AND E-002 FOR ABBREVIATIONS, SYMBOLS AND NOTES.
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- 7. <u>CONDENSING UNITS AND PACKAGED AHU'S:</u> UNITS ARE PROVIDED WITH A FACTORY WIRED 120V RECEPTACLE SHOWN IN GRAY—SCALE (FOR REFERENCE ONLY).

#### 

Project Title

UPGRADE SPS HVAC &

2022-07-15

**ENVIRONMENTAL CONTROLS** 

ST. CLOUD VA MEDICAL CENTER, MN

Checked

RC

DR

100% CONSTRUCTION

DOCUMENTS

NOT FOR CONSTRUCTION

**FULLY SPRINKLERED** 

Project Number


**Building Number** 

Drawing Number

656-18-300

51-E-101

- PROVIDE 30A/3P/NF DISCONNECT SWITCH IN NEMA 3R ENCLOSURE. CONNECT TO
  ADJACENT CU AND INDICATED CIRCUIT WITH (3)#10 + (1)#10G IN 3/4"C. PROVIDE
  GALVANIZED STEEL FRAME WITH GALVANIZED HARDWARE FOR MOUNTING OF DISCONNECT
  SWITCH ON WALL.
- 2. PROVIDE SPD IN NEMA 1 ENCLOSURE BELOW OR ADJACENT TO ASSOCIATED PANEL. MAKE FINAL CONNECTIONS. REFER TO SHEET E-702.

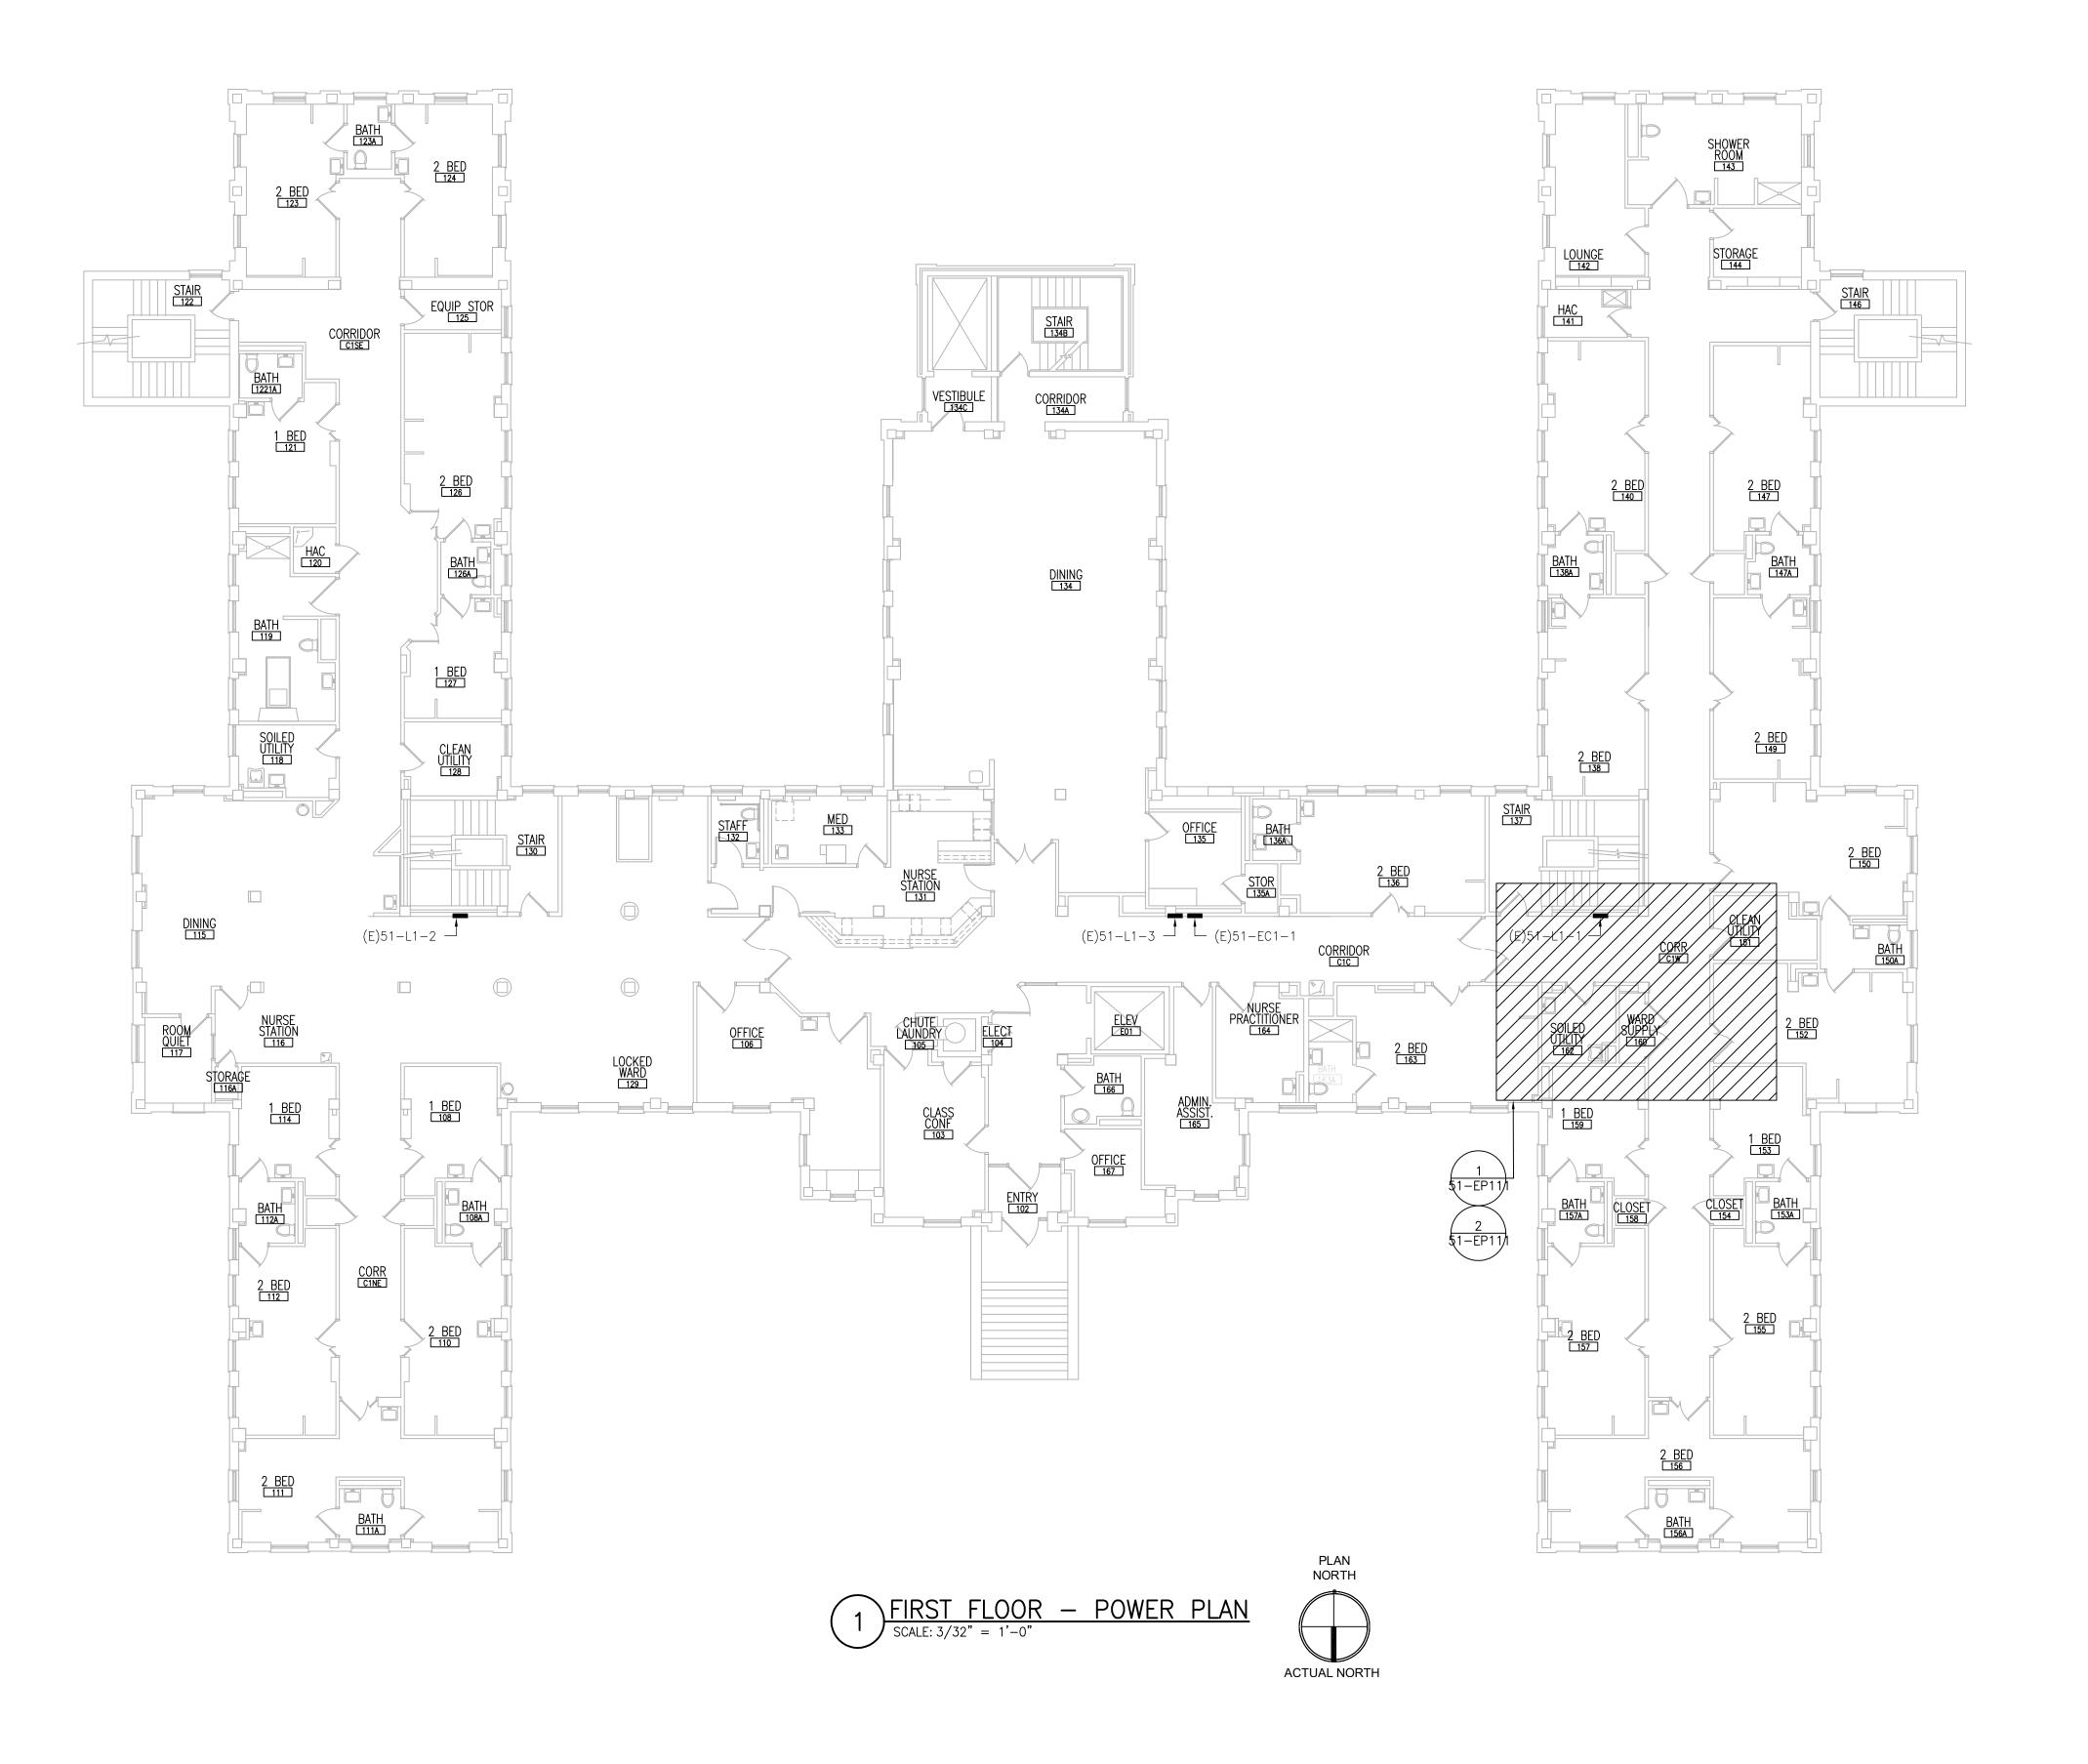

ENGINEER OF RECORD

FAX: (856)429-5002

MR PROJECT NO: 0376-0011

701 Forest Ave Portland, ME 04103 (207) 828-4511

3

Miller-Remick LLC

M.E.P. & Structural Engineering

A Service Disabled Veteran Owned

Small Business

1010 KINGS HIGHWAY SOUTH CHERRY HILL, NEW JERSEY 08034 PHONE: (856)429-4000

MILLER-REMICK LLC PROFESSIONAL ENGINEER

5

VA FORM 08-6231

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DESCRIPTION

PROJECT TEAM

DATE

MEP Engineers + Architects 1173 Research Way Forest, VA 24551 1-866-267-6839


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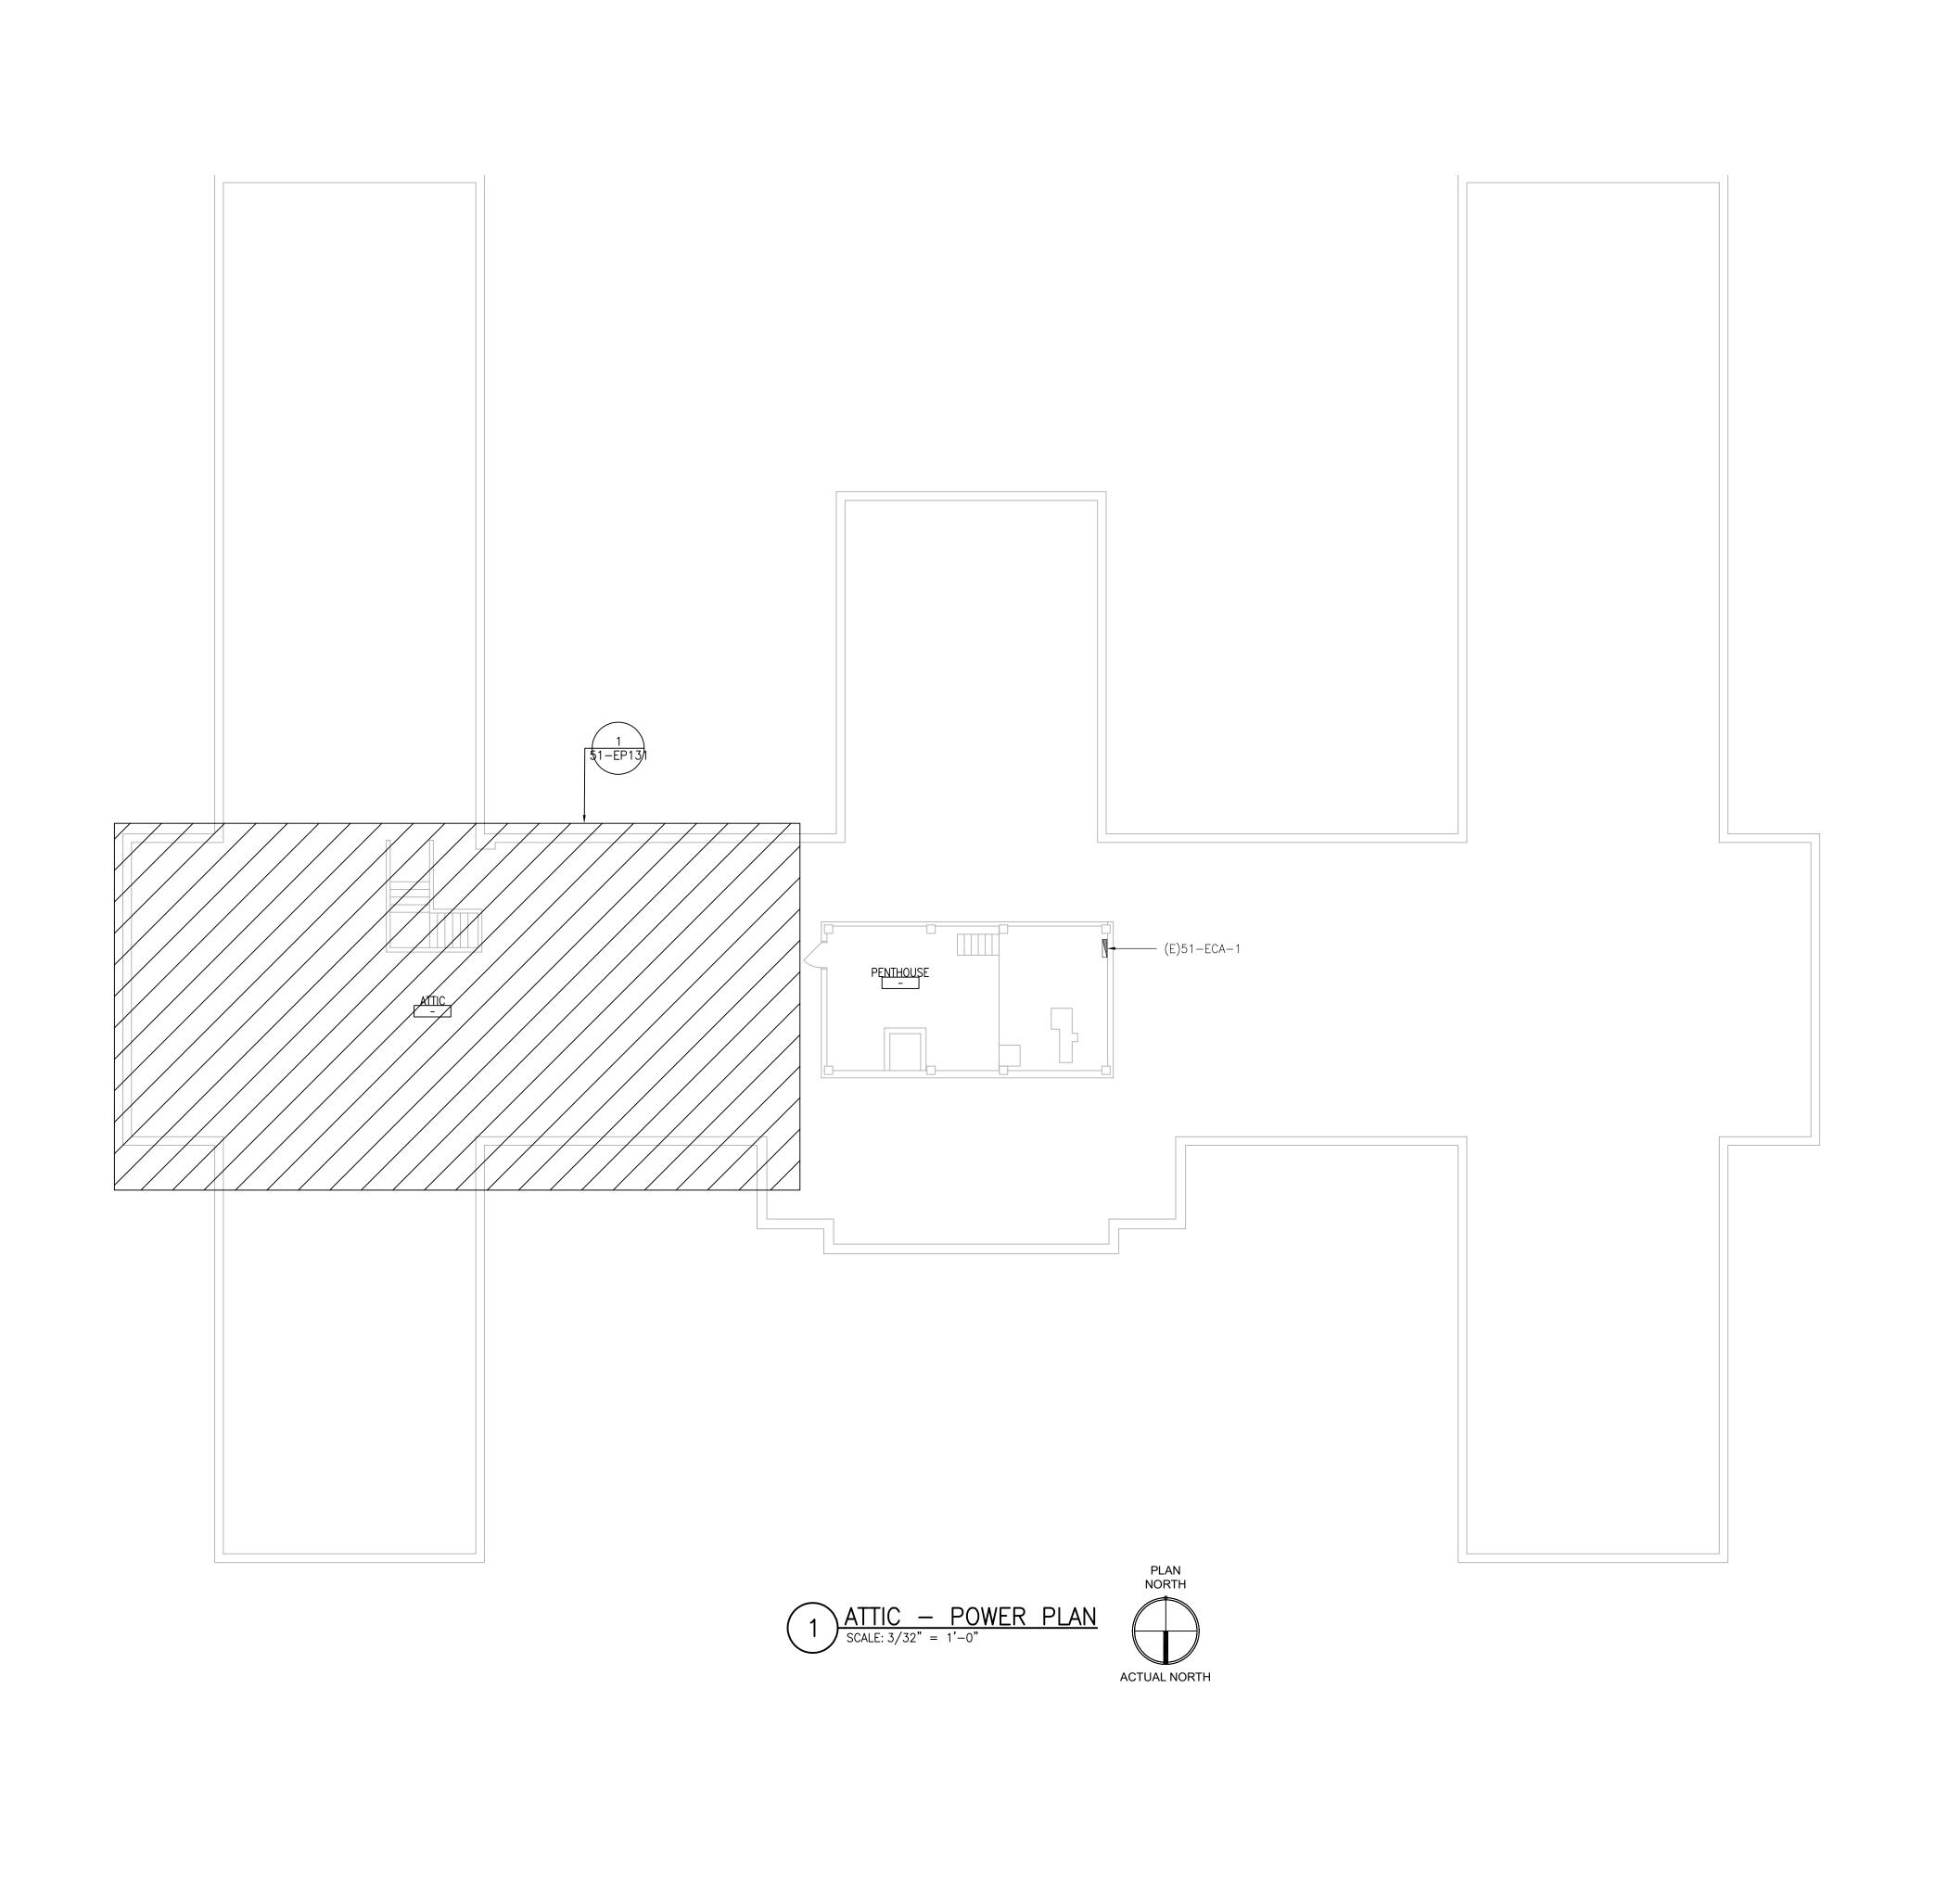
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	Drawing Title	Phase	Project Title			Project Number
Office of	ELECTRICAL	100% CONSTRUCTION	UPGRADE SPS	SHVAC &		656-18-300
Construction	FIRST FLOOR - POWER PLAN	DOCUMENTS NOT FOR CONSTRUCTION	ENVIRONMENT	TAL CONTR	OLS	Building Number
and Facilities						51
Management	Approved: Project Director		Location			Drawing Number
			ST. CLOUD VA M	<u> 1EDICAL CE</u>	ENTER, MN	
U.S. Department		FULLY SPRINKLERED	Issue Date	Checked	Drawn	51-E-111
U.S. Department of Veterans Affairs			2022-07-15	RC	DR	



- 1. REFER TO SHEETS E-001 AND E-002 FOR ABBREVIATIONS, SYMBOLS AND NOTES.
- 2. REFER TO SERIES E-700 SHEETS FOR PANELBOARD SCHEDULES AND LIGHTING FIXTURE SCHEDULE.
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	MEP Engineers + Architects 1173 Research Way	701 Forest Ave	Miller-Remick LLC  M.E.P. & Structural Engineering A Service Disabled Veteran Owned		Construction and Facilities	SECOND FLOOR - POWER PLAN	DOCUMENTS NOT FOR CONSTRUCTION	ENVIRONMENTAL CONTR	ROLS	Building Number 51
	Forest, VA 24551 1-866-267-6839	701 Forest Ave Portland, ME 04103 (207) 828-4511 wbrcinc.com	Small Business  1010 KINGS HIGHWAY SOUTH CHERRY HILL, NEW JERSEY 08034 PHONE: (856)429-4000 FAX: (856)429-5002		Management	Approved: Project Director	FULLY SPRINKLERED	ST. CLOUD VA MEDICAL CE		<b>」</b>
NO. DESCRIPTION DATE	TO STORY OF THE PROPERTY OF TH		FAX: (856)429-5002 MR PROJECT NO: 0376-0011		U.S. Department of Veterans Affair	rs		2022-07-15 RC	DR	51-E-121



ENGINEER OF RECORD

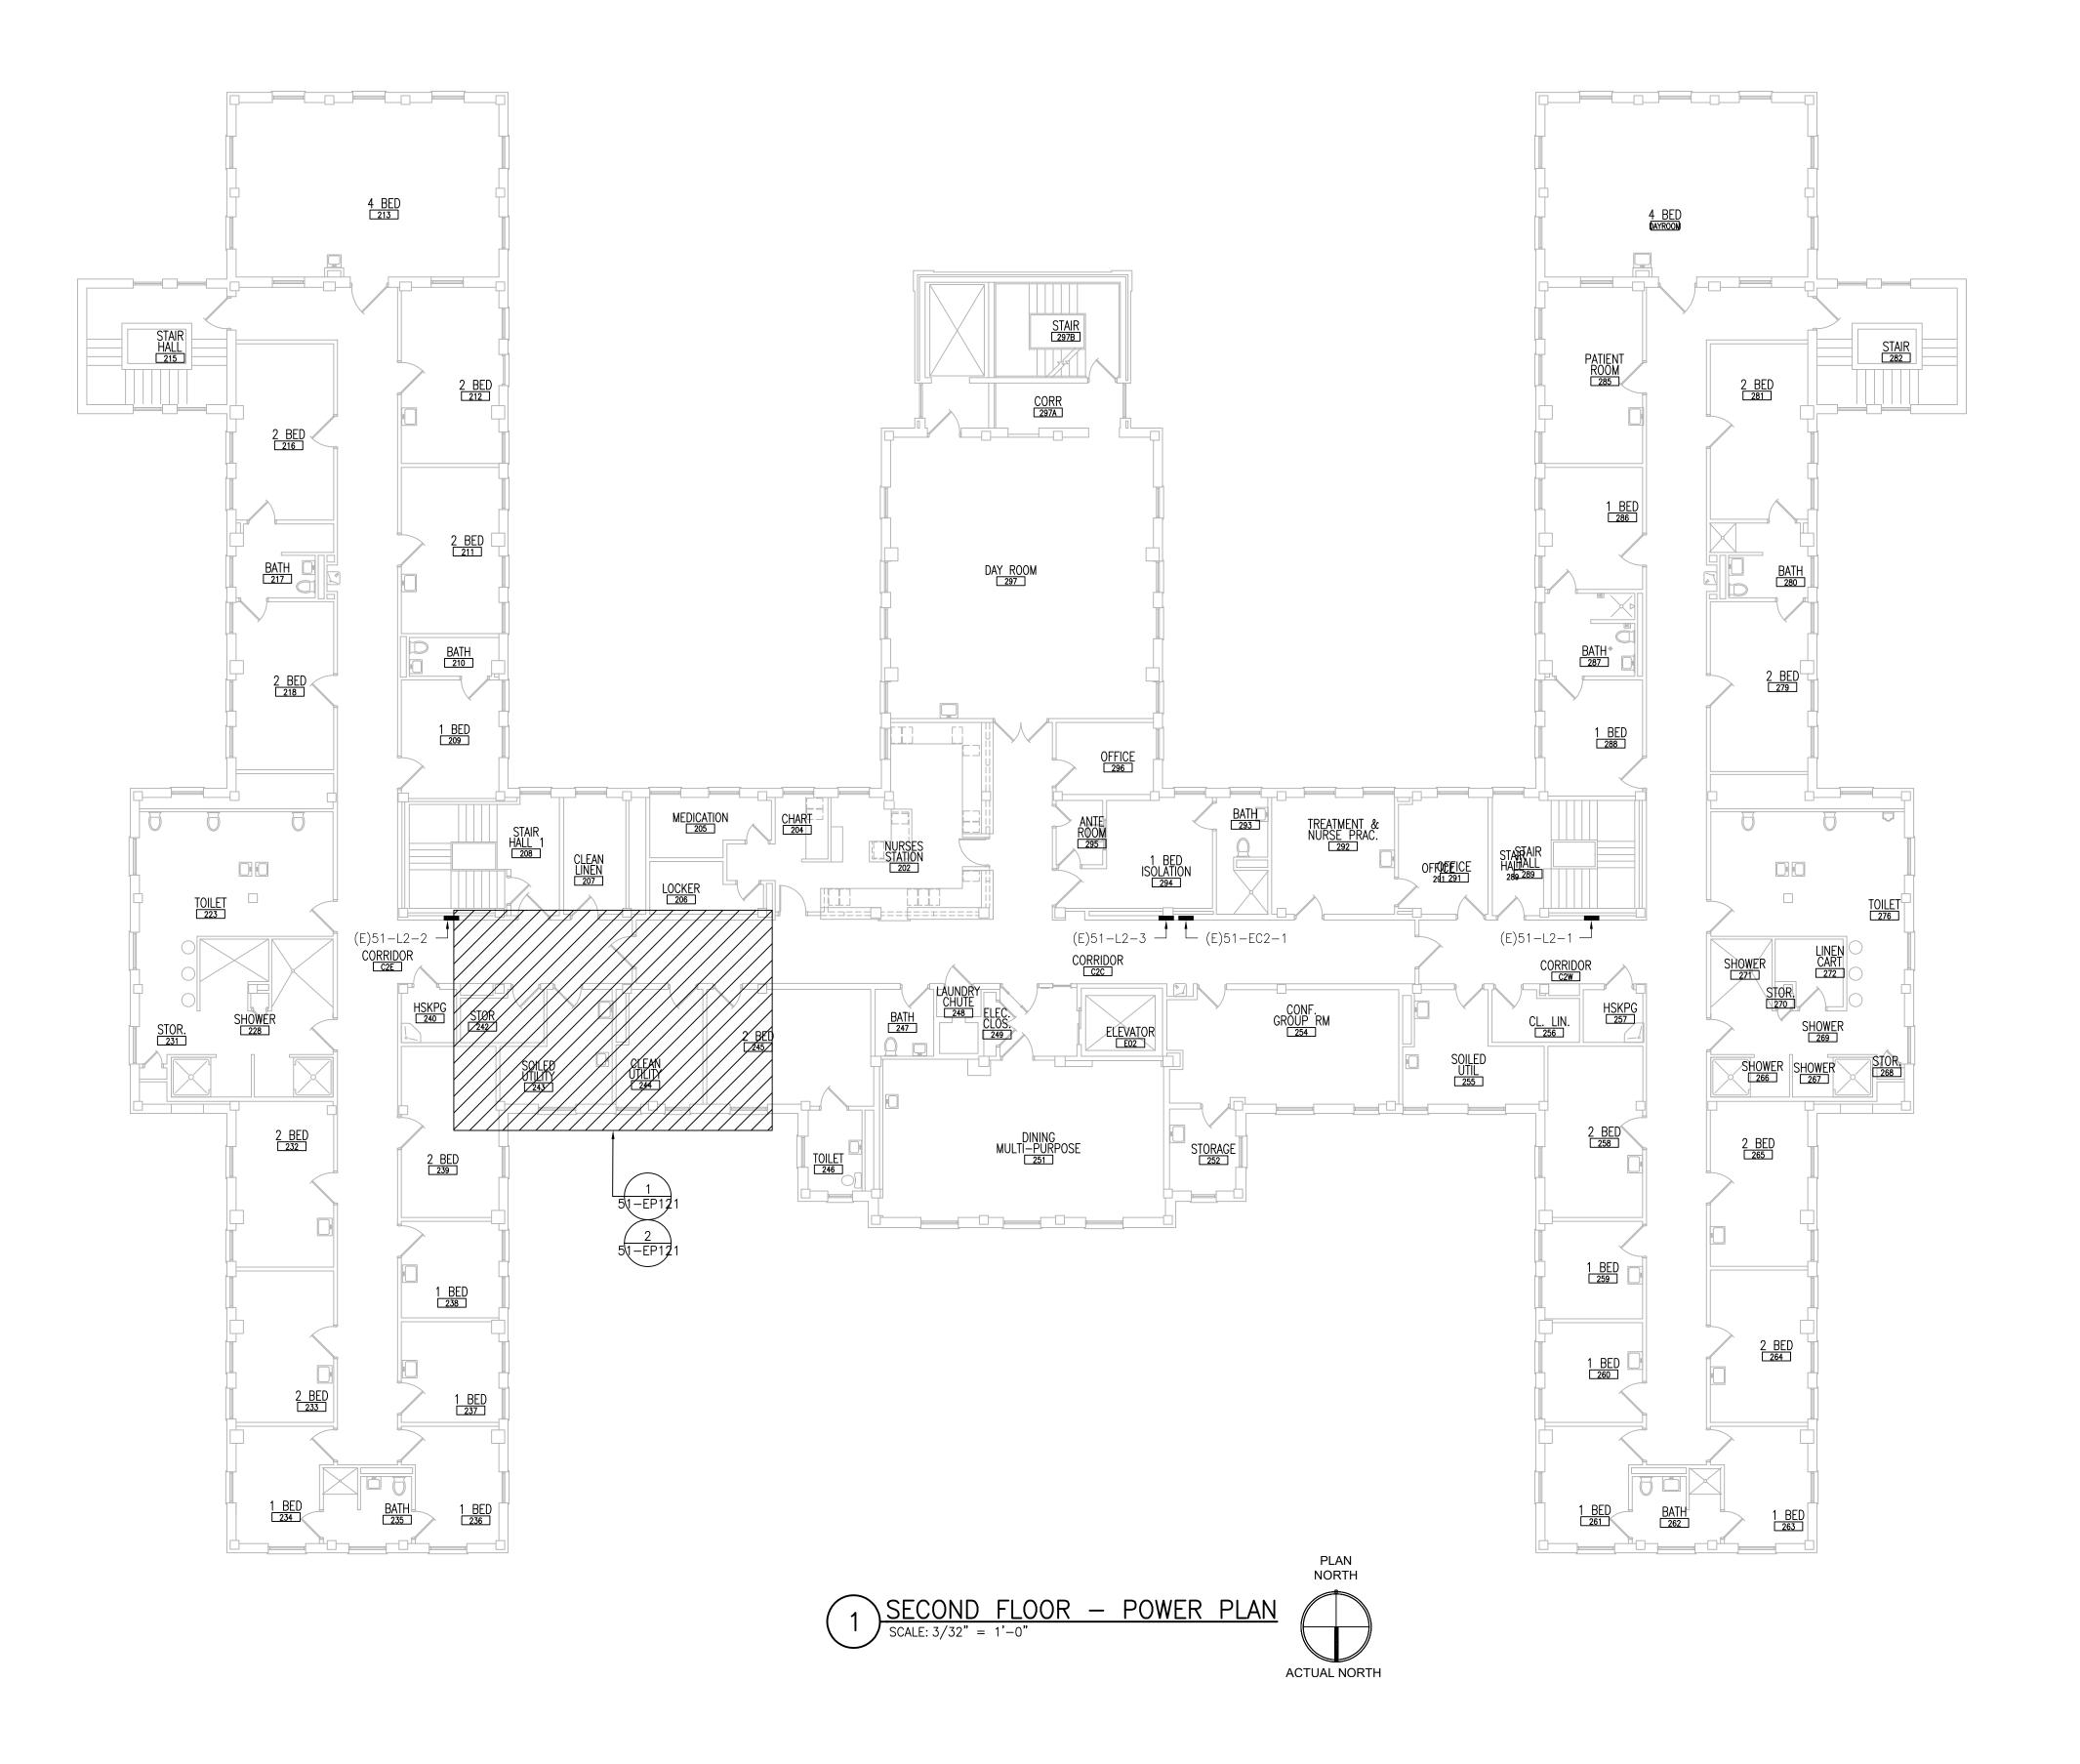701 Forest Ave Portland, ME 04103 (207) 828-4511 Miller-Remick LLC

M.E.P. & Structural Engineering
A Service Disabled Veteran Owned
Small Business

1010 KINGS HIGHWAY SOUTH CHERRY HILL, NEW JERSEY 08034 PHONE: (856)429-4000 FAX: (856)429-5002

MR PROJECT NO: 0376-0011

MILLER-REMICK LLC PROFESSIONAL ENGINEER

Office of

Construction and Facilities

Management

U.S. Department of Veterans Affairs

4 5

VA FORM 08-6231

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DESCRIPTION

DATE

MEP Engineers + Architects 1173 Research Way Forest, VA 24551 1-866-267-6839

1 2 3


### **GENERAL SHEET NOTES:**


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Drawing Title	Phase	Location ST. CLOUD VA MEDICAL CENTER, MN Drawing Number	
ELECTRICAL	III		
ATTIC - POWER PLAN	NOT FOR CONSTRUCTION		
Approved: Project Director			
	AN  DOCUMENTS NOT FOR CONSTRUCTION  ENVIRONMENTAL CONTROLS  Building Number 51  Location ST. CLOUD VA MEDICAL CENTER, MN		
	FULLY SPRINKLERED	UPGRADE SPS HVAC & 656-18-300 ENVIRONMENTAL CONTROLS  Building Number 51  Location ST. CLOUD VA MEDICAL CENTER, MN	

2022-07-15



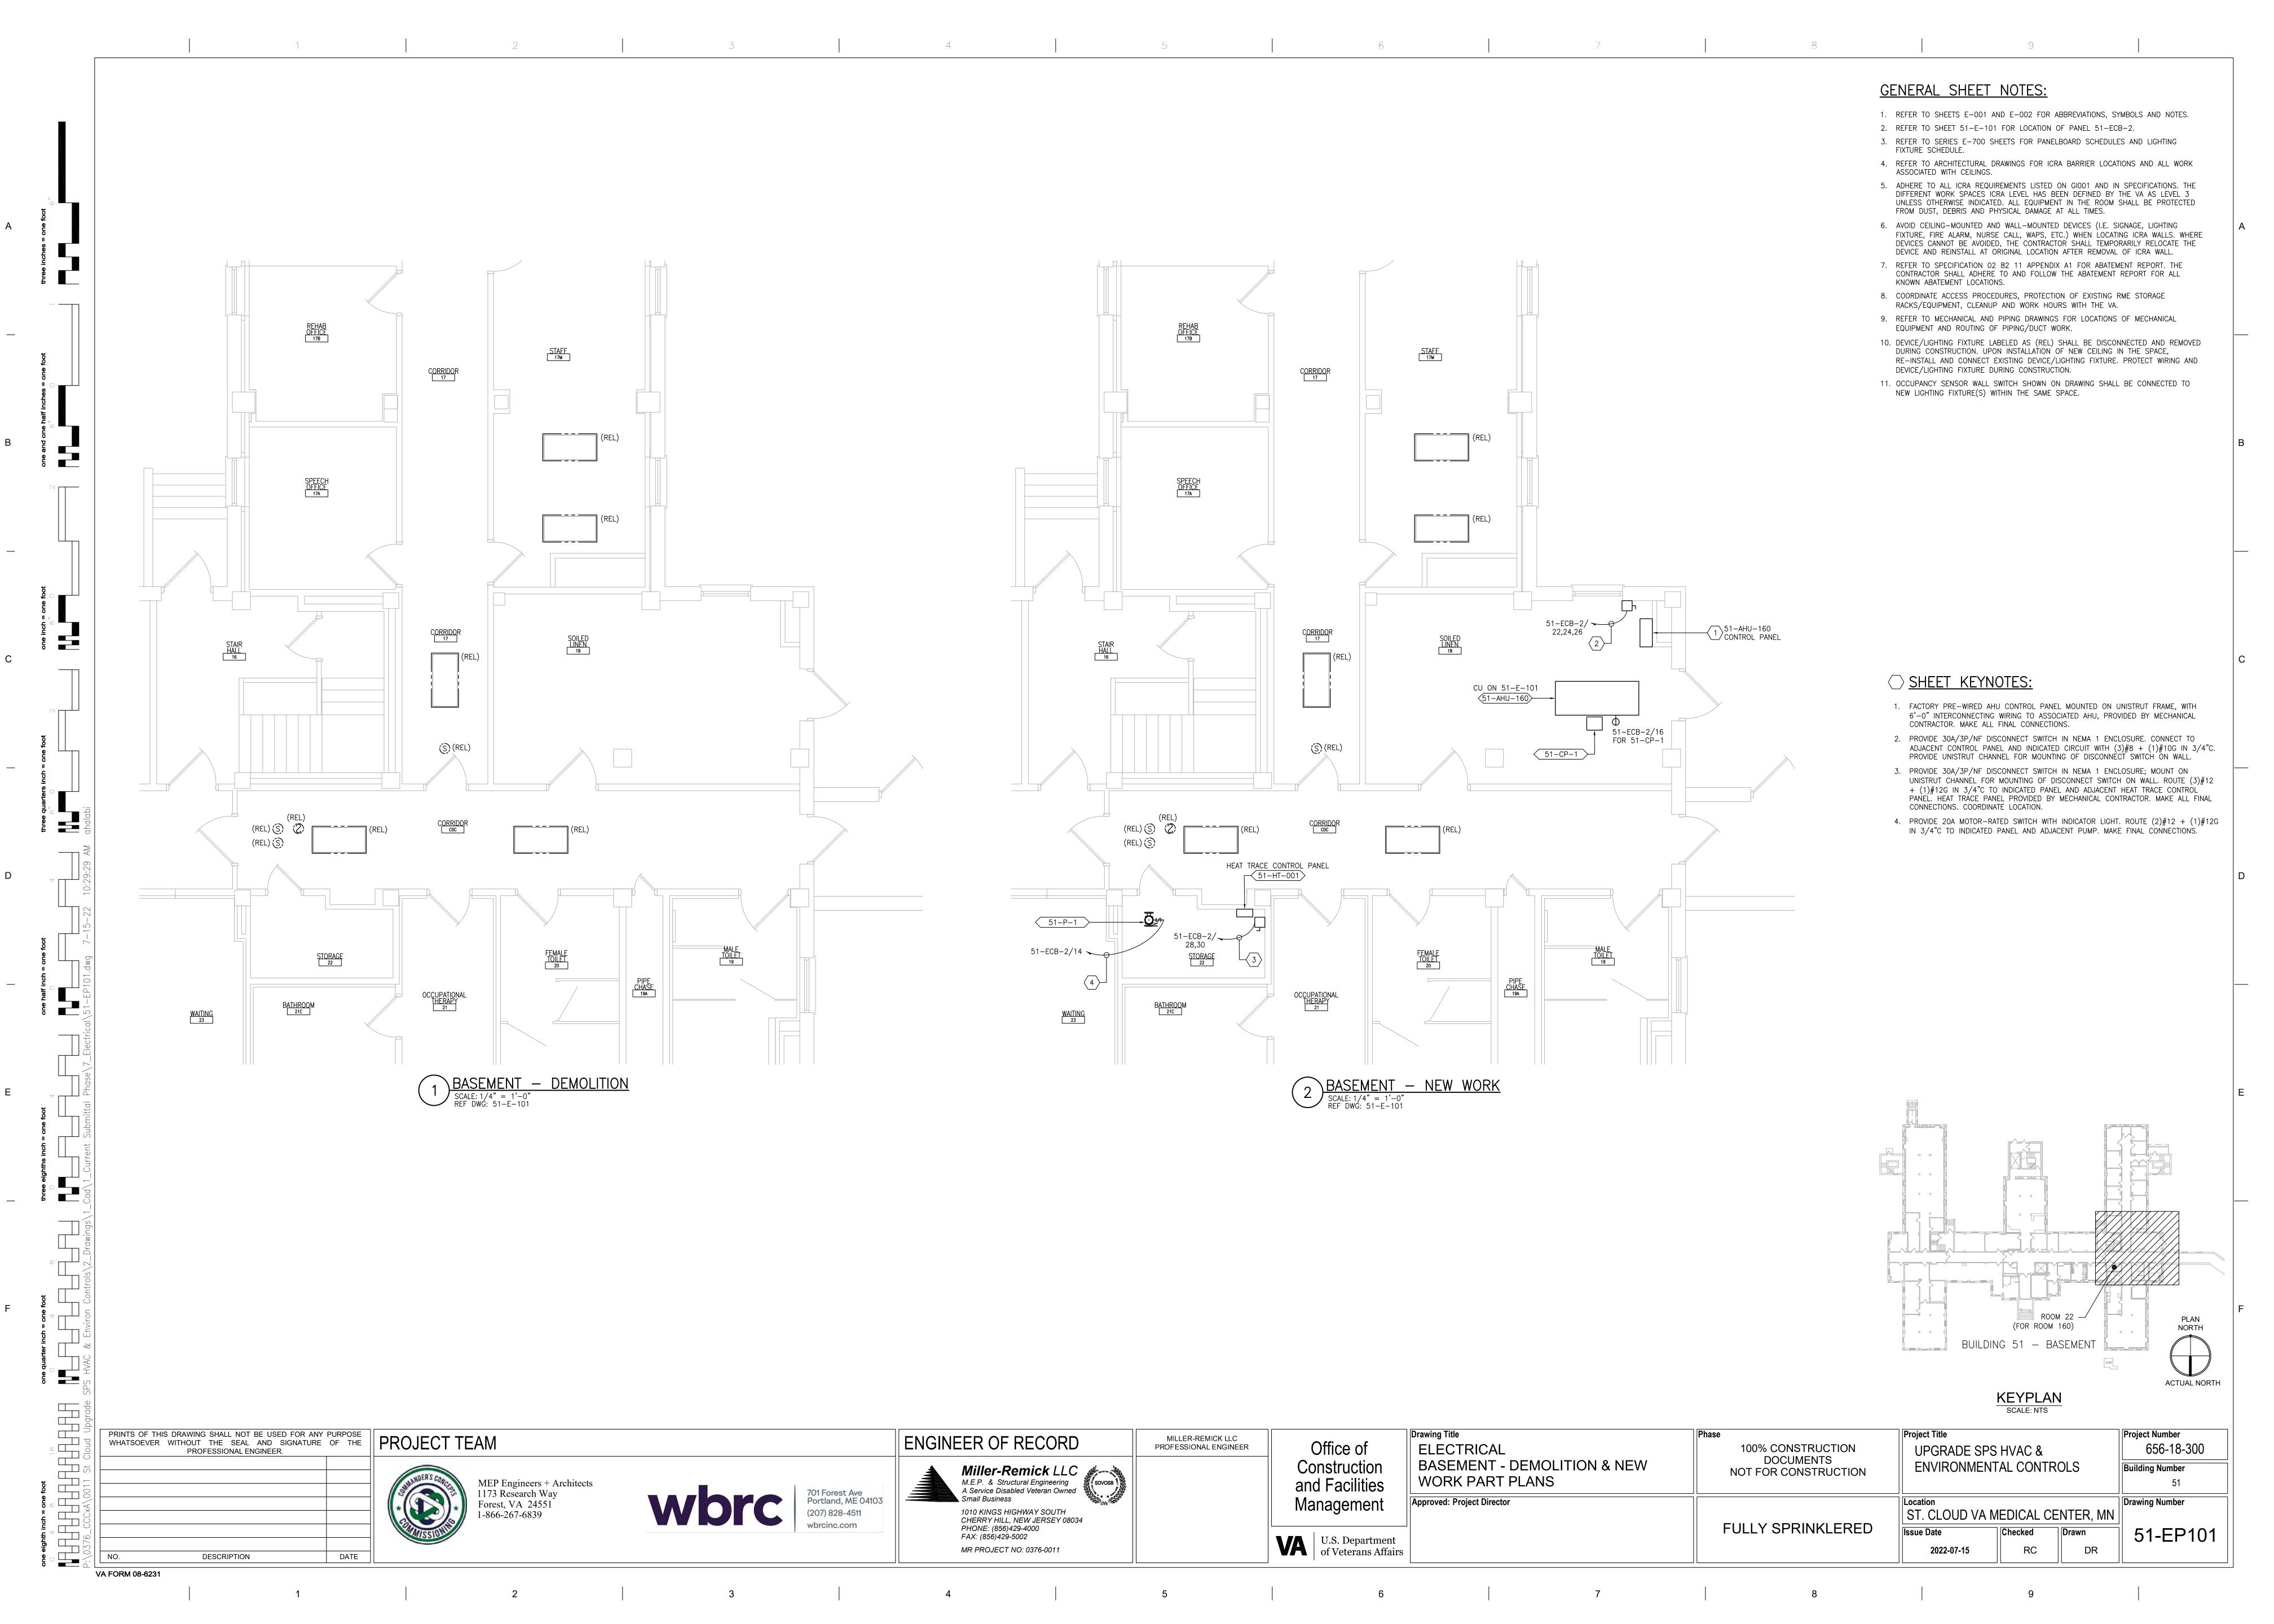

- REFER TO SHEETS E-001 AND E-002 FOR ABBREVIATIONS, SYMBOLS AND NOTES.
   REFER TO SHEET 51-E-111 FOR LOCATION OF PANELBOARDS.
- 3. REFER TO SERIES E-700 SHEETS FOR PANELBOARD SCHEDULES AND LIGHTING
- FIXTURE SCHEDULE.
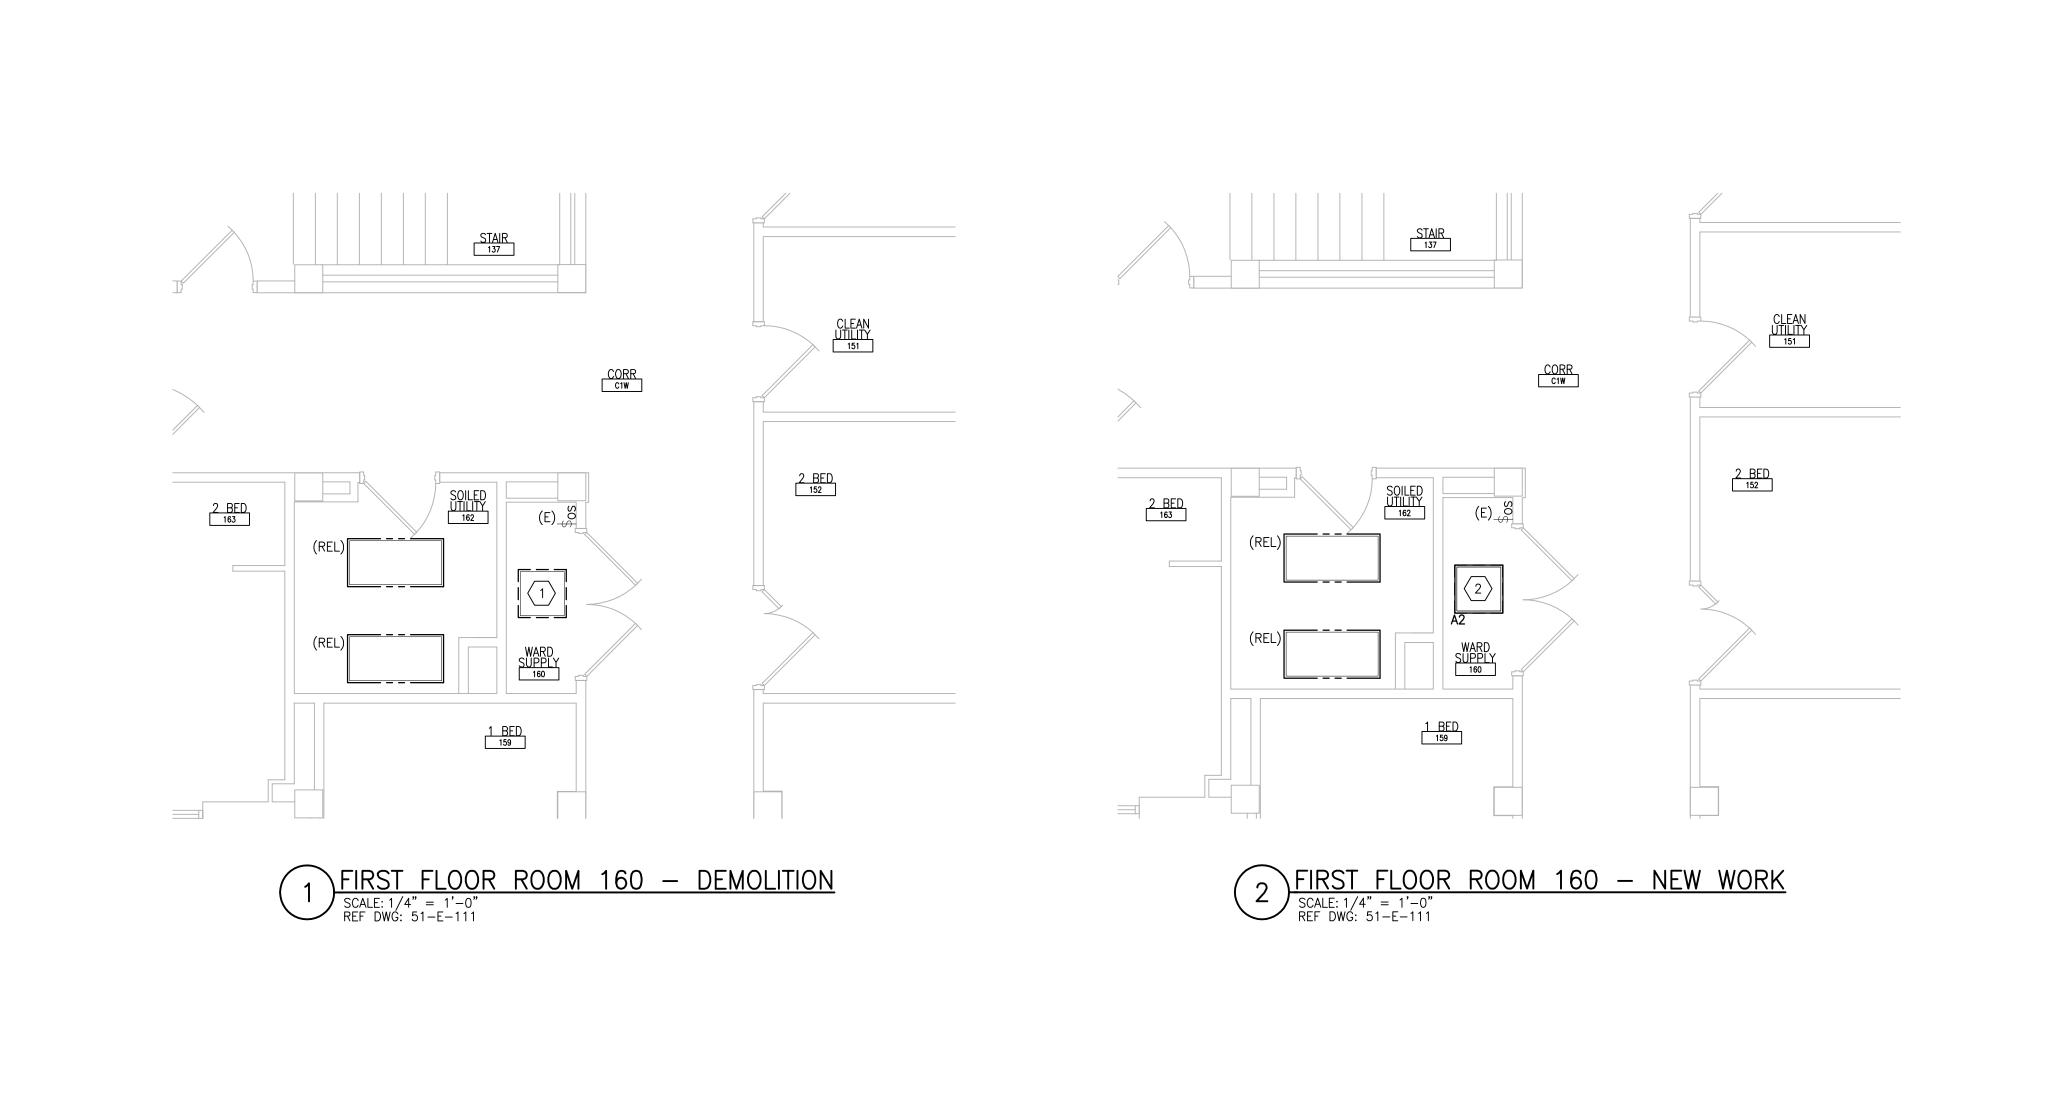
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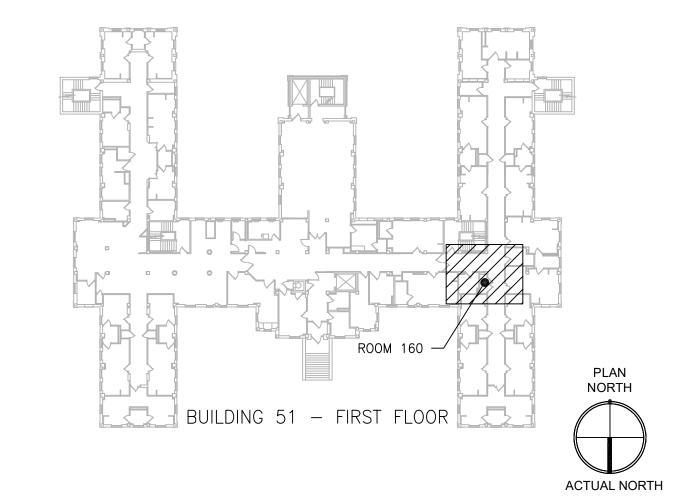
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- 11. OCCUPANCY SENSOR WALL SWITCH SHOWN ON DRAWING SHALL BE CONNECTED TO NEW LIGHTING FIXTURE(S) WITHIN THE SAME SPACE.

# 

- DISCONNECT AND REMOVE EXISTING LIGHTING FIXTURE(S). PROTECT BRANCH CIRCUIT DURING CONSTRUCTION.
- 2. PROVIDE NEW LIGHTING FIXTURE AND CONNECT TO EXISTING BRANCH CIRCUIT PREVIOUSLY FEEDING DEMOLISHED LIGHTING FIXTURE. CONNECT TO EXISTING ROOM LIGHTING CONTROL DEVICE. PROVIDE ADDITIONAL CONDUIT AND WIRING AS NEEDED.




KEYPLAN SCALE: NTS

PRINTS OF THIS DRAWING SHALL NOT BE USED FOR ANY PURPOSE WHATSOEVER WITHOUT THE SEAL AND SIGNATURE OF THE PROFESSIONAL ENGINEER. Project Title Drawing Title Project Number ENGINEER OF RECORD MILLER-REMICK LLC PROFESSIONAL ENGINEER Office of ELECTRICAL UPGRADE SPS HVAC & 100% CONSTRUCTION 656-18-300 DOCUMENTS NOT FOR CONSTRUCTION FIRST FLOOR - DEMOLITION & NEW Miller-Remick LLC


M.E.P. & Structural Engineering
A Service Disabled Veteran Owned
Small Business Construction **ENVIRONMENTAL CONTROLS Building Number** WORK PART PLANS and Facilities MEP Engineers + Architects 1173 Research Way 701 Forest Ave Portland, ME 04103 Approved: Project Director Management Drawing Number Forest, VA 24551 1-866-267-6839 (207) 828-4511 1010 KINGS HIGHWAY SOUTH CHERRY HILL, NEW JERSEY 08034 ST. CLOUD VA MEDICAL CENTER, MN **FULLY SPRINKLERED** PHONE: (856)429-4000 Checked 51-EP111 Drawn FAX: (856)429-5002 U.S. Department of Veterans Affairs MR PROJECT NO: 0376-0011 RC DR 2022-07-15 DESCRIPTION DATE VA FORM 08-6231

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VA FORM 08-6231

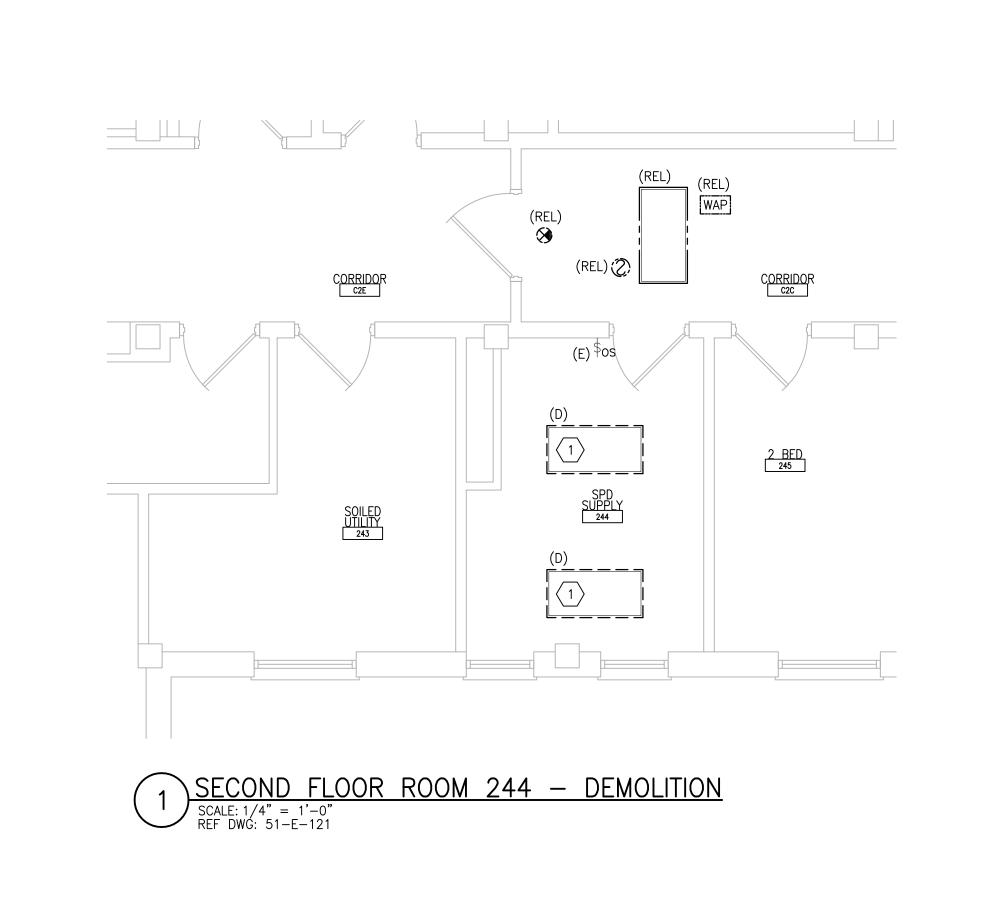

#### **GENERAL SHEET NOTES:**

ASSOCIATED WITH CEILINGS.

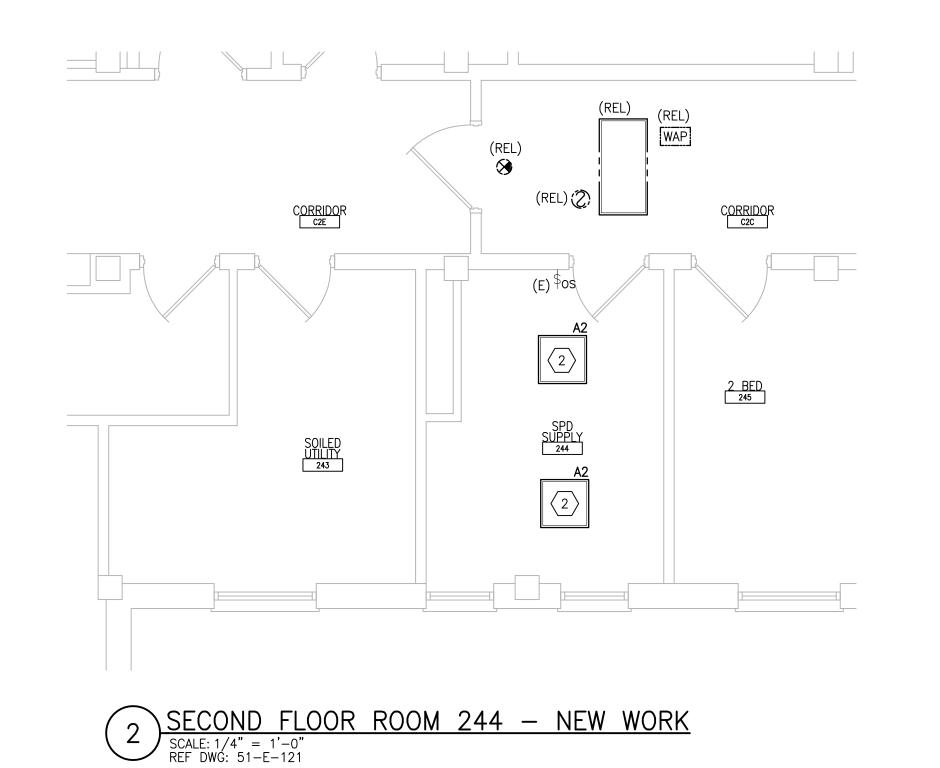
KNOWN ABATEMENT LOCATIONS.

- 1. REFER TO SHEETS E-001 AND E-002 FOR ABBREVIATIONS, SYMBOLS AND NOTES.
- 2. REFER TO SERIES E-700 SHEETS FOR PANELBOARD SCHEDULES AND LIGHTING
- FIXTURE SCHEDULE.

  3. REFER TO ARCHITECTURAL DRAWINGS FOR ICRA BARRIER LOCATIONS AND ALL WORK
- 4. ADHERE TO ALL ICRA REQUIREMENTS LISTED ON GIOO1 AND IN SPECIFICATIONS. THE DIFFERENT WORK SPACES ICRA LEVEL HAS BEEN DEFINED BY THE VA AS LEVEL 3 UNLESS OTHERWISE INDICATED. ALL EQUIPMENT IN THE ROOM SHALL BE PROTECTED FROM DUST, DEBRIS AND PHYSICAL DAMAGE AT ALL TIMES.
- 5. AVOID CEILING-MOUNTED AND WALL-MOUNTED DEVICES (I.E. SIGNAGE, LIGHTING FIXTURE, FIRE ALARM, NURSE CALL, WAPS, ETC.) WHEN LOCATING ICRA WALLS. WHERE DEVICES CANNOT BE AVOIDED, THE CONTRACTOR SHALL TEMPORARILY RELOCATE THE DEVICE AND REINSTALL AT ORIGINAL LOCATION AFTER REMOVAL OF ICRA WALL.
- 6. REFER TO SPECIFICATION 02 82 11 APPENDIX A1 FOR ABATEMENT REPORT. THE CONTRACTOR SHALL ADHERE TO AND FOLLOW THE ABATEMENT REPORT FOR ALL
- 7. COORDINATE ACCESS PROCEDURES, PROTECTION OF EXISTING RME STORAGE RACKS/EQUIPMENT, CLEANUP AND WORK HOURS WITH THE VA.
- 8. REFER TO MECHANICAL AND PIPING DRAWINGS FOR LOCATIONS OF MECHANICAL EQUIPMENT AND ROUTING OF PIPING/DUCT WORK.
- 9. DEVICE/LIGHTING FIXTURE LABELED AS (REL) SHALL BE DISCONNECTED AND REMOVED DURING CONSTRUCTION. UPON INSTALLATION OF NEW CEILING IN THE SPACE, RE—INSTALL AND CONNECT EXISTING DEVICE/LIGHTING FIXTURE. PROTECT WIRING AND DEVICE/LIGHTING FIXTURE DURING CONSTRUCTION.
- 10. OCCUPANCY SENSOR WALL SWITCH SHOWN ON DRAWING SHALL BE CONNECTED TO NEW LIGHTING FIXTURE(S) WITHIN THE SAME SPACE.

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- 1. DISCONNECT AND REMOVE EXISTING LIGHTING FIXTURE(S) AND/OR LIGHTING CONTROL DEVICE. PROTECT BRANCH CIRCUIT DURING CONSTRUCTION.
- PROVIDE NEW LIGHTING FIXTURE AND CONNECT TO EXISTING BRANCH CIRCUIT PREVIOUSLY FEEDING DEMOLISHED LIGHTING FIXTURE. CONNECT TO NEW LIGHTING CONTROL DEVICE. PROVIDE ADDITIONAL CONDUIT AND WIRING AS NEEDED.

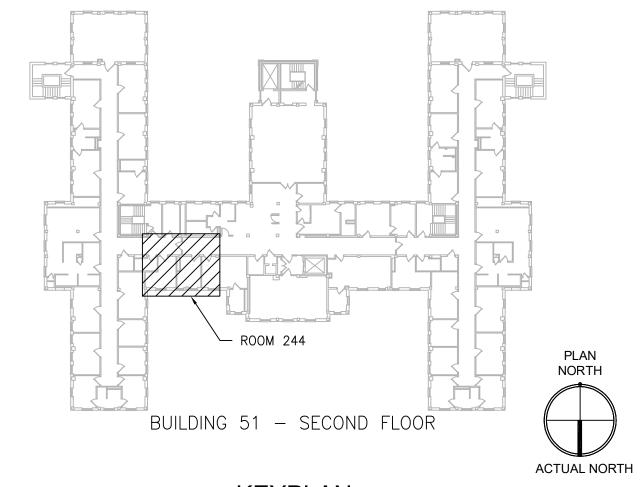


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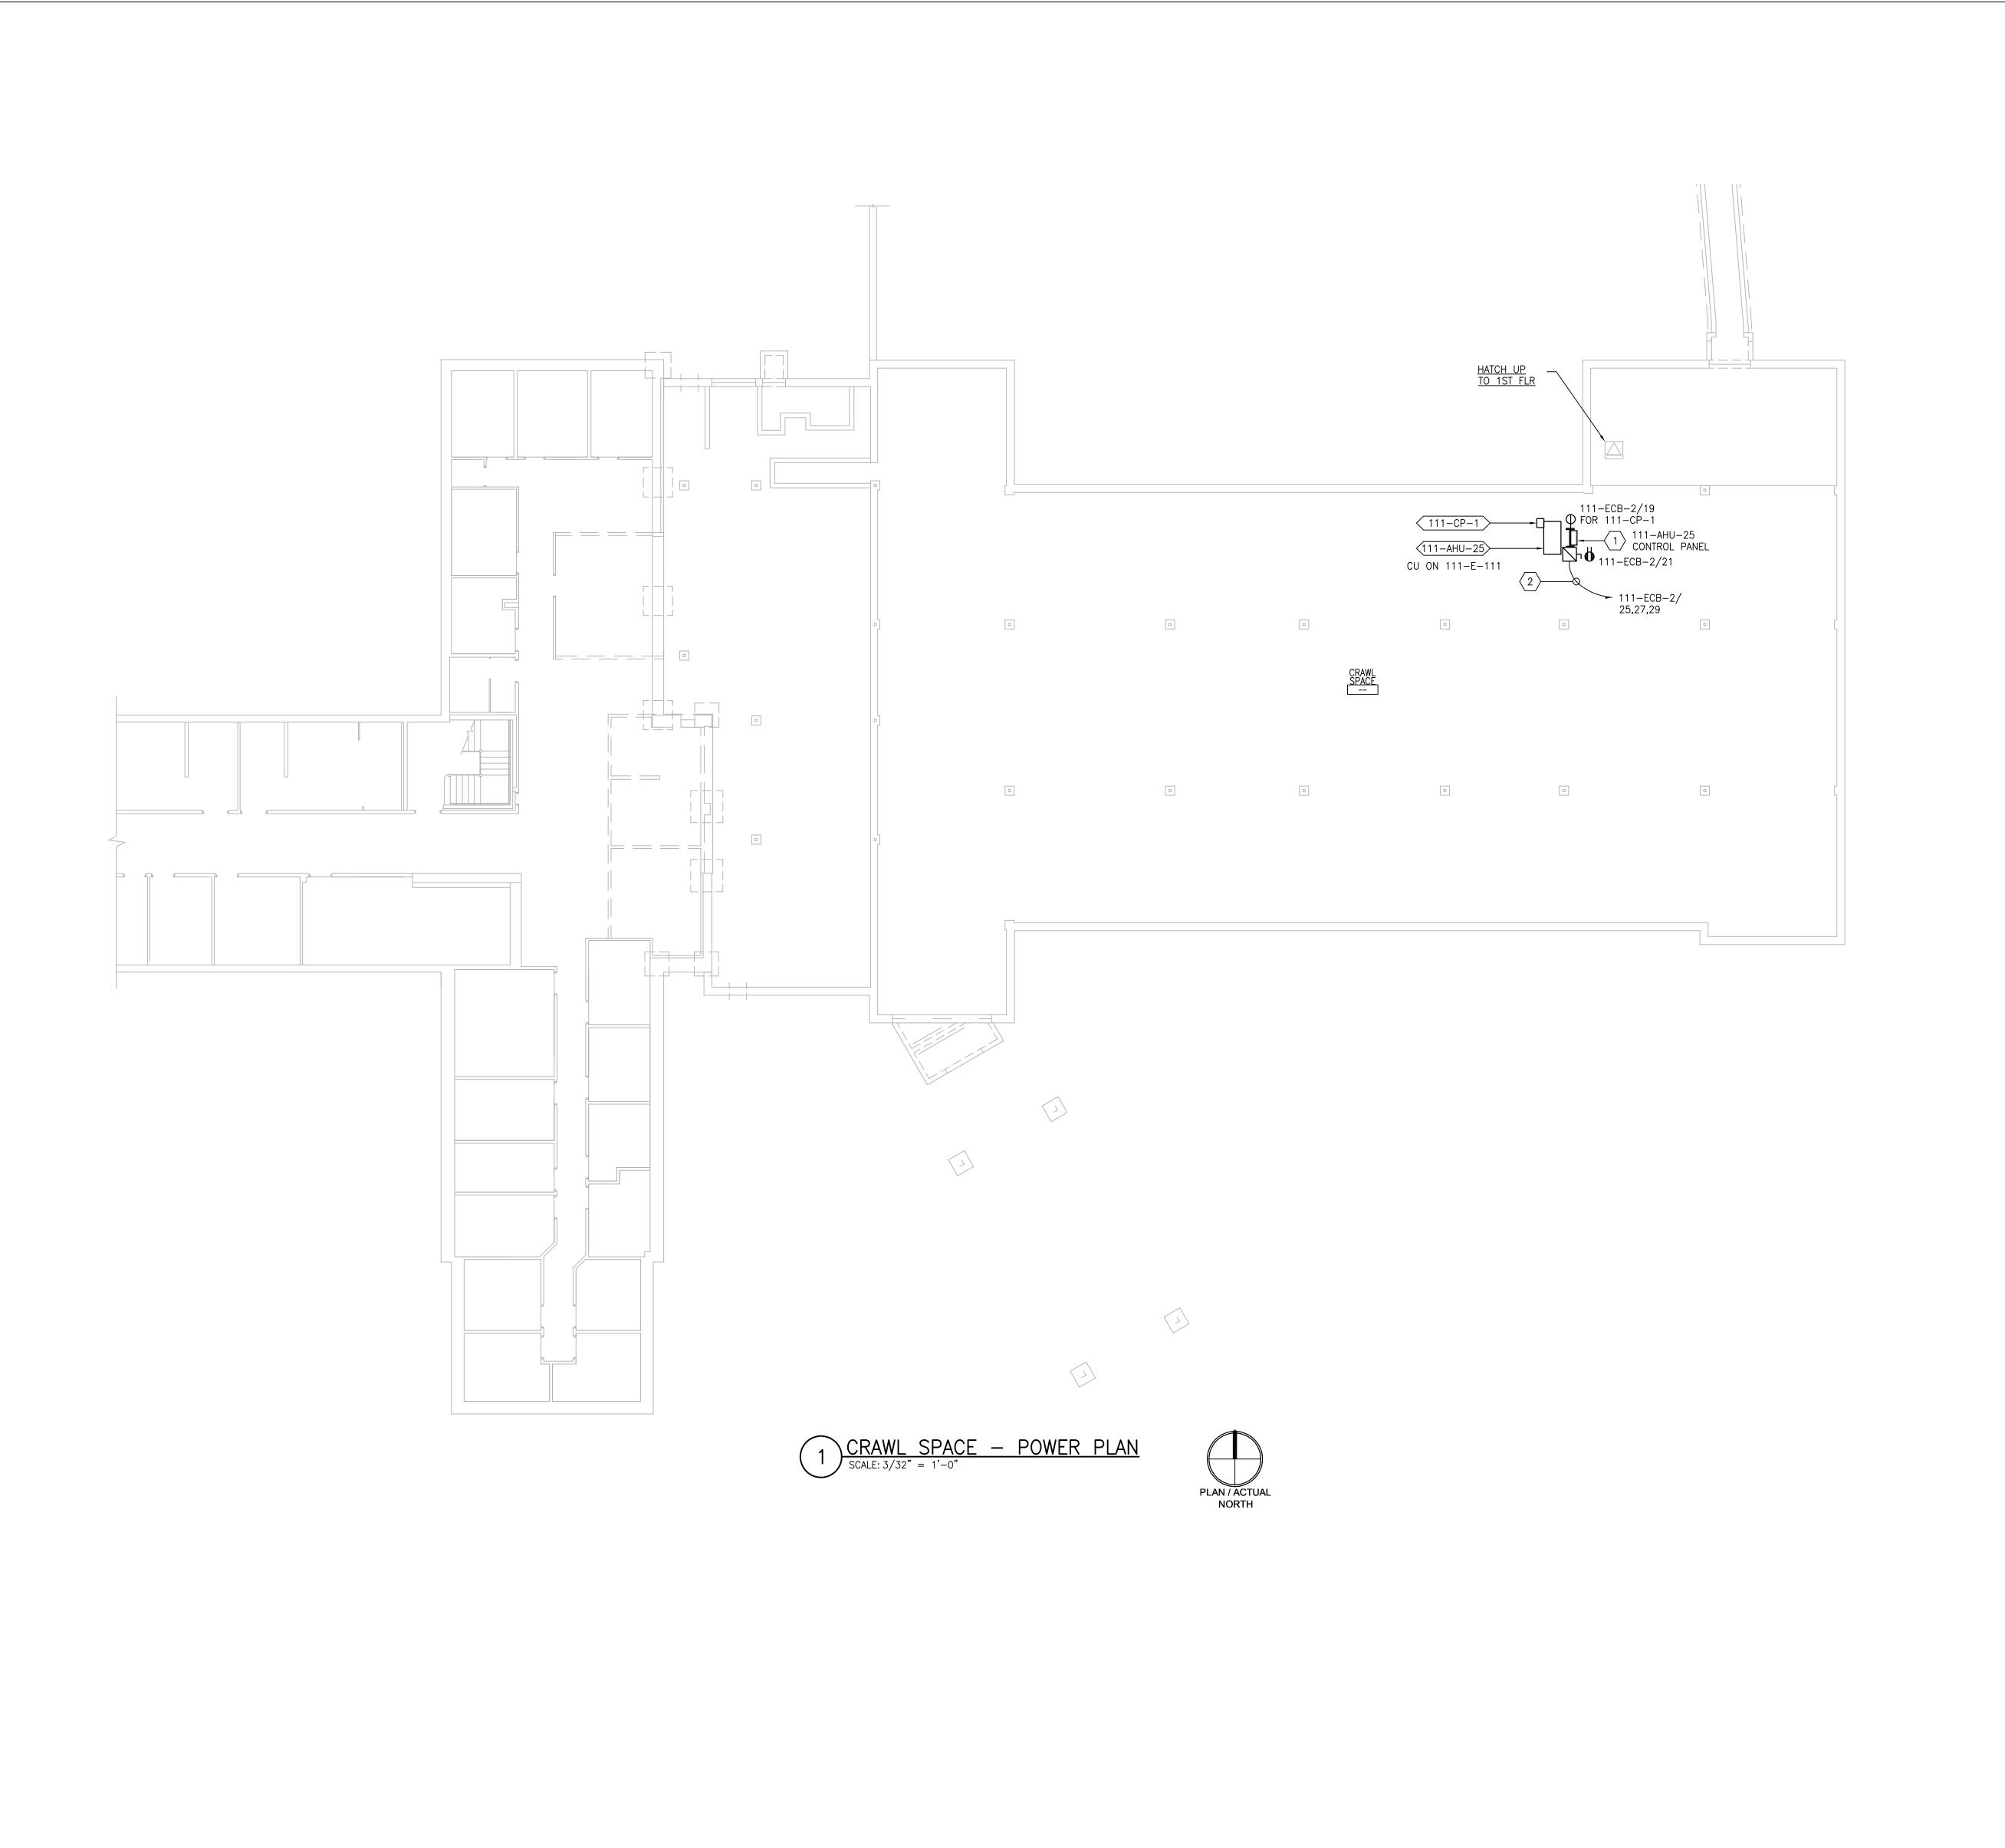
PRINTS OF THIS DRAWING SHALL NOT BE USED FOR ANY PURPOSE WHATSOEVER WITHOUT THE SEAL AND SIGNATURE OF THE PROFESSIONAL ENGINEER. Project Number Drawing Title Project Title MILLER-REMICK LLC PROFESSIONAL ENGINEER ENGINEER OF RECORD Office of 656-18-300 **ELECTRICAL** 100% CONSTRUCTION **UPGRADE SPS HVAC &** DOCUMENTS NOT FOR CONSTRUCTION SECOND FLOOR - DEMOLITION & NEW Miller-Remick LLC

M.E.P. & Structural Engineering

A Service Disabled Veteran Owned

Small Business **ENVIRONMENTAL CONTROLS** Construction **Building Number WORK PART PLANS** and Facilities MEP Engineers + Architects 1173 Research Way 701 Forest Ave Portland, ME 04103 Approved: Project Director Management Drawing Number Forest, VA 24551 1-866-267-6839 (207) 828-4511 1010 KINGS HIGHWAY SOUTH CHERRY HILL, NEW JERSEY 08034 ST. CLOUD VA MEDICAL CENTER, MN **FULLY SPRINKLERED** PHONE: (856)429-4000 Checked 51-EP121 Drawn U.S. Department of Veterans Affairs FAX: (856)429-5002 DR MR PROJECT NO: 0376-0011 2022-07-15 RC DESCRIPTION DATE



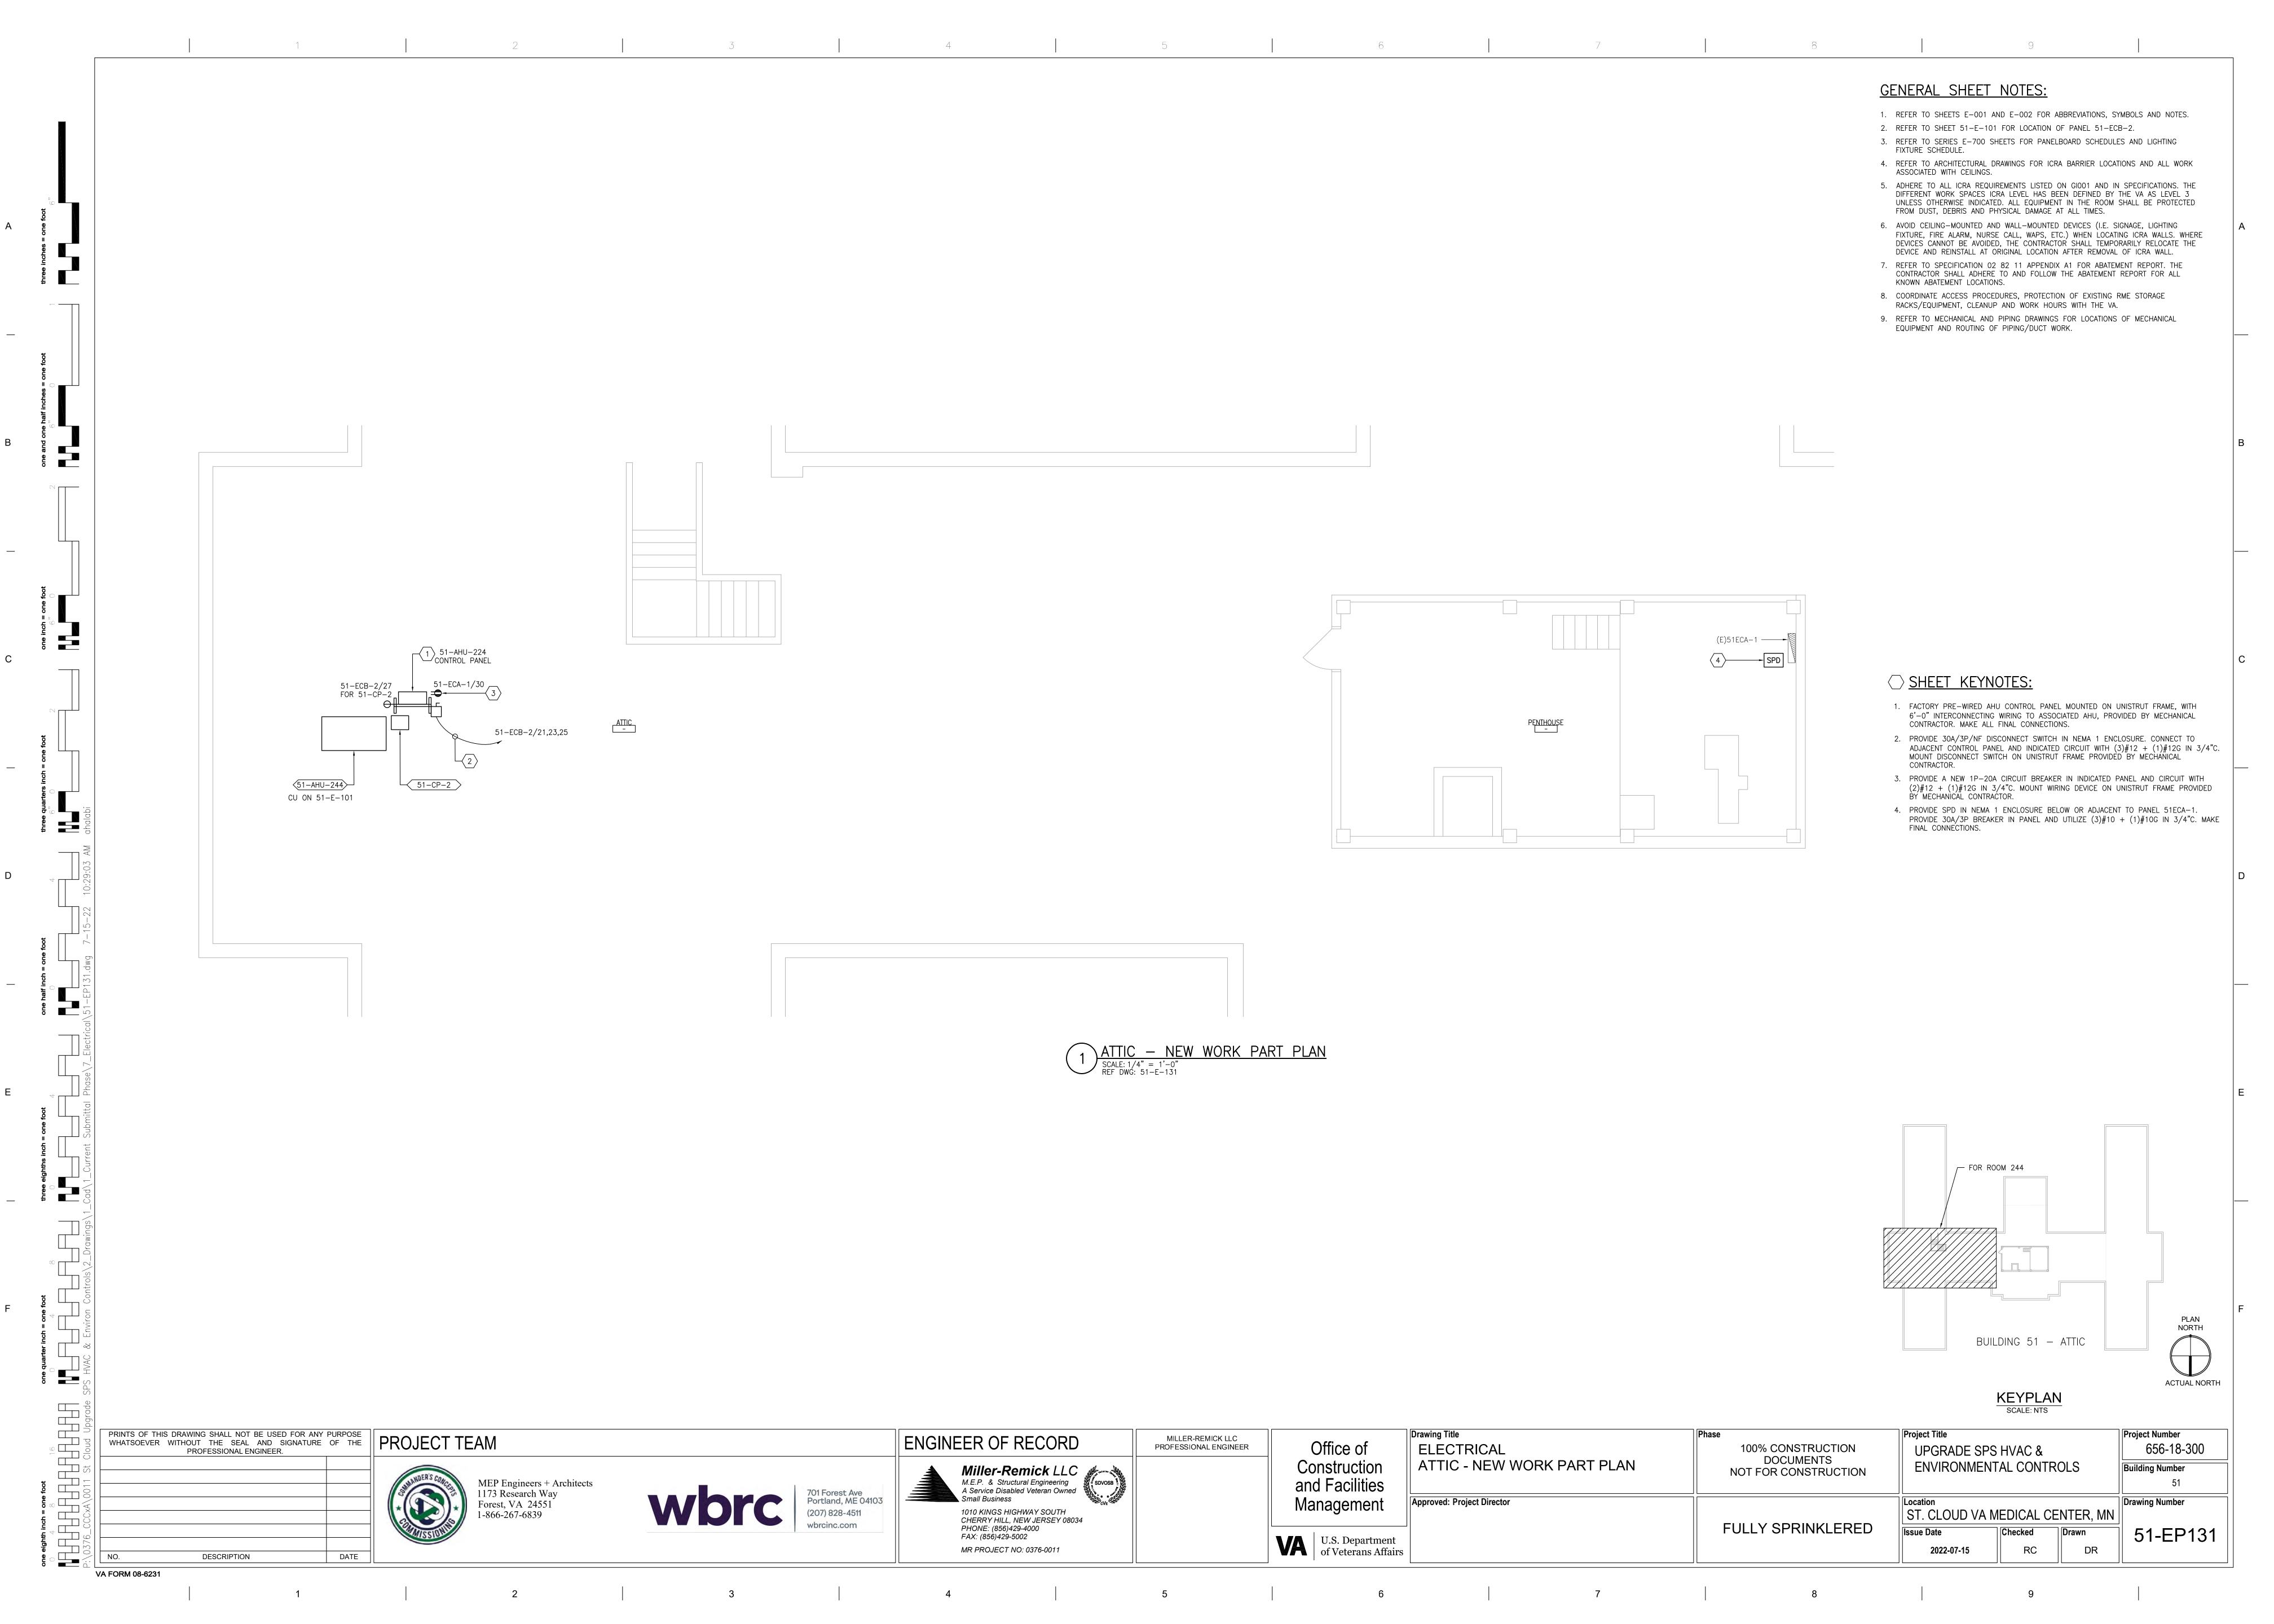

MILLER-REMICK LLC PROFESSIONAL ENGINEER

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Office of

Construction

and Facilities

Management

U.S. Department of Veterans Affairs

ENGINEER OF RECORD

FAX: (856)429-5002

MR PROJECT NO: 0376-0011

701 Forest Ave Portland, ME 04103

(207) 828-4511

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Miller-Remick LLC

M.E.P. & Structural Engineering

A Service Disabled Veteran Owned

Small Business

1010 KINGS HIGHWAY SOUTH CHERRY HILL, NEW JERSEY 08034 PHONE: (856)429-4000

VA FORM 08-6231

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DESCRIPTION

DATE

MEP Engineers + Architects 1173 Research Way Forest, VA 24551 1-866-267-6839

### **GENERAL SHEET NOTES:**

KNOWN ABATEMENT LOCATIONS.

- 1. REFER TO SHEETS E-001 AND E-002 FOR ABBREVIATIONS, SYMBOLS AND NOTES.
- REFER TO SHEET 111-E-111 FOR LOCATION OF PANEL 111-ECB-2.
   REFER TO SERIES E-700 SHEETS FOR PANELBOARD SCHEDULES AND LIGHTING
- FIXTURE SCHEDULE.

  4. REFER TO ARCHITECTURAL DRAWINGS FOR ICRA BARRIER LOCATIONS AND ALL WORK
- ASSOCIATED WITH CEILINGS.


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- FROM DUST, DEBRIS AND PHYSICAL DAMAGE AT ALL TIMES.

  6. REFER TO SPECIFICATION 02 82 11 APPENDIX A1 FOR ABATEMENT REPORT. THE CONTRACTOR SHALL ADHERE TO AND FOLLOW THE ABATEMENT REPORT FOR ALL
- 7. COORDINATE ACCESS PROCEDURES, PROTECTION OF EXISTING RME STORAGE RACKS/EQUIPMENT, CLEANUP AND WORK HOURS WITH THE VA.
- 8. REFER TO MECHANICAL AND PIPING DRAWINGS FOR LOCATIONS OF MECHANICAL EQUIPMENT AND ROUTING OF PIPING/DUCT WORK.

#### 

- FACTORY PRE-WIRED AHU CONTROL PANEL MOUNTED ON UNISTRUT FRAME, WITH 6'-0" INTERCONNECTING WIRING TO ASSOCIATED AHU, PROVIDED BY MECHANICAL CONTRACTOR. MAKE ALL FINAL CONNECTIONS.
- PROVIDE 30A/3P/15AF FUSED DISCONNECT SWITCH IN NEMA 1 ENCLOSURE. CONNECT TO ADJACENT CONTROL PANEL AND INDICATED CIRCUIT WITH (3)#12 + (1)#12G IN 3/4"C. MOUNT DISCONNECT SWITCH ON UNISTRUT FRAME PROVIDED BY MECHANICAL CONTRACTOR.

Project Title Project Number Drawing Title 656-18-300 **ELECTRICAL** 100% CONSTRUCTION **UPGRADE SPS HVAC &** DOCUMENTS NOT FOR CONSTRUCTION CRAWL SPACE - POWER PLAN **ENVIRONMENTAL CONTROLS Building Number** Approved: Project Director Drawing Number ST. CLOUD VA MEDICAL CENTER, MN **FULLY SPRINKLERED** Checked 111-E-101 RC DR 2022-07-15

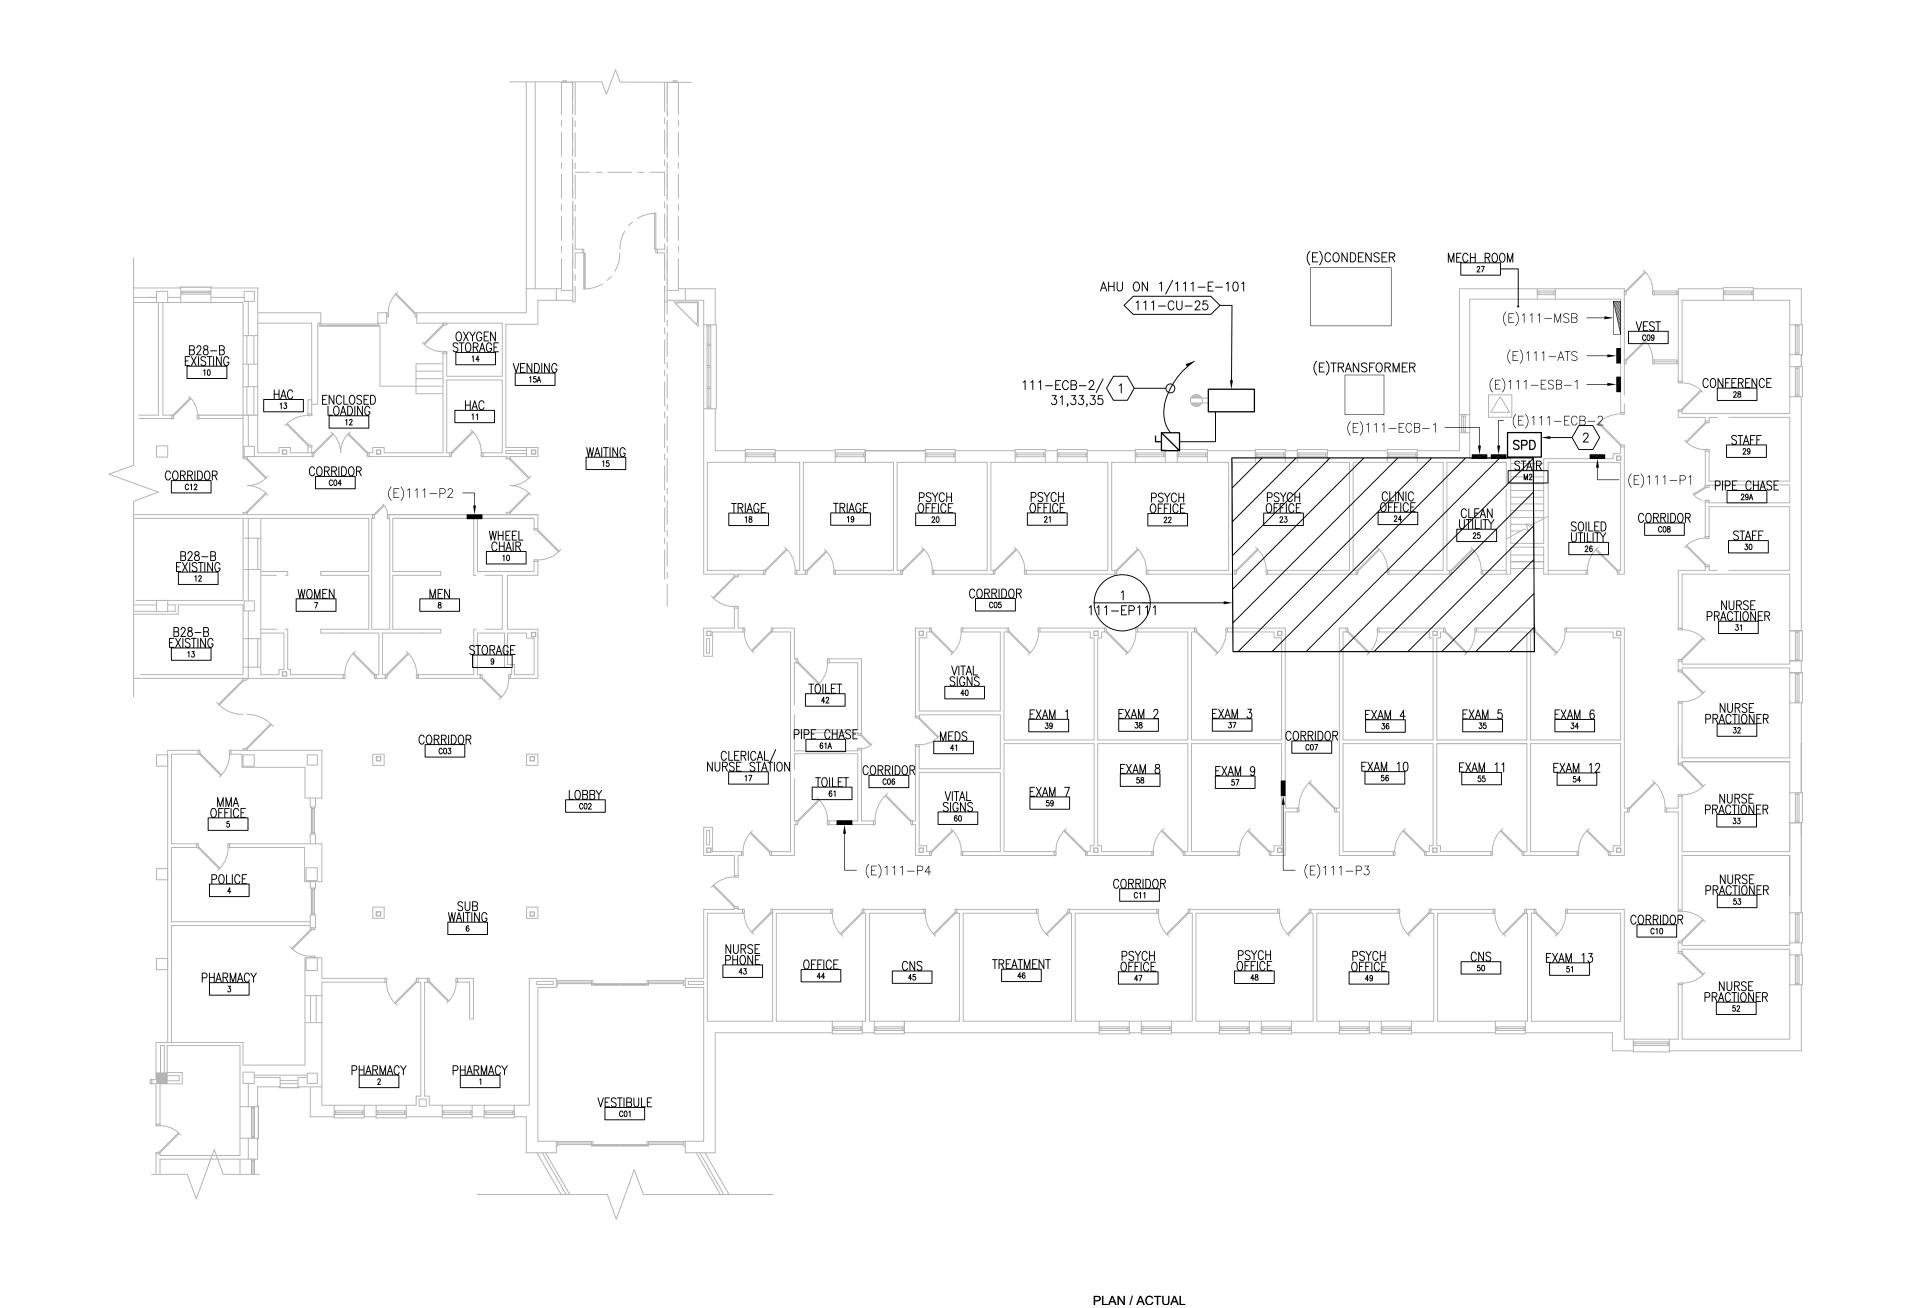

- 1. REFER TO SHEETS E-001 AND E-002 FOR ABBREVIATIONS, SYMBOLS AND NOTES.
- 2. REFER TO SHEET 1-E-101 FOR LOCATION OF PANEL 1-EQB-SPS (BASEMENT ELECTRICAL ROOM 18).
- 3. REFER TO SERIES E-700 SHEETS FOR PANELBOARD SCHEDULES AND LIGHTING FIXTURE SCHEDULE.
- 4. REFER TO ARCHITECTURAL DRAWINGS FOR ICRA BARRIER LOCATIONS AND ALL WORK ASSOCIATED WITH CEILINGS.
- 5. ADHERE TO ALL ICRA REQUIREMENTS LISTED ON GIOO1 AND IN SPECIFICATIONS. THE DIFFERENT WORK SPACES ICRA LEVEL HAS BEEN DEFINED BY THE VA AS LEVEL 3 UNLESS OTHERWISE INDICATED. ALL EQUIPMENT IN THE ROOM SHALL BE PROTECTED

FROM DUST, DEBRIS AND PHYSICAL DAMAGE AT ALL TIMES.

- 6. AVOID CEILING—MOUNTED AND WALL—MOUNTED DEVICES (I.E. SIGNAGE, LIGHTING FIXTURE, FIRE ALARM, NURSE CALL, WAPS, ETC.) WHEN LOCATING ICRA WALLS. WHERE DEVICES CANNOT BE AVOIDED, THE CONTRACTOR SHALL TEMPORARILY RELOCATE THE
- DEVICE AND REINSTALL AT ORIGINAL LOCATION AFTER REMOVAL OF ICRA WALL.

  7. REFER TO SPECIFICATION 02 82 11 APPENDIX A1 FOR ABATEMENT REPORT. THE CONTRACTOR SHALL ADHERE TO AND FOLLOW THE ABATEMENT REPORT FOR ALL KNOWN ABATEMENT LOCATIONS.
- 8. COORDINATE ACCESS PROCEDURES, PROTECTION OF EXISTING RME STORAGE RACKS/EQUIPMENT, CLEANUP AND WORK HOURS WITH THE VA.
- 9. REFER TO MECHANICAL AND PIPING DRAWINGS FOR LOCATIONS OF MECHANICAL
- 9. REFER TO MECHANICAL AND PIPING DRAWINGS FOR LOCATIONS OF MECHAN EQUIPMENT AND ROUTING OF PIPING/DUCT WORK.
- 10. <u>CONDENSING UNITS AND PACKAGED AHU'S:</u> UNITS ARE PROVIDED WITH A FACTORY WIRED 120V RECEPTACLE SHOWN IN GRAY—SCALE (FOR REFERENCE ONLY).

#### 

- PROVIDE 30A/3P/25AF FUSED DISCONNECT SWITCH IN NEMA 3R ENCLOSURE.
   CONNECT TO ADJACENT CU AND INDICATED CIRCUIT WITH (3)#10, (1)#10G IN 3/4"C.
   PROVIDE GALVANIZED STEEL FRAME WITH GALVANIZED HARDWARE FOR MOUNTING OF DISCONNECT SWITCH ON WALL.
- 2. PROVIDE SPD IN NEMA 1 ENCLOSURE BELOW OR ADJACENT TO ASSOCIATED PANEL. MAKE FINAL CONNECTIONS. REFER TO SHEET E-702.

PRINTS OF THIS DRAWING SHALL NOT BE USED FOR ANY PURPOSE WHATSOEVER WITHOUT THE SEAL AND SIGNATURE OF THE PROFESSIONAL ENGINEER. Project Title Drawing Title Project Number ENGINEER OF RECORD MILLER-REMICK LLC Office of 656-18-300 **ELECTRICAL** 100% CONSTRUCTION PROFESSIONAL ENGINEER UPGRADE SPS HVAC & DOCUMENTS NOT FOR CONSTRUCTION FIRST FLOOR - POWER PLAN Miller-Remick LLC


M.E.P. & Structural Engineering


A Service Disabled Veteran Owned

Small Business Construction **ENVIRONMENTAL CONTROLS Building Number** and Facilities MEP Engineers + Architects 1173 Research Way 701 Forest Ave Portland, ME 04103 Approved: Project Director Management Drawing Number Forest, VA 24551 1-866-267-6839 (207) 828-4511 1010 KINGS HIGHWAY SOUTH CHERRY HILL, NEW JERSEY 08034 ST. CLOUD VA MEDICAL CENTER, MN **FULLY SPRINKLERED** PHONE: (856)429-4000 Checked 111-E-111 Drawn U.S. Department of Veterans Affairs FAX: (856)429-5002 MR PROJECT NO: 0376-0011 RC DR 2022-07-15 DESCRIPTION DATE

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- 1. REFER TO SHEETS E-001 AND E-002 FOR ABBREVIATIONS, SYMBOLS AND NOTES.
- 2. REFER TO SHEET 1-E-111 FOR LOCATION OF PANELBOARDS.
- REFER TO ARCHITECTURAL DRAWINGS FOR ICRA BARRIER LOCATIONS AND ALL WORK ASSOCIATED WITH CEILINGS.
- 4. ADHERE TO ALL ICRA REQUIREMENTS LISTED ON GIOO1 AND IN SPECIFICATIONS. THE DIFFERENT WORK SPACES ICRA LEVEL HAS BEEN DEFINED BY THE VA AS LEVEL 3 UNLESS OTHERWISE INDICATED. ALL EQUIPMENT IN THE ROOM SHALL BE PROTECTED FROM DUST, DEBRIS AND PHYSICAL DAMAGE AT ALL TIMES.
- 5. AVOID CEILING-MOUNTED AND WALL-MOUNTED DEVICES (I.E. SIGNAGE, LIGHTING FIXTURE, FIRE ALARM, NURSE CALL, WAPS, ETC.) WHEN LOCATING ICRA WALLS. WHERE DEVICES CANNOT BE AVOIDED, THE CONTRACTOR SHALL TEMPORARILY RELOCATE THE
- DEVICE AND REINSTALL AT ORIGINAL LOCATION AFTER REMOVAL OF ICRA WALL.

  6. REFER TO SPECIFICATION 02 82 11 APPENDIX A1 FOR ABATEMENT REPORT. THE CONTRACTOR SHALL ADHERE TO AND FOLLOW THE ABATEMENT REPORT FOR ALL
- KNOWN ABATEMENT LOCATIONS.

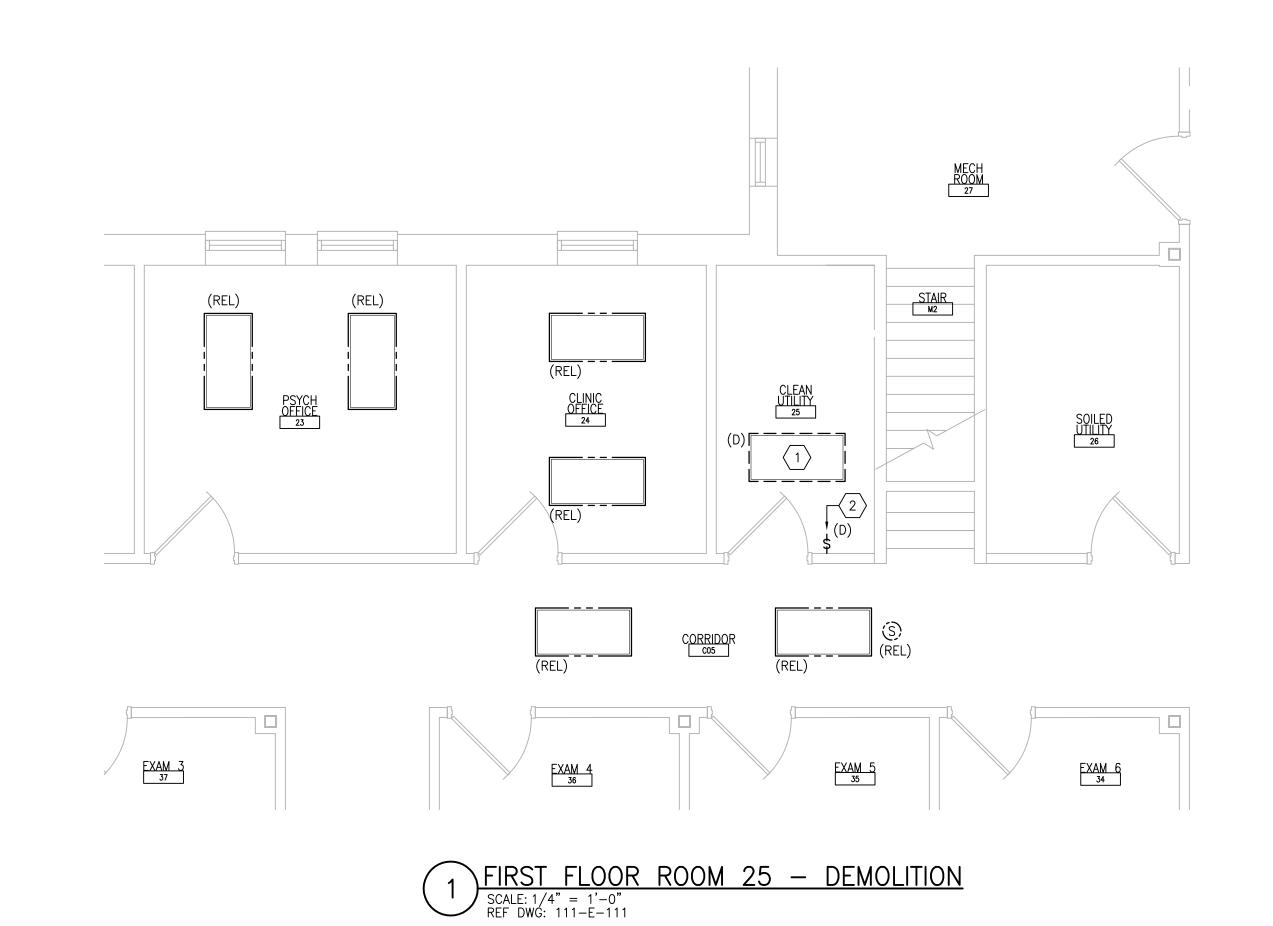
  7. COORDINATE ACCESS PROCEDURES, PROTECTION OF EXISTING RME STORAGE RACKS/EQUIPMENT, CLEANUP AND WORK HOURS WITH THE VA.
- 8. REFER TO MECHANICAL AND PIPING DRAWINGS FOR LOCATIONS OF MECHANICAL EQUIPMENT AND ROUTING OF PIPING/DUCT WORK.
- 9. DEVICE/LIGHTING FIXTURE LABELED AS (REL) SHALL BE DISCONNECTED AND REMOVED DURING CONSTRUCTION. UPON INSTALLATION OF NEW CEILING IN THE SPACE, RE—INSTALL AND CONNECT EXISTING DEVICE/LIGHTING FIXTURE. PROTECT WIRING AND
- 10. OCCUPANCY SENSOR WALL SWITCH SHOWN ON DRAWING SHALL BE CONNECTED TO NEW LIGHTING FIXTURE(S) WITHIN THE SAME SPACE.

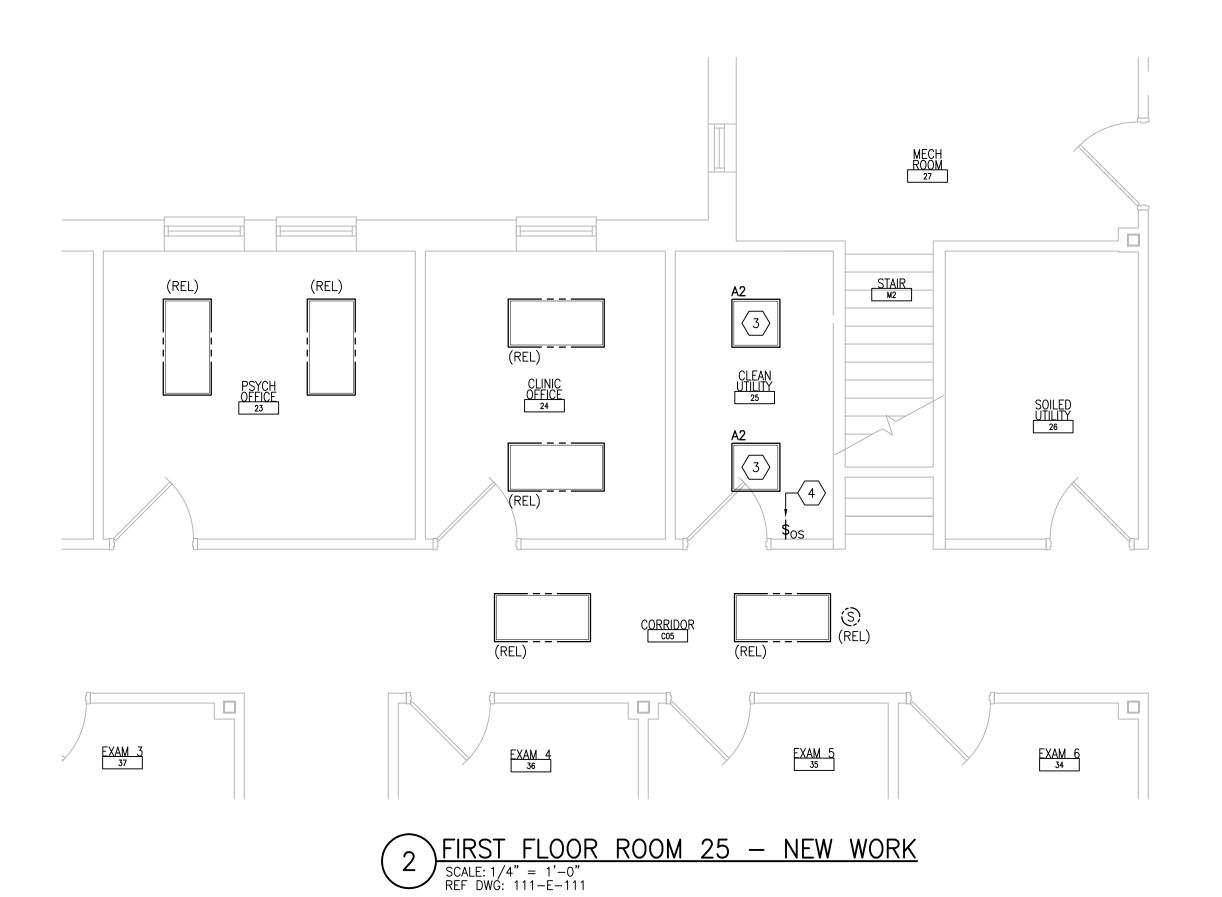DEVICE/LIGHTING FIXTURE DURING CONSTRUCTION.

11. EXISTING CONDITIONS: DURING THE FINAL SURVEY PERFORMED BY MILLER-REMICK (M-R), THE FIRST FLOOR HAD BEEN FLOODED AND THE BUILDING WAS UNDERGOING A MAJOR RENOVATION. THE EXISTING DEVICES AND LIGHTING FIXTURES SHOWN MAY NOT MATCH CONDITIONS WHEN CONSTRUCTION BEGINS. THE CONTRACTOR SHALL PROVIDE TO M-R EXISTING CONDITIONS AT THE START OF CONSTRUCTION FOR ADDITIONAL

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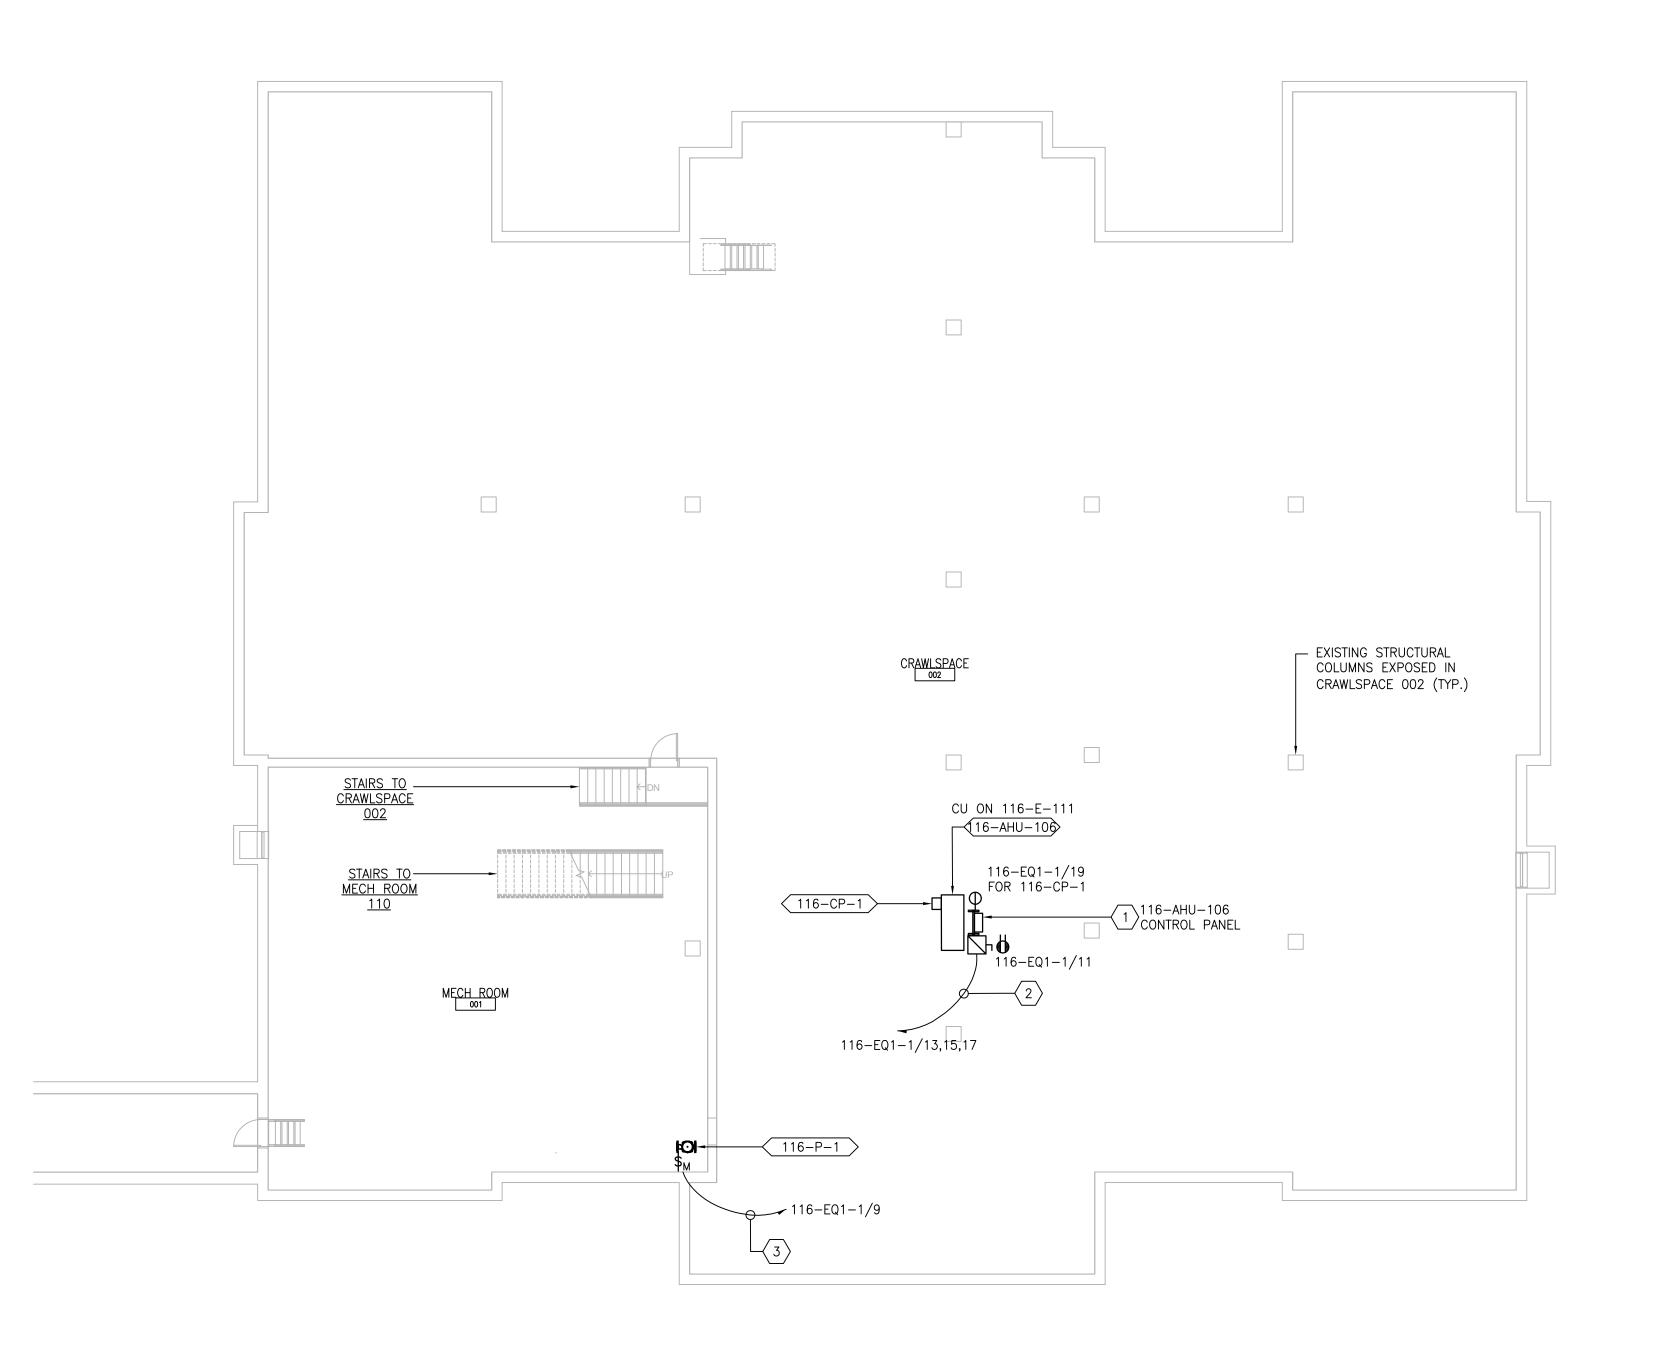
- DISCONNECT AND REMOVE EXISTING LIGHTING CIRCUIT. PROTECT BRANCH CIRCUIT DURING CONSTRUCTION.
- 2. DISCONNECT AND REMOVE EXISTING SWITCH. RETAIN BACK BOX AND ASSOCIATED CONDUIT AND WIRING.
- 3. PROVIDE NEW LIGHTING FIXTURE AND CONNECT TO EXISTING LIGHTING BRANCH CIRCUIT PREVIOUSLY FEEDING DEMOLISHED LIGHTING FIXTURE. CONNECT TO EXISTING ROOM LIGHTING CONTROLS. PROVIDE ADDITIONAL CONDUIT AND WIRING AS NEEDED.
- 4. PROVIDE NEW SWITCH INSTALLED IN EXISTING BACK BOX. CONNECT TO EXISTING LIGHTING BRANCH CIRCUIT.

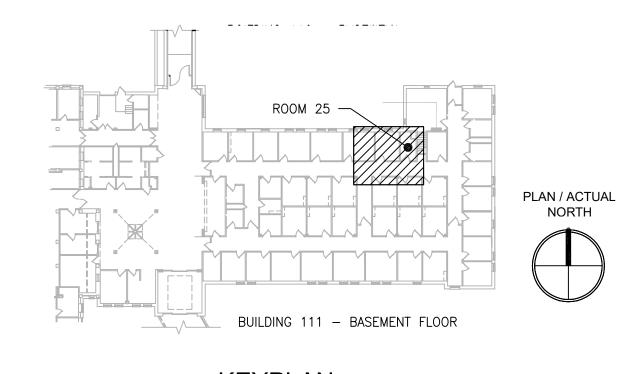

#### KEYPLAN SCALE: NTS

									3 37 122 1 1 1 1 2		
PRINTS OF THIS DRAWING SHALL NOT BE USED FOR ANY PURPOSE WHATSOEVER WITHOUT THE SEAL AND SIGNATURE OF THE PROFESSIONAL ENGINEER.	PROJECT TEAM		ENGINEER OF RECORD	MILLER-REMICK LLC PROFESSIONAL ENGINEER	Office of	Drawing Title ELECTRICAL	Phase 100% CONSTRUCTION	Project Title UPGRADE SP	S HVAC &		Project Number 656-18-300
	MEP Engineers + Architects	701 Forest Ave	Miller-Remick LLC  M.E.P. & Structural Engineering A Service Disabled Veteran Owned		Construction and Facilities	FIRST FLOOR - DEMOLITION & NEW WORK PART PLANS	DOCUMENTS NOT FOR CONSTRUCTION	ENVIRONMEN	ITAL CONTRO	DLS	Building Number
	11/3 Research Way Forest, VA 24551 1-866-267-6839	Portland, ME 04103 (207) 828-4511 wbrcinc.com	Small Business  1010 KINGS HIGHWAY SOUTH CHERRY HILL, NEW JERSEY 08034 PHONE: (856)429-4000 FAX: (856)429-5002		Management	Approved: Project Director	FULLY SPRINKLERED	ST. CLOUD VA			]
NO. DESCRIPTION DATE	WISSION TO THE PROPERTY OF THE		FAX: (856)429-5002 MR PROJECT NO: 0376-0011		U.S. Department of Veterans Affairs	S		2022-07-15	RC	DR	111-EP111

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1 CRAWL SPACE - POWER PLAN

SCALE: 3/32" = 1'-0"

ENGINEER OF RECORD

FAX: (856)429-5002

MR PROJECT NO: 0376-0011

701 Forest Ave Portland, ME 04103

(207) 828-4511

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Miller-Remick LLC

M.E.P. & Structural Engineering

A Service Disabled Veteran Owned

Small Business

1010 KINGS HIGHWAY SOUTH CHERRY HILL, NEW JERSEY 08034 PHONE: (856)429-4000

VA FORM 08-6231

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DESCRIPTION

DATE

MEP Engineers + Architects 1173 Research Way Forest, VA 24551 1-866-267-6839

ACTUAL NORTH

MILLER-REMICK LLC PROFESSIONAL ENGINEER

5

Drawing Title

Office of

Construction

and Facilities

Management

U.S. Department of Veterans Affairs

# **GENERAL SHEET NOTES:**

- 1. REFER TO SHEETS E-001 AND E-002 FOR ABBREVIATIONS, SYMBOLS AND NOTES.
- 2. REFER TO SHEET 116-E-111 FOR LOCATION OF PANEL 116-EQ1-1. 3. REFER TO SERIES E-700 SHEETS FOR PANELBOARD SCHEDULES AND LIGHTING
- FIXTURE SCHEDULE. 4. REFER TO ARCHITECTURAL DRAWINGS FOR ICRA BARRIER LOCATIONS AND ALL WORK
- ASSOCIATED WITH CEILINGS. 5. ADHERE TO ALL ICRA REQUIREMENTS LISTED ON GIOO1 AND IN SPECIFICATIONS. THE DIFFERENT WORK SPACES ICRA LEVEL HAS BEEN DEFINED BY THE VA AS LEVEL 3 UNLESS OTHERWISE INDICATED. ALL EQUIPMENT IN THE ROOM SHALL BE PROTECTED
- 6. REFER TO SPECIFICATION 02 82 11 APPENDIX A1 FOR ABATEMENT REPORT. THE CONTRACTOR SHALL ADHERE TO AND FOLLOW THE ABATEMENT REPORT FOR ALL

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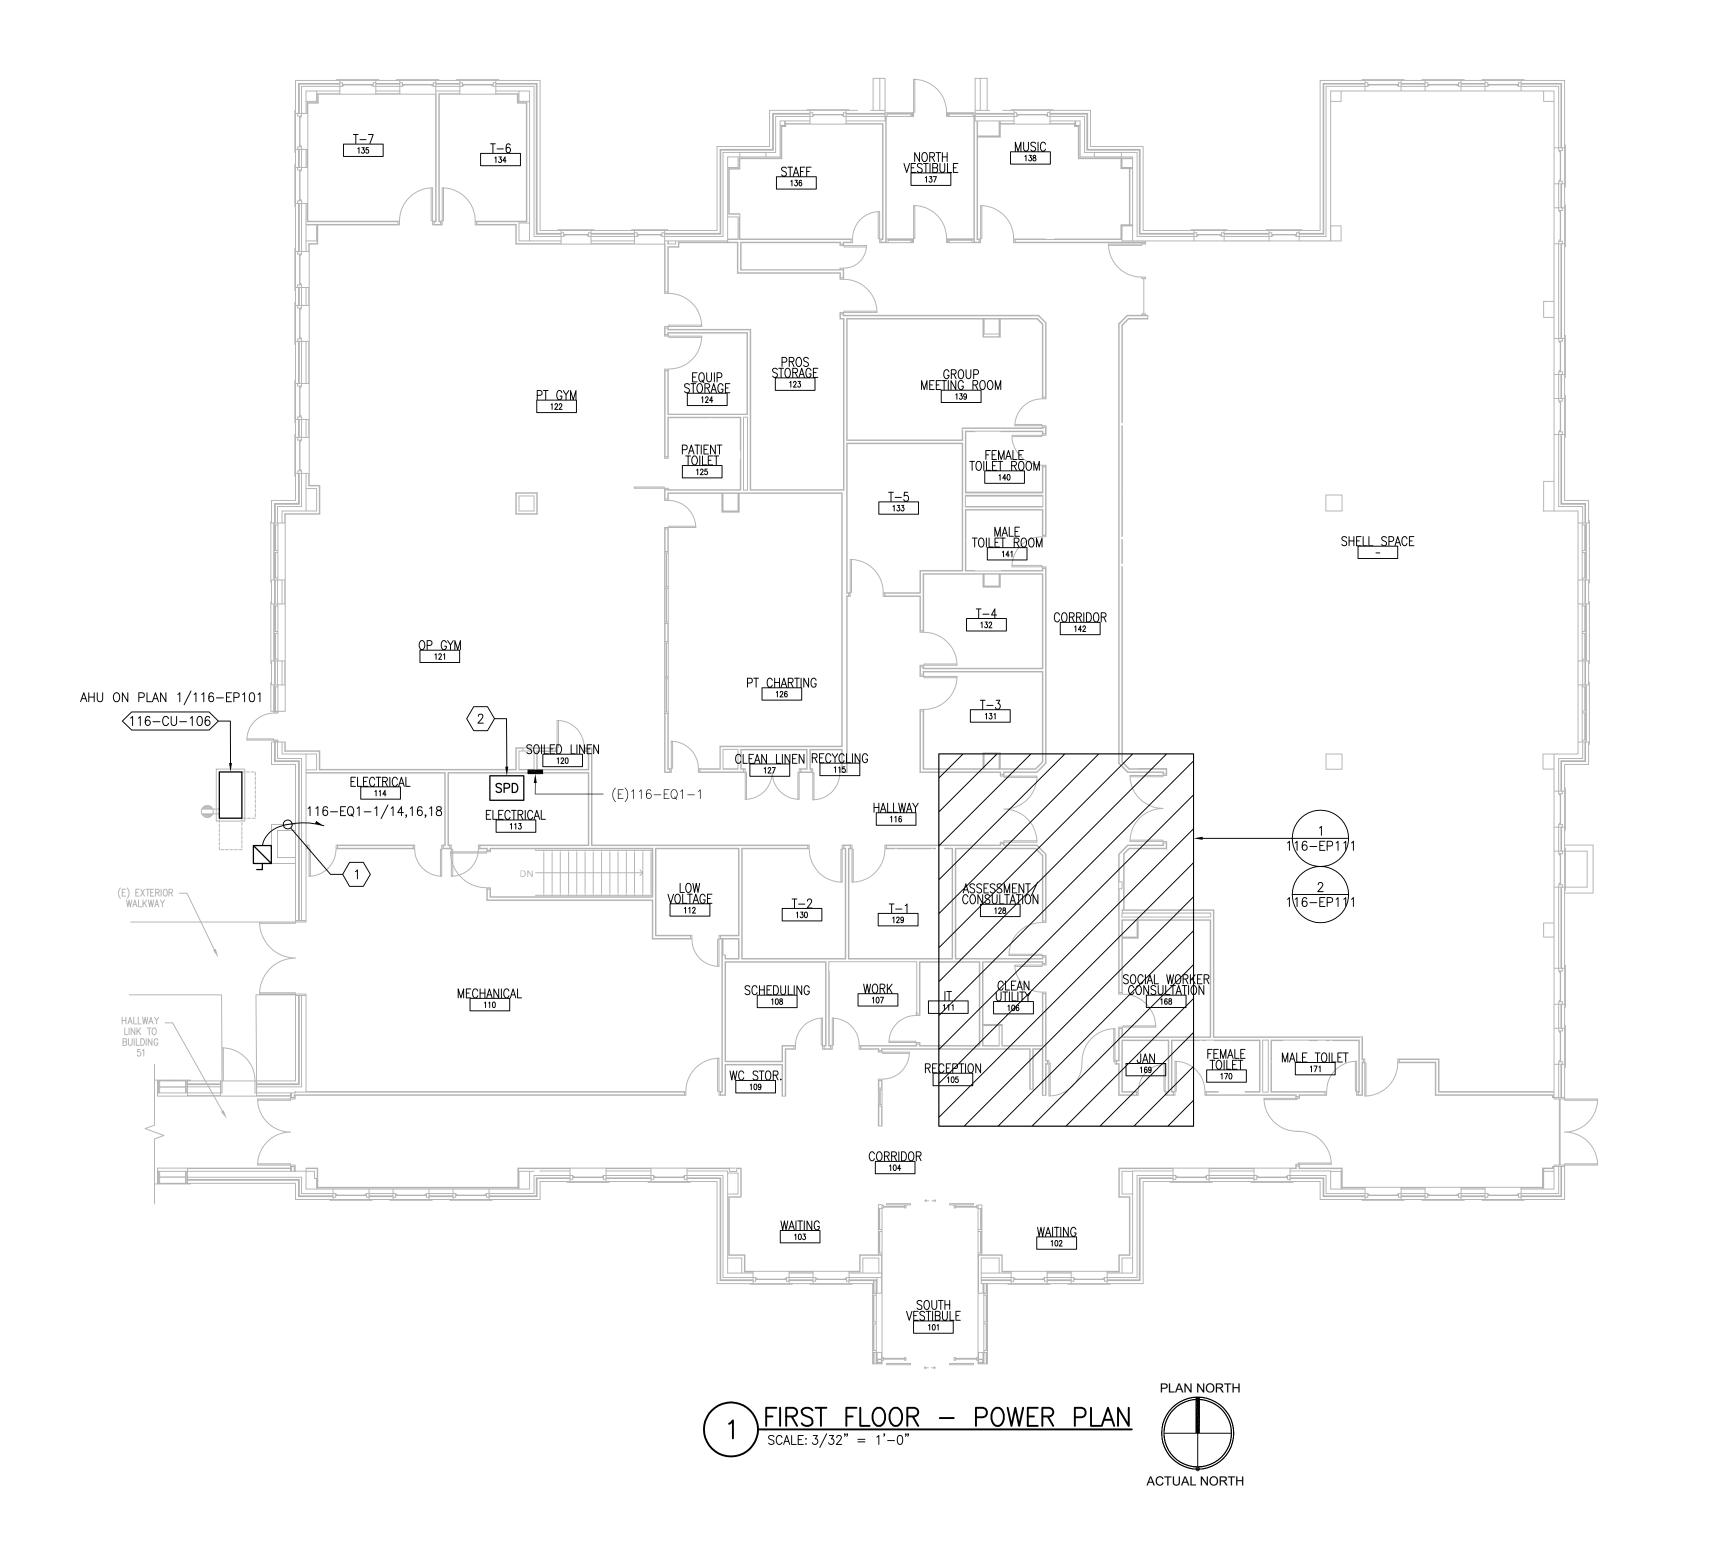
EQUIPMENT AND ROUTING OF PIPING/DUCT WORK.

KNOWN ABATEMENT LOCATIONS. 7. REFER TO MECHANICAL AND PIPING DRAWINGS FOR LOCATIONS OF MECHANICAL

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- 1. FACTORY PRE-WIRED AHU CONTROL PANEL MOUNTED ON UNISTRUT FRAME, WITH 6'-0" INTERCONNECTING WIRING TO ASSOCIATED AHU, PROVIDED BY MECHANICAL CONTRACTOR. MAKE ALL FINAL CONNECTIONS.
- 2. PROVIDE 30A/3P/15AF FUSED DISCONNECT SWITCH IN NEMA 1 ENCLOSURE. CONNECT TO ADJACENT CONTROL PANEL AND INDICATED CIRCUIT WITH (3)#12 + (1)#12G IN 3/4"C. MOUNT DISCONNECT SWITCH ON UNISTRUT FRAME PROVIDED BY MECHANICAL
- 3. PROVIDE 20A MOTOR-RATED SWITCH WITH INDICATOR LIGHT. ROUTE (2)#12 + (1)#12GIN 3/4"C TO INDICATED PANEL AND ADJACENT PUMP. MAKE FINAL CONNECTIONS.

Project Title Project Number 656-18-300 **ELECTRICAL** 100% CONSTRUCTION UPGRADE SPS HVAC & DOCUMENTS NOT FOR CONSTRUCTION CRAWL SPACE - POWER PLAN **ENVIRONMENTAL CONTROLS Building Number** Approved: Project Director Drawing Number ST. CLOUD VA MEDICAL CENTER, MN FULLY SPRINKLERED Checked 116-E-101 Drawn RC DR 2022-07-15



- 1. REFER TO SHEETS E-001 AND E-002 FOR ABBREVIATIONS, SYMBOLS AND NOTES.
- 2. REFER TO SERIES E-700 SHEETS FOR PANELBOARD SCHEDULES AND LIGHTING FIXTURE SCHEDULE.
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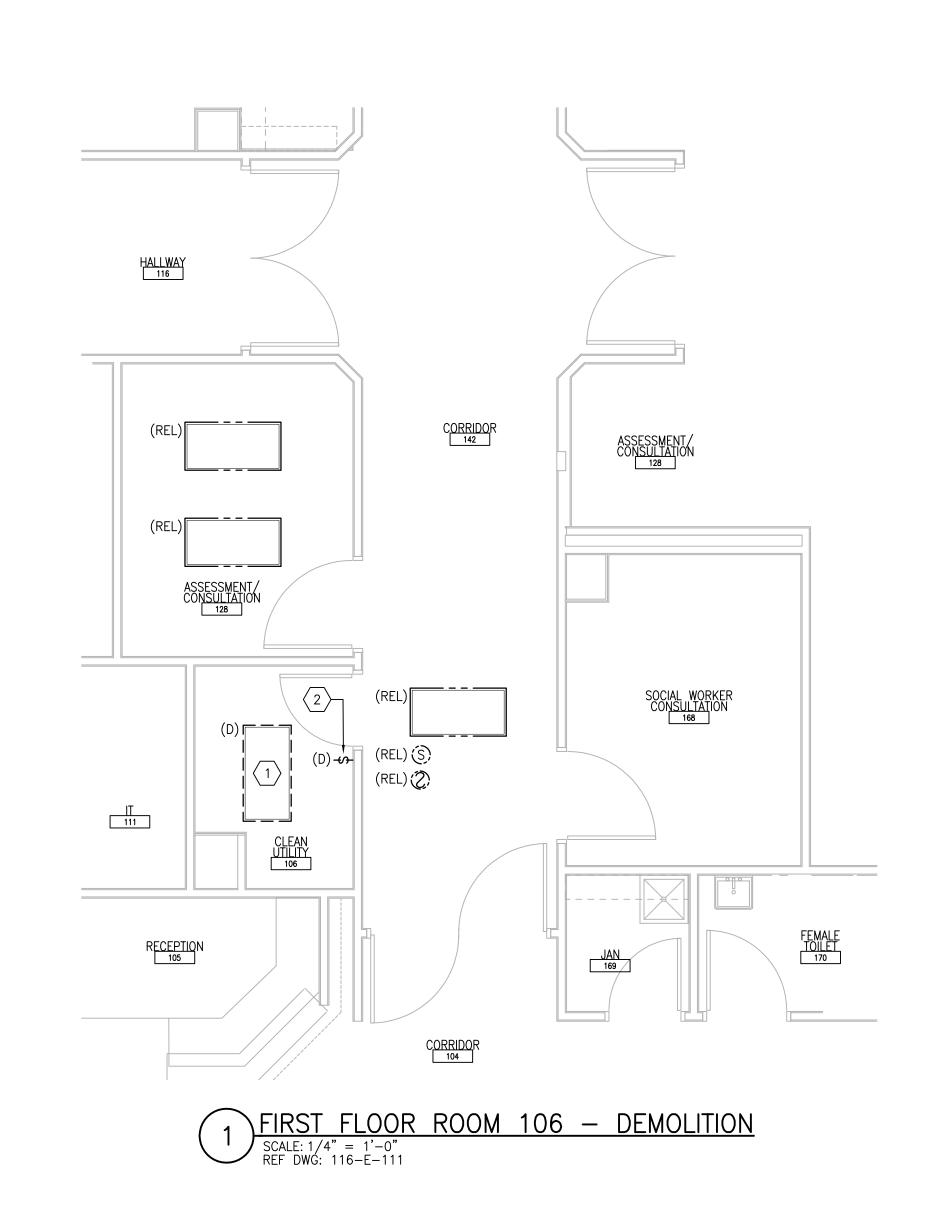
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- 2. PROVIDE SPD IN NEMA 1 ENCLOSURE BELOW OR ADJACENT TO ASSOCIATED PANEL. MAKE FINAL CONNECTIONS. REFER TO SHEET E-702.

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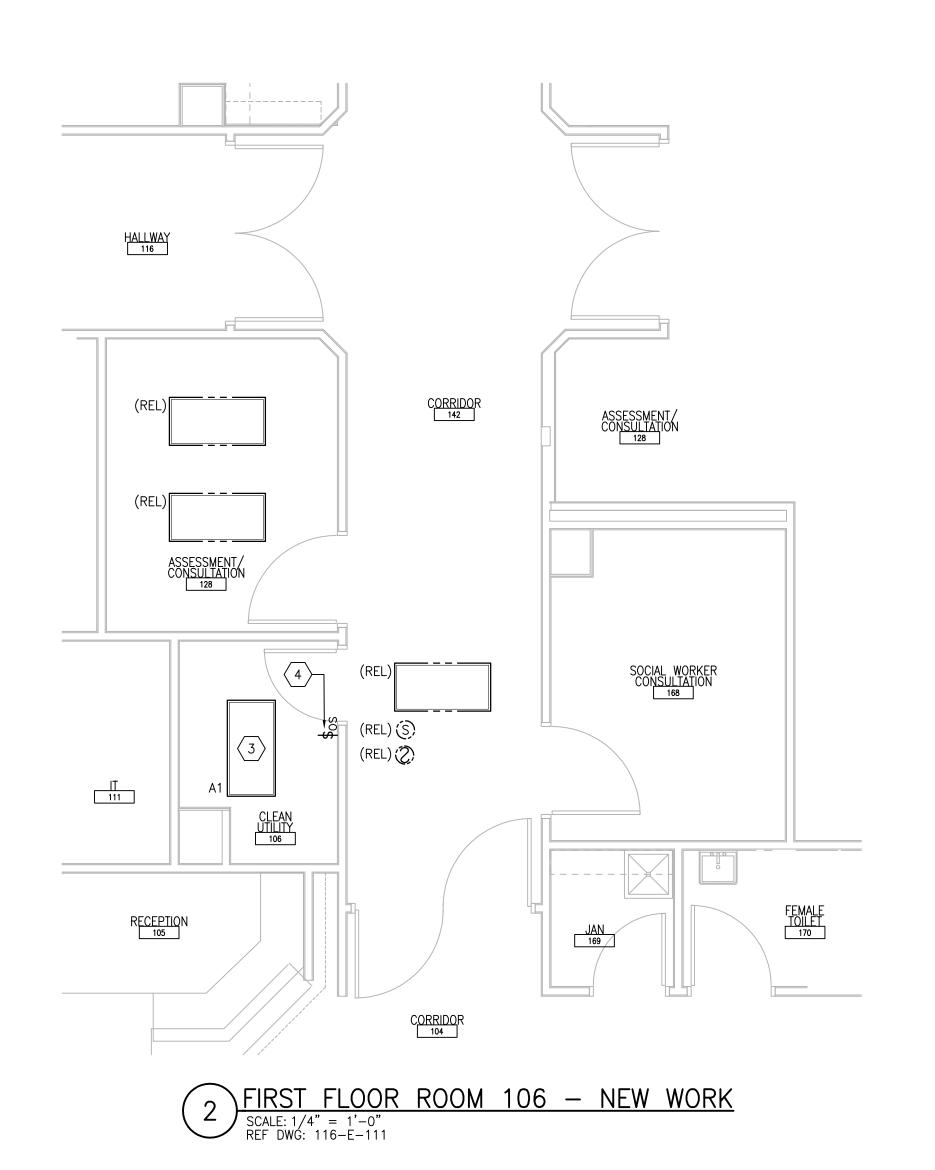
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VA FORM 08-6231





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- 7. REFER TO SPECIFICATION 02 82 11 APPENDIX A1 FOR ABATEMENT REPORT. THE CONTRACTOR SHALL ADHERE TO AND FOLLOW THE ABATEMENT REPORT FOR ALL KNOWN ABATEMENT LOCATIONS.
- 8. COORDINATE ACCESS PROCEDURES, PROTECTION OF EXISTING RME STORAGE RACKS/EQUIPMENT, CLEANUP AND WORK HOURS WITH THE VA.
- 9. REFER TO MECHANICAL AND PIPING DRAWINGS FOR LOCATIONS OF MECHANICAL EQUIPMENT AND ROUTING OF PIPING/DUCT WORK.
- 10. DEVICE/LIGHTING FIXTURE LABELED AS (REL) SHALL BE DISCONNECTED AND REMOVED DURING CONSTRUCTION. UPON INSTALLATION OF NEW CEILING IN THE SPACE, RE—INSTALL AND CONNECT EXISTING DEVICE/LIGHTING FIXTURE. PROTECT WIRING AND DEVICE/LIGHTING FIXTURE DURING CONSTRUCTION.
- 11. OCCUPANCY SENSOR WALL SWITCH SHOWN ON DRAWING SHALL BE CONNECTED TO NEW LIGHTING FIXTURE(S) WITHIN THE SAME SPACE.

#### 

- DISCONNECT AND REMOVE EXISTING LIGHTING CIRCUIT. PROTECT BRANCH CIRCUIT DURING CONSTRUCTION.
- 2. DISCONNECT AND REMOVE EXISTING SWITCH. RETAIN BACK BOX AND ASSOCIATED CONDUIT AND WIRING.
- 3. PROVIDE NEW LIGHTING FIXTURE AND CONNECT TO EXISTING LIGHTING BRANCH CIRCUIT PREVIOUSLY FEEDING DEMOLISHED LIGHTING FIXTURE. CONNECT TO EXISTING ROOM LIGHTING CONTROLS. PROVIDE ADDITIONAL CONDUIT AND WIRING AS NEEDED.
- 4. PROVIDE NEW SWITCH INSTALLED IN EXISTING BACK BOX. CONNECT TO EXISTING LIGHTING BRANCH CIRCUIT.



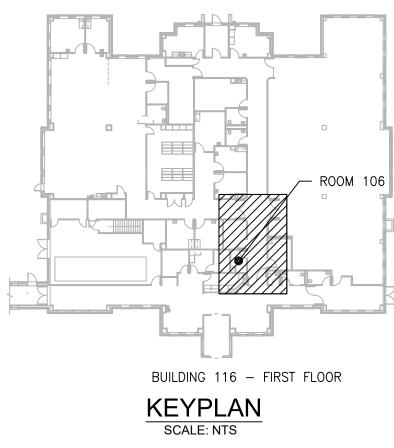


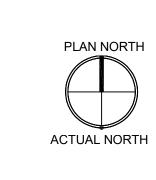PRINTS OF THIS DRAWING SHALL NOT BE USED FOR ANY PURPOSE WHATSOEVER WITHOUT THE SEAL AND SIGNATURE OF THE PROFESSIONAL ENGINEER. Project Title Drawing Title Project Number MILLER-REMICK LLC PROFESSIONAL ENGINEER ENGINEER OF RECORD Office of **ELECTRICAL** UPGRADE SPS HVAC & 100% CONSTRUCTION 656-18-300 DOCUMENTS NOT FOR CONSTRUCTION FIRST FLOOR - DEMOLITION & NEW Miller-Remick LLC

M.E.P. & Structural Engineering

A Service Disabled Veteran Owned

Small Business Construction **ENVIRONMENTAL CONTROLS Building Number WORK PART PLANS** and Facilities MEP Engineers + Architects 1173 Research Way 701 Forest Ave Portland, ME 04103 Approved: Project Director Management Drawing Number Forest, VA 24551 1-866-267-6839 (207) 828-4511 1010 KINGS HIGHWAY SOUTH CHERRY HILL, NEW JERSEY 08034 ST. CLOUD VA MEDICAL CENTER, MN **FULLY SPRINKLERED** PHONE: (856)429-4000 Checked 116-EP111 FAX: (856)429-5002 U.S. Department of Veterans Affairs MR PROJECT NO: 0376-0011 RC 2022-07-15 DR DESCRIPTION DATE

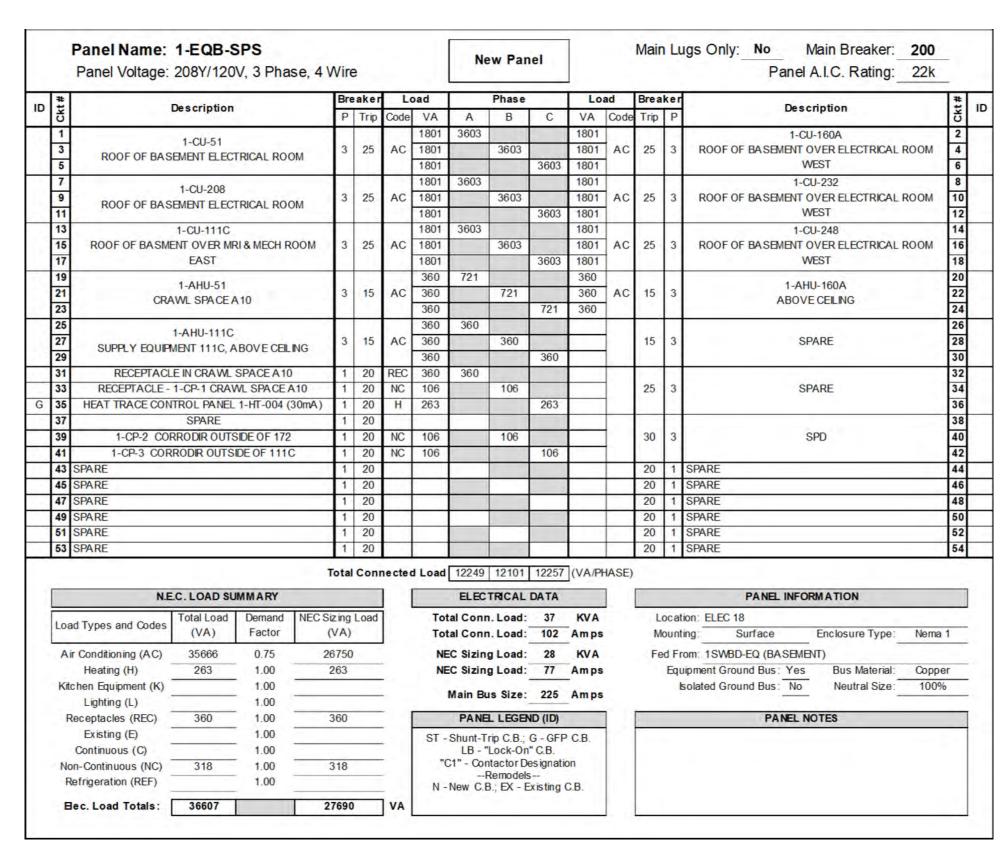

		Panel Name: Panel Voltage:		V, 3 Pha	se, 4 V	Vire				Exist	ing Pa	anel			Main	Lu	ugs Only: Yes Main Breaker:  Panel A.I.C. Rating: 22k		
D	#		Description			Brea	aker	Lo	oad		Phase		Loa	ıd	Brea	ker	Description	#	
_	Ckt #		Description			Р	Trip	Code	VA	Α	В	С	VA	Code	Trip	Р	Description	Ckt	Ľ
X	3 5		1-SF-3			3	100	С	9607 9607 9607	19214	19214	19214	9607 9607 9607	С	100	3	1-SF-2	4	
X	7 9 11	1, =	1-RF-3			3	40	C C	3843 3843 3843	8646	8646	8646	4804 4804 4804	С	50	3	1-RF-2	8 10 12	E
X	13 15 17		1-EF3-3			3	15	C	1441 1441	1572	1572	1441	131 131	н	20	2	HEAT TRACE CONTROL PANEL 1-HT-001 (30m A) ATTIC EAST NEAR 1-AHU-208 * SPARE *	14 16 18	
X	19	JOHNSO	ON CONTROL	PANFI		1	20	С	180	780		1441	600	С	20		1-EF-2	20	
	21		TIC LIGHT/RE			1	20	REC	360		360				20	1	SPARE	22	_
X	23		1-EF-1			1	20	С	600			863	263	Н	20	1	HEAT TRACE CONTROL PANEL 1-HT-002 (30m A) *	24	t
X	25	JOHNS	SON CONTROL	NAE		1	20	С	180	732			552				1-P-1 *	26	t
(	27	RECEP	TACLE FOR 1	I-CP-5		1	20	REC	360		912		552	С	15	3	ATTIC EAST	28	
X	29	RECEPTACLE	S NEAR 1-AH	U-208 & 1-I	P-1	1	20	REC	360			912	552				N.110 2.01	30	•
	31 33 35		1-AHU-208 * ATTIC EAST			3	15	AC	360 360 360	12369	12369	12369	12009 12009 12009	С	125		PANEL 1ECA	32 34 36	
V	37 39 41		SPD*			3	30									3		38 40 42	
					To	otal (	Conr	ecte	Load	43314	43074	43446	(VA/PH	IASE)					
		N.E	C. LOAD SU	MMARY						ELECT	RICAL	DATA					PANEL INFORMATION		
	Load	d Types and Codes	Total Load (VA)	Demand Factor	NEC Siz	ing L /A)	.oad			tal Conn. tal Conn.			KVA Amps			ocat ount	ion: ATTIC WEST ting: Surface Enclosure Type: Nema	1	
		Conditioning (AC) Heating (H) hen Equipment (K) Lighting (L)	1081 525	0.75 1.00 1.00 1.00	00 525 NEC 00 M 00 1080 00 ST - S	EC Sizing EC Sizing Main Bus	Load:	360	-		Fe	Equ	rom: 1SWBD-EQ (BASEMENT)  uipment Ground Bus: Yes Bus Material: Coppe solated Ground Bus: No Neutral Size: 100%						
	Re	eceptacles (REC)	1080	1.00	10	080				PANEL	LEGEN	ID (ID)					PANEL NOTES		1
	Nor	Existing (E) Continuous (C) n-Continuous (NC) ofrigeration (REF)	ptacles (REC) 1080 1.00 1080  x isting (E) 1.00  atinuous (C) 127149 1.00 127149  portinuous (NC) 1.00  peration (REF) 1.00				"	LB - "L C1" - Cont R	ock-On actor De emodels	" C.B. es ignation	on		CIRC	MS N	E D NQ NOTED IN BOLD ARE NEW WORK. REUSE EXISTING I BREAKER, UNO. VIDE NEW BREAKER IN PLACE OF EXISTING BREAKER(S	5).			
	Be	c. Load Totals:	129835		129	9565	"C1" - Co N - New C.												

	Panel Name: Panel Voltage:		V, 3 Phas	se, 4 V	Vire	е			Exis	sting Pa	anel			Main	ı Lu	ugs Only: No Main Breaker: 125 Panel A.I.C. Rating: 22k		
#		Des evinties			Bre	aker	L	oad		Phase		Loa	ad	Brea	ker	Description	#	:
Ckt#		Description			Р	Trip	Code	VA	Α	В	C	VA	Code	Trip	Р	Description	Ckt#	i
1	E	XHAUST FAI	V		1	20	С	600	1140			540	REC	20	1	ATTIC LIGHTS AND RECEPTACLE	2	
3			121-2					2882		7686		4804					4	
5	AHU	I-1 EAST MOT	TOR		3	30	AC	2882	7000		7686	4804	AC	50	3	AHU-1 WEST MOTOR	6	
7	AULIALIC	HTS AND RE	CEDTA CLE		1	20	С	2882 540	7686	646		4804 106	NC	20	4	RECEPTACLE FOR 1-CP-4, A TTIC WEST	10	
11		ON CONTROL			1	20	C	360		040	540	180	REC	20	1	CONVENIENCE RECEPTACLE NEAR 1-AHU-232	12	
13	HEAT TRACE CON			30m A)	_			131	492		040	360	1120		i.		14	
15		EST NEAR 1-			2	20	Н	131		492		360	AC	15	3	1-A HU-232	16	
17	HEAT TRACE CON	TROL PANEL	. 1-HT-005 (	30m A)	1	20	Н	263			623	360	0.01			A TTIC WEST	18	8
19	1-AHILA2	17 (PACKAC	SED AHUI)					2642	3002			360				1-A HU-248	20	
21	1ST FLOOR ROO			A217	3	30	AC	2642		3002		360	AC	15	3	ATTIC WEST	22	
23								2642			3002	360					24	
25														30	2	SPD	28	
27 29				-								_		30	3	SPD	30	
Loa	N.E	Total Load (VA)	Demand Factor	NEC Siz	zing				ELEC tal Conn		36	KVA Amps		- 5	ocat	PANEL INFORMATION  tion: ATTIC WESET  ting: Surface Enclosure Type: Nema	1	
Ai	r Conditioning (AC)	33145	0.75	24	858	3		NE	C Sizin	g Load:	28	KVA		Fe	d Fr	rom: 1EB-A		•
	Heating (H)	525	1.00		25				C Sizin			Amps				ipment Ground Bus: Yes Bus Material: Coppe	er	
Kit	hen Equipment (K)		1.00						Main Bu	o Cizo:	225	Amno.			Ŀ	solated Ground Bus: No Neutral Size: 100%	)	
	Lighting (L)		1.00						217977127			Allipa						
R	eceptacles (REC)	720	1.00	7	20				PANE	L LEGEN	ID (ID)					PANEL NOTES		
	Existing (E)	1500	1.00		500			ST -	Shunt-T			C.B.				E D I-LINE HCP		
No	Continuous (C) n-Continuous (NC)	106	1.00		06			"(	LB - C1" - Cor	Lock-On tactor De		on				NOTED IN BOLD ARE NEW WORK. REUSE EXISTING		
	efrigeration (REF)	100	1.00					N	F New C.E	Remodels		CB				Γ BREAKER, UNO. VI DE NEW BREAKER I N PLACE OF EXISTING BREAKER(S	5).	
	ec. Load Totals:	35996		1 2	7709	1	l VA	IN -	INEW C.L	J., LX - L	Alsting	C.D.				and the second s		

		Panel Voltage:			se, 4	Wir	е			Ne	ew Par	nel			Mair	ı Lu	ugs Only: Yes Main Breaker: 60 Panel A.I.C. Rating: 10k
D	Ckt #		Description				eaker		oad		Phase		Lo		Brea		Description
	Ck					P	Trip	Code	VA	Α	В	С	VA	Code	Trip	Р	2001.
G	1	2-HT-003 HEA		NTROL PAN	EL	1	20	Н	165	2807			2642		-		
1	3		PUMP 2-P-1			1	20	NC	506		3148		2642	AC	30	3	2-AHU-117
V	5	HUN	MIDIFIER 2-H-1	117		1	20	AC	1900			4542	2642				
V	7		SPARE			1	20			1.1					20	1	SPARE
1	9		SPARE			1	20								20	1	SPARE
1	11		SPARE			1	20								20	1	SPARE
V	13		SPARE			1	20									0	100
N	15					1	20							]	30	3	SPD
V	17		SFARE			1	20							_			
		SPARE   SPARE   SPARE     SPARE     SPARE     SPARE     SPARE     SPARE     SPARE     SPARE     SPARE     SPARE     SPARE     SPARE     SPARE   SPAR			Total	Con	nected	Load		3148		(VA/Pt	HASE)	_			
		N.E	C. LOAD SU	MMARY						ELEC	TRICAL	DATA					PANEL INFORMATION
	Los	ad Types and Codes	Factor   Conditioning (AC)   9826   1.00	Demand	NEC S	Sizing	Load	]	Tot	tal Conr	ı. Load:	10	KVA		L	ocat	ion: MECH RM 11
	LO	du Types and codes			(VA)			Tot	tal Conr	1. Load:	29	Amps		M	ount	ing: Surface Enclosure Type: Nema	
	Α	ir Conditioning (AC)	9826	1.00		9826			NE	C Sizin	g Load:	10	KVA		Fe	d Fr	om: EXISTING PANEL 2MSB
		Heating (H)	165	1.00		165	••••••	•••	NE	C Sizin	g Load:	29	Amps			Equ	ipment Ground Bus: Yes Bus Material: Coppe
	Kit	tchen Equipment (K)		1.00						Main De	0:	400				k	solated Ground Bus: No Neutral Size: 100%
		Lighting (L)	Lighting (L) 1.00 ceptacles (REC) 1.00 Existing (E) 1.00 Continuous (C) 1.00 -Continuous (NC) 506 1.00 506	***************************************	_		Main Bu	ıs Size:	100	Amps							
	F	Receptacles (REC)		1.00						PANE	L LEGE	ND (ID)					PANEL NOTES
		Existing (E)		1.00			•••••	_	ST -	- Shunt-T	rip C.B.;	G-GFI	C.B.	1	PAN	IELI	NTEGRAL TO 15kVA MINI UNITSUBSTATION.
		Continuous (C)	eptacles (REC) 1.00  Existing (E) 1.00  ontinuous (C) 1.00  Continuous (NC) 506 1.00 506  rigeration (REF) 1.00				_		LB - "	Lock-On	"C.B.			PRC	VID	DE INTEGRAL SURGE PROTECTIVE DEVICE.	
	N	on-Continuous (NC)				"(		ntactor D Remodel:		on		FIN	ALL	OCATION TO BE BASED ON FIELD SURVEY AND VA			
	F	Refrigeration (REF)		_	N -		B.; EX - E	_	C.B.		APP	ROV	/AL				
			40400				_	I VA									

_	#			2		Bre	aker	L	oad		Phase		Load		Brea	ker	#
ID	Ckt #		Description			Р	Trip	Code	VA	Α	В	С	VA C	ode	Trip	Р	Description #
3.0	1		ALC:N					472	14411	14411							2
EX	3		PNL 3-EQ3-1			3	150	NC	14411		14411	4 4 4 4 4			15	3	SPARE 4
	5 7				- 4	⊢			14411 19214	19214		14411					6 8
X	9		PNL EQ2-B			3	200	NC	19214	19214	19214				15	3	SPARE 10
	11		THE EUL D			ľ	200		19214		10211	19214				ľ	12
	13								28821	28821					15	1	SPARE 14
X	15		ELEVATOR			3	300	NC	28821		28821				15	1	SPARE 16
	17								28821			28821			15	1	SPARE 18
X	19		METERING			1	20	NC	200	200					15	1	SPARE 20
	21		SPARE			1	20								20	1	SPARE 22
3		3-HT-001 HEAT TRA	CECONTRO	L PANEL (	30m A) *	1	20	н	160			160			20	1	SPARE 24
	25 27		3-AHU-113*						2642	2642	00.40				00		26 SPD* 28
N	29		(GRADE)			3	30	AC	2642 2642		2642	2642			30	3	SPD* 28 30
		N.E	.C. LOAD SU	MMARY	Т	otal	Con	necte	d Load		65088		(VA/PHA	SE)			PANEL INFORMATION
		17	Total Load	Demand	NEC Siz	zing	Load	Ī	To	tal Conr	. Load:	196	KVA		L	ocat	ion: REFER TO FLOOR PLAN.
	Loa	d Types and Codes	(VA)	Factor	()	/A)			To	tal Conr	. Load:	543	Am ps		M	ount	ing: Surface Enclosure Type: Nema 1
	Air	r Conditioning (AC)	7926	1.00	79	926			NE	EC Sizin	g Load:	196	KVA		Fe	ed Fr	rom: EX FEEDERS AND CONDUIT(S).
		Heating (H)	160	1.00	1	60		w-	NE	C Sizin	g Load:	543	Am ps				uipment Ground Bus: Yes Bus Material: Copper
	Kito	chen Equipment (K)	***************************************	1.00	***************************************			m.		Main D	ıs Size:	600	Amna			i	solated Ground Bus: No Neutral Size: 100%
		Lighting (L)		1.00						Main Bu	is size.	000	Am ps				
	R	eceptacles (REC)		1.00						PANE	L LEGE	ND (ID)					PANEL NOTES
		Existing (E)		1.00					ST -		rip C.B.;		C.B.		SQL	JAR	E D NQ
		Continuous (C)	107500	1.00	100	750			",		Lock-On ntactor D	12020	n .				NOTED IN BOLD ARE NEW WORK. REUSEEXISTING
		n-Continuous (NC)	187539	1.00	18	7539	9	-			Remodels	3-					TBREAKER, UNO.
	K	efrigeration (REF)		1.00					N -	New C.I	3.; EX - E	Existing C	CB.			KU	VIDE NEW BREAKER IN PLACE OF EXISTING BREAKER(S).
	B	ec. Load Totals:	195624		19	562	4	VA									1 - 1 - 1 - 1 - 1 - 1 - 1 - 1 - 1 - 1 -

01.4.4		-			Bir Janes	Conne	cted Loads	De m an	d Loads
Ckt.#	Poles	Frame	Trip	ID	Description	KVA	Amps	KVA	Amps
1	3	225	200	EX	28-EC-1	58	160	40	112
2	3	225	200	EX	NORTH ELEVATOR (EL-1) P-1	54	150	38	105
3	3	60	25	N	28-CU-210 *	5	15	5	15
4	3	60	25	N	28-CU-257 *	5	15	5	15
5	1	60	20	EX	SPARE				
6	3	125	125	EX	SEWER PUMP BY APARTMENTS	33	92	23	64
7	3	400	400	EX	MAIN DISCONNECT				
8	2	60	20	EX	SPARE				
9	2	60	20	EX	SPARE		11		
10	3	100	100	EX	28-CR-2 (RM 234)	29	80	20	56
11	3	100	100	EX	28-CR-B (RM 77)	29	80	20	56
12	3	100	100	N	28-ECA-2 *	5	14	5	14
13	3	60	30	N	SPD*				
14	1	60	20	EX	SPARE				
15	1	60	20	EX	SPARE				
16	1	60	20	EX	SPARE				
17	1	60	20	EX	SPARE		1 3-		
18	1	60	20	EX	SPARE				
_									
		P/	ANEL NOTE	S	ELECTRICAL DATA	PA	NEL INFORMATI	ON	
	QUARED				Total Conn. Load: 218 KVA	Location: REFER T		T	
		ED IN BOLD		ORK. E OF EXISTING	Total Conn. Load: 606 Am ps	Mounting: SURF			lema 1
	REAKER(S			e or Enormo	NEC Sizing Load: 158 KVA NEC Sizing Load: 437 Amps	Fed From: EX FEED Equipment Ground B		, ,	Copper
						Isolated Ground B			100%
					Main Bus Size: 400 Am ps				
					PANEL LEGEND (ID)				
					ST - Shunt-Trip C.B.; G - GFI C.B. LB - "Lock-On" C.B. "C1" - Contactor DesignationRemodels N - New C.B.; EX - Existing C.B.				

**GENERAL SHEET NOTES:** 

PROTECTION RATED BREAKER.

3/4" CONDUIT. MAKE FINAL CONNECTIONS.

1. REFER TO SHEETS E-001 AND E-002 FOR ABBREVIATIONS, SYMBOLS AND NOTES.

3. HEAT TRACE CONTROL PANEL BRANCH CIRCUIT: PROVIDE 30mA GROUND FAULT

REMOVED FROM PANELS SHALL BE TURNED OVER TO VA COR.

2. <u>BREAKERS FOR EXISTING PANELS:</u> NEW BREAKERS PROVIDED IN EXISTING PANELS SHALL BE COMPATIBLE WITH THE EXISTING PANEL AND SHALL HAVE THE SAME AIC


RATING AS THE EXISTING PANEL. UPDATE PANELBOARD SCHEDULE. EXISTING BREAKERS

4. <u>SURGE PROTECTION DEVICE (SPD):</u> FOR PANELS NOTED WITH A NEW SPD, THE CONTRACTOR SHALL PROVIDE A SPD IN NEMA 1 ENCLOSURE BELOW OR ADJACENT TO

ASSOCIATED PANEL. PROVIDE WITH INDICATED BREAKER AND (3)#10 + (1)#10G IN

	Panel Name: Panel Voltage:			Wir	е			Ne	ew Par	nel			Main	Lug	S Only: No Main Breaker: 100  Panel A.I.C. Rating: 22k	
) # t		Description			eakei		oad		Phase		Lo		Brea		Description	Ckt #
_				Р	Trip	Code		A	В	С	VA	Code	Trip	P.		_
3		28-AHU-210		3	15	AC	480 480	960	960		480	AC	15	3	28-AHU-257	4
5		20-A110-210		3	13	AC	480		900	960	480	AC	15	3	20-A110-231	6
7				+			210	390		300	180	REC	20	1	CONVENIENCE RECPT 28-AHU-210	8
9	28-HT-001 HEAT TR	A CE CONTR	OL PANEL (30mA	) 2	20	Н	210	000	716		506	NC	20	1	28-P-1	10
1	28-HT-002 HEAT TR	ACE CONTR	OL PANEL (30m/	) 1	20	Н	210			316	106	NC	20	1	28-CP-1	12
1:					20	Н	190	370			180	REC	20	1	CONVENIENCE RECPT 28-AHU-210	14
1		ICE RECPT 28	ALLER AND	1	20	REC	180		360		180	REC	20	1	CONVENIENCE RECPT NEAR 28-HT-003	16
1	,	SPARE		1	20								20	1	SPARE	18
19		SPARE		1	20								20	1	SPARE	20
2		SPARE		1	20								20	1	SPARE	22
2	3	SPARE		1	20					1			20	1	SPARE	24
2													20	1	SPARE	26
2		SPD											20	1	SPARE	28
2	9					_		4700	0000	4070	lova (D	14.00	20	1	SPARE	30
	NF	C. LOAD SU	MMARY	Tota	Con	necte 7	Load	1720	2036		(VA/Pł	1ASE) ]			PA NEL INFORMATION	
				Cizina	Lood	1	Tai		. Load:		KVA	J		o o otion	: PENTHOUSE	
L	oad Types and Codes	Total Load (VA)	Demand NEC Factor	(VA)	Load		1965		i. Load: i. Load:		Amps		- 5	ocation		. 1
_		, ,	1.07.5395			_					*					1 1
1	Air Conditioning (AC)	2880	1.00	2880					g Load:		KVA		Fe		: PANEL 28-EC-1	
1	Heating (H)	820	1.00	820			NE	C Sizin	g Load:	14	Amps				ment Ground Bus: Yes Bus Material: Copp	
r	(itchen Equipment (K)		1.00					Main Bu	ıs Size:	100	Amps			ISO	ated Ground Bus: No Neutral Size: 1009	<b>%</b>
	Lighting (L) Receptacles (REC)	720	1.00	720				DANE	L LEGE	VD (ID)	w .	1			PANEL NOTES	
	Existing (E)	120	1.00	120								-			PANEL NOTES	
	Continuous (C)		1.00				ST -		rip C.B.; 'Lock-On		C.B.					
1	Non-Continuous (NC)	612	1.00	612			"(		ntactor D		on					
	Refrigeration (REF)		1.00				NI		Remodels		n D					
			***************************************			-	IN -	New C.I	3.; EX - E	Existing (	J.D.	1	I			

	100	anel Name: anel Voltage:		La constitución de la constituci	se, 4 V	Vire	9			Exis	sting Pa	anel			Mair	ı Luç	gs Only: Yes Main Breaker: Panel A.I.C. Rating: 35k		
	#					Bre	aker	L	oad		Phase		Loa	d	Brea	ker	2	#	Г
ID	Ckt #		Description			Р	Trip	Code	VA	Α	В	С	VA	Code	Trip	Р	Description	Ckt#	l
	1			127 -					2882	5764			2882				100 200 CB 200 CB	2	Γ
EX	3	HW	P-1 (MECH 14	10)		3	60	NC	2882		5764		2882	NC	60	3	HWP-2 (MECH 140)	4	]
	5								2882	(		5764	2882					6	L
_,	7					١.				1801	1001		1801				20.01174	8	1
EX	11		SPD			3	30				1801	1801	1801 1801	AC	25	3	29-CU-7 *	10	
	13					⊢			721	1081		1001	360					14	_
EX	15		SPD EVAP.			3	15	NC	721	1001	1081		360	AC	15	3	29-AHU-7	16	1
	17		OI D EVIII .				10	110	721		1001	1081	360			ľ	ZO ANIO 1	18	
	19	/w.da	. v Savado	100-					1664	3465			1801			$\vdash$		20	_
EX	21	ACC	J-1 CONDEN	SOR		2	20	AC	1664		3465		1801	AC	25	3	29-CU-146 *	22	4
EX	23	HOT WATER G	EN. CTRLS &	MXVALVE	S	1	20	н	240			2041	1801					24	١
EX	25	CON	DENSATE PU	JMP		1	20	NC	106	466			360					26	r
EX	27	1ST FLOOR IT	ROOM A/C.S	PLIT SYSTE	М	2	20	AC	1664		2024		360	AC	15	3	29-AHU-146	28	
	29	1011200111		TEN OTOTE					1664			2024	360					30	
N	31		29-CP-1			1	20	NC	106	106	100					1	SPACE	32	
N	33	MAINTENAN	VCE RECPT ( 29-CP-2	RM COWA)		1	20	REC	180		180	106				1	SPACE SPACE	34	_
N	35 37		SPACE			1	20	NC	100			100				'	SPACE	36 38	_
EX	39		SPACE			$\vdash$								1	30	3	SPD	40	
	41		SPACE			$\vdash$									-			42	
		N.E.C. LOA  ypes and Codes  ypes and Codes  onditioning (AC) leating (H) n Equipment (K) ighting (L) ptacles (REC)  180	C. LOAD SU		NEC Six			]		ELEC	35571 TRICAL	DATA	(VA/PH	IASE)		oo otis	PANEL INFORMATION on: ELECTRICAL ROOM 12		
	Load T	ypes and Codes				VA)	Load				i. Load:					ocalic		1	M-
	A ir C	anditioning (AC)		6 4 2 4 4 4	,	0626					g Load:		KVA				m: 29-EQ-ATS		*
						240					g Load:		***		16		pment Ground Bus: Yes Bus Material: Copp	ρr	***
			210			- 10		•		LO GILIII	g Loud.						plated Ground Bus: No Neutral Size: 100		
		nditioning (AC) eating (H) n Equipment (K) ighting (L) ptacles (REC) xisting (E)								Main Bu	ıs Size:	400	Amps				······································		-
		eptacles (REC)	180	1.00	1	80				PANE	L LEGEN	ID (ID)					PANEL NOTES		Ī
		Existing (E)	ditioning (AC) 19626 1.00 ating (H) 240 1.00 Equipment (K) 1.00 hting (L) 1.00 accles (REC) 180 1.00 sting (E) 1.00 inuous (C) 1.00					ST -	Shunt-T	rip C.B.;	G - GFP	C.B.		SOL	JARE	D NF		1	
	Co	onditioning (AC) 19626 1.00 Heating (H) 240 1.00 In Equipment (K) 1.00 Existing (E) 1.00 Existing (E) 1.00 Continuous (NC) 83537 1.00	1.00	***************************************					LB - '	Lock-On	" C.B.					MMARY INCLUDES EXISTING P-2 ELEVATOR.			
		Continuous (NC)	ating (H) 240 1.00 Equipment (K) 1.00 Inting (L) 1.00 acles (REC) 180 1.00 sting (E) 1.00 Inding (E) 1.00 Inding (C) 1.00 Inding (C) 1.00 Inding (REC) 1.00 Inding (REC) 1.00	83	3537		w.	"(		ntactor De Remodels		on				OTED IN BOLD ARE NEW WORK. REUSE EXISTING			
	Refr	igeration (REF)		1.00					N -		Remodels 3.; EX - E		C.B.				BREAKER, UNO.		
		. Load Totals:			10			_				3		1	*	DROV	IDE NEW BREAKER INPLACE OF EXISTING BREAKER	S).	1

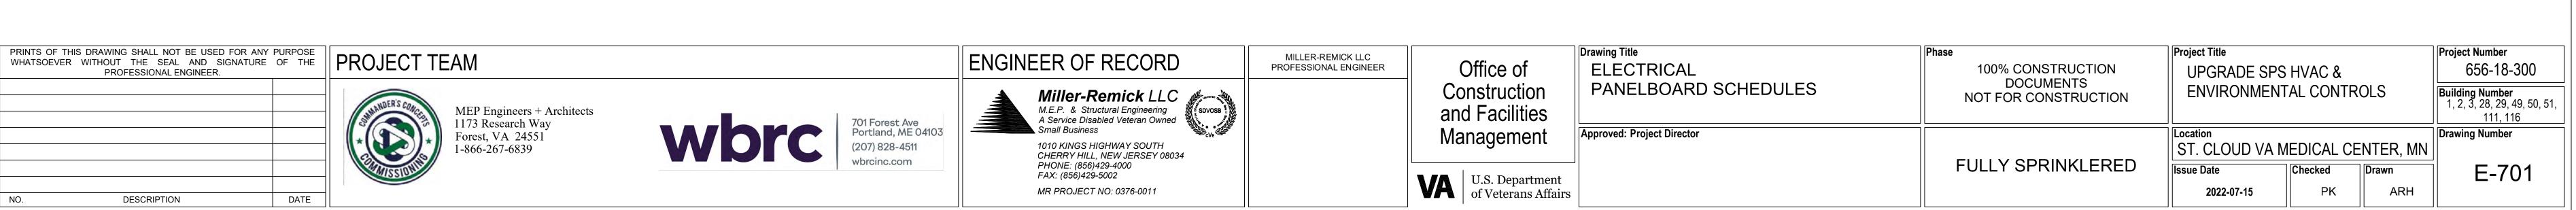

5

PRINTS OF THI WHATSOEVER

PRINTS OF THI WHATSOEVER

NO.

VA FORM 08-6231

	1 dilo	vollago.	1001, 0	Phase, 3 Wire			anel A.I.C. F		35k
Ckt.#	Poles	Frame	Trip	ID	Description		ed Loads	De m an	d Loads
1	3	1200	1200	EX	MAIN	KVA	Am ps	NVA	Am p
2	3	60	15	N	49-CU-14 (EXTERIOR)	7	9	7	9
3	3	60	15	N	49-CU-130 (EXTERIOR)		9	7	9
4	3	60	15	N	49-CU-230 (EXTERIOR)	7	9	7	9
5	3	60	30	N	SPD		3	-	,
6	,	- 00	30		SPACE	-		-	
7	3	600	400	EX	HEAT PUMP HP-1	333	400	200	240
8	3	600	600	EX	ATTIC PANEL 49EQA-1	499	600	299	360
9	3	60	15	N	49-AHU-14 (RM 14C)	2	2	2	2
10	3	60	15	N	49-AHU-130 (MECH 6)	2	2	2	2
11	3	60	15	N	49-AHU-230 (ATTIC)	2	2	2	2
12	3	- 00	13		SPACE	- 2	-	-	-
13	3	60	15	EX	HEAT PUMP HP-2	12	15	7	9
14	3	60	20	EX	VACUUM PUMP	17	20	10	12
15	3	60	30	EX	MEDICAL AIR PUMP	25	30	15	18
16	3	00	30	-X	SPACE	25	30	10	10
17	3	225	150	EX	SPARE		-		-
18	3	60	20	EX	CIRC. PUMP CP-2	17	20	10	12
19	3	60	20	EX	CIRC. PUMP CP-1	17	20	10	12
20	3	100	100	EX	GEO. CIRC PUMP P-1	83	100	50	60
21	3	100	100	EX	GEO. CIRC PUMP P-2	83	100	50	60
22	3	100	100	EX	XFMR 49EQB (ELEVATOR P-2)	83	100	50	60
		100	100		(122 0 0 0 0 0 0 0 0 0 0 0 0 0 0 0 0 0 0	- 00		- 31-3	
		P	ANEL NOTE	S	ELECTRICAL DATA	PANI	EL INFORMATI	ON	
S	QUARED	I-LINE			Total Conn. Load: 1196 KVA	Location: ELEC ROOM	M BASEMENT		
		ED IN BOLD	ARE NEW W	ORK	Total Conn. Load: 1438 Amps	Mounting: Surfac	e Enclosu	re Type: N	ema 1
						Fed From: ATS 49EQE			
					NEC Sizing Load: 876 Amps	Equipment Ground Bus			opper
					Main Bus Size: 1200 Amps	Is olated Ground Bus	: No Neut	ral Size:	100%
					PANEL LEGEND (ID)				
					ST - Shunt-Trip C.B.; G - GFI C.B. LB - "Lock-On" C.B. "C1" - Contactor DesignationRemodels N - New C.B.; EX - Existing C.B.				

		Panel Name: Panel Voltage:			se,	4 Wi	re				Ne	ew Par	nel			Mair	ı Lug	gs Only: <b>Yes</b> Main Breaker: Panel A.I.C. Rating: 35k	Κ.
5	#		Danada			В	reake	r	Loa	ıd		Phase		Loa	ad	Brea	ker	P	#
	Ckt #		Description			I	Trip	Co	de	VA	Α	В	С	VA	Code	Trip	Р	Description	CK+
I	1		50-CU-229							942.9	1886			942.9	133			50-CU-291	2
ŀ	3		(GRADE)			3	25	Α	100	942.9		1886	4000	942.9	AC	25	3	(GRADE)	4
1	7							4		942.9 221.9	443.7		1886	942.9 221.9			₩		8
ł	9		50-AHU-229			3	15	A		221.9	443.1	443.7		221.9	AC	15	3	50-AHU-291	1
ł	11		(ATTIC)			- 1	"	1		221.9		110.1	443.7	221.9	,,,	,,,	ľ	(ATTIC)	1
	13	50	0-CP-1 (ATTIC	)		-	20	N		120	240			120	NC	20	1	50-CP-2 (ATTIC)	1
_	15		ECEPT - ATTK			-		-		360		360				20	1	SPARE	1
t	17		SPARE				20									20	1	SPARE	1
1	19		SPARE			1	20								1	20	1	SPARE	2
_	21		SPARE													20	1	SPARE	2
_	23		SPARE													20	1	SPARE	2
1	25		SPARE													20	1	SPARE	2
_	27		SPARE													20	1	SPARE	2
_	29 31		SPARE					-	+							20	1	SPARE SPACE	3
4	33		SPACE			-		+	+					-			1	SPACE	3
_	35		SPACE			-		-	-								1	SPACE	3
_	37		SPACE					+	$\pm$								++	STAGE	3
4	39		SPACE					+	+							30	3	SPD	4
t	41		SPACE			-	-												4
			.C. LOAD SU	MM A RY  Demand	NE	CSizin			ted			TRICAL	DATA	(VA/PH	IASE)	L	ocatio	PANEL INFORMATION n: REFER TO FLOOR PLAN.	
	Load	Types and Codes	(VA)	Factor		(VA				Tot	al Conr	. Load:	21	Amps		M	ountin	g: Surface Enclosure Type: Nen	na 1
-	Air	Conditioning (AC)	6989	1.00		698	9			NE	C Sizin	g Load:	8	KVA		Fe	ed From	m: REFER TO SLD ON DWG 50-E-131.	
		Heating (H)		1.00								g Load:		Amps			Equip	oment Ground Bus: Yes Bus Material: Cop	oper
	Kitc	hen Equipment (K)		1.00							Main D	io Cizo:	400	Amno.			Iso	olated Ground Bus: No Neutral Size: 10	0%
		Lighting (L)		1.00							wain Bu	ıs Size:	100	Amps					
	R	eceptacles (REC)	360	1.00		360	)				PANE	L LEGE	ND (ID)					PANEL NOTES	
		Existing (E)		1.00						ST -	Shunt-T	rip C.B.;	G - GFI	C.B.					
		Continuous (C)		1.00						"0		Lock-Or		on					
		n-Continuous (NC)	240	1.00		240	)					ntactor D Remodel:		on					
	Re	frigeration (REF)		1.00						N -	New C.I	B.; EX - E	Existing	C.B.					
	B	c. Load Totals:	7589			758	9	V	A										

	Panel Name: Panel Voltage:			e, 4 Wi	re			Exi	sting P	anel			Main	ı Lu	ugs Only: No Main Breaker: 225 Panel A.I.C. Rating: 10k	
	#			В	reak	er	Load		Phase		Loa	ad	Breal	ker		#
D	Ckt #	Description		ī	Tr	ip Co	de VA	A	В	С	VA	Code	Trip	Р		CKt #
X	3 5	SPARE		3	10	00							100	3	SPARE 4	2 4 6
X	7 9 11	SPARE		3	2								20	3	SPARE 1	0
X	13 15 17	SPARE		3	2								20	2	SPARE 1	6
X		ACLE FOR 1	11-CP-1	-	2	) RE	C 18	0 180					25	2		20
		CLE NEAR 11	1-AHU-25		2	RE	C 18	0	180				25	2		2
X	23	SPARE		-	2	)							20			
	25	1-A HU-208 *		0.			36		0.00				20			26
N	27	ATTIC EAST			1	5 A	36		360	360			20	100		8 0
-	29 31	1771-1-1-1-1-1-1-1-1-1-1-1-1-1-1-1-1-1-			+		180			300			20			2
N	33	111-CU-25 *	1000		2	5 A			1801			-	20	1		4
	35 EXTE	RIOR - NORT	TH11				180			1801			20	1	100000000000000000000000000000000000000	6
	37	1.5.2											20	1	SPARE 3	8
N	39	SPD*		3	3	0	10		0			1	20	1		10
	41					4							20	1	SPARE 4	2
				Tot	al Co	nnec	ed Lo	ad 2342			(VA/Ph	HASE)				_
	N.E	.C. LOAD SU							TRICAL	30					PANEL INFORMATION	
	Load Types and Codes	Total Load		NEC Sizin		id		Total Con			KVA				tion: MECH ROOM 27	
		(VA)	Factor	(VA	_			Total Con		***************************************	Amps			ount		
	Air Conditioning (AC)	6485	0.75	486	4			NEC Sizir			KVA		Fe		rom: PANEL 111-ECB-1 VIA OVERHEAD TRANSFORMER	
	Heating (H) Kitchen Equipment (K)		1.00					NEC Sizir	ng Load	: 14	Amps				uipment Ground Bus: Yes Bus Material: Copper solated Ground Bus: No Neutral Size: 100%	
	Lighting (L)		1.00					Main B	us Size	250	Amps			L.	Solated Ground Bus. No Neutral Size. 100%	
	Receptacles (REC)	360	1.00	360	)			PAN	EL LEGE	ND (ID)		1			PANEL NOTES	
	Existing (E)		1.00				S	T - Shunt-			C.B.		SOU	JARI	E D NQ	
	Continuous (C)		1.00					LB -	"Lock-O	n" C.B.					NOTED IN BOLD ARE NEW WORK. REUSE EXISTING	
	Non-Continuous (NC)		1.00					"C1" - Co	ntactor E -Remodel		on				T BREAKER, UNO.	
	Refrigeration (REF)		1.00				1	N - New C.			C.B.		* - P	PRO	VIDE NEW BREAKER INPLACE OF EXISTING BREAKER(S).	
	Bec. Load Totals:	6845		522	4	V	A									

		nel Name: anel Voltage:			se, 4 \	Wire	е			Exis	sting P	anel			Main	ı Lu	ugs Only: <b>No</b> Main Breaker: <b>225</b> Panel A.I.C. Rating: 10k		
ID	Ckt #	ı	Description				aker		oad		Phase		Lo		Brea		Description	Ckt #	1
			100			P	Trip	Code	VA	Α	В	С	VA	Code	Trip	Р			-
EX	3		SPARE			3	100	13						-	100	3	SPARE	4	
_^	5		SFARL			3	100	73.3						1	100	3	SPARL	6	
+	7																	8	_
EX	9		SPARE			3	20								20	3	SPARE	10	
	11						- 2										100000	12	
	13		Salara I												20	2	SPARE	14	
EX	15		SPARE			3	20								20	-	OTAILE	16	
	17 19	DECEDI	ACLE FOR 1	44 CD 4		1	00	DEC	400	180					25	2	SPARE	18 20	ı
EX EX	21		CLE NEAR 11			1	20	REC	180	100	180								
_^ =X	23	NECE TAC	SPARE	11-A110-20		1	20	INLO	100		100			1	25	2	SPARE	22 24	1
	25					÷			360	360					20	1	SPARE	26	
N	27		1-AHU-208* ATTICEAST			3	15	AC	360		360				20	1	SPARE	28	
	29		AT HC EAST						360			360			20	1	SPARE	30	
	31	1.00	111-CU-25 *				1		1801	1801					20	11.	SPARE	32	
N	33		RIOR - NOR			3	25	AC	1801		1801				20	1	SPARE	34	
_	35		- 11 T DE			_			1801			1801			20	1	SPARE SPARE	36 38	
N	37 39		SPD*			3	30	1.3					-		20		SPARE	40	
"	41		Si D			ľ	30								20		SPARE	42	
	3.5					ra tal	C		d Load	0240	2342	0460	(VA/PI	IACE					_
		NE	.C. LOAD SU	IMMADV		TOtal	Com	1	Loau		TRICAL		(VA/PI	1ASE) 1			PANEL INFORMATION		1
		, i.c	Total Load	Demand	NEC S	izina	Load		Tot		1. Load:		KVA		1.	onat	ion: MECH ROOM 27		1
	Load Ty	ypes and Codes	(VA)	Factor		(VA)			100		i. Load:		Amps			ount		a 1	w
	Air Co	onditioning (AC)	6485	0.75		1864					g Load:	······	KVA				rom: PANEL 111-ECB-1 VIA OVERHEAD TRANSFORI		
		leating (H)	0.00	1.00		.001					g Load:						ipment Ground Bus: Yes Bus Material: Copp		
		n Equipment (K)		1.00												-	solated Ground Bus: No Neutral Size: 100		
	L	ighting (L)		1.00	·			-		Main Bu	ıs Size:	250	Amps				A		-
	Rece	eptacles (REC)	360	1.00	***************************************	360				PANE	1 LEGE	ND (ID)					PANEL NOTES		
	E	existing (E)		1.00	***************************************				ST -	Shunt-T	rip C.B.;	G - GFI	C.B.	1	SQL	JARI	ED NQ		1
		ntinuous (C)		1.00					112		Lock-On				ITE	MS N	NOTED IN BOLD ARE NEW WORK. REUSE EXISTING		
	Non-C	ontinuous (NC)		1.00					"(	7" - Cor	ntactor D	es ignatio	on		CIP	CLILL	FBREAKER, UNO.		

3/4" CONDUIT. MAKE FINAL CONNECTIONS.

1. REFER TO SHEETS E-001 AND E-002 FOR ABBREVIATIONS, SYMBOLS AND NOTES.

2. <u>BREAKERS FOR EXISTING PANELS:</u> NEW BREAKERS PROVIDED IN EXISTING PANELS SHALL BE COMPATIBLE WITH THE EXISTING PANEL AND SHALL HAVE THE SAME AIC

3. <u>HEAT TRACE CONTROL PANEL BRANCH CIRCUIT:</u> PROVIDE 30mA GROUND FAULT PROTECTION RATED BREAKER.

RATING AS THE EXISTING PANEL. UPDATE PANELBOARD SCHEDULE. EXISTING BREAKERS REMOVED FROM PANELS SHALL BE TURNED OVER TO VA COR.


4. <u>SURGE PROTECTION DEVICE (SPD):</u> FOR PANELS NOTED WITH A NEW SPD, THE CONTRACTOR SHALL PROVIDE A SPD IN NEMA 1 ENCLOSURE BELOW OR ADJACENT TO ASSOCIATED PANEL. PROVIDE WITH INDICATED BREAKER AND (3)#10 + (1)#10G IN

		Panel Name: Panel Voltage:			se, 4	Wir	е			Exis	ting Pa	anel			Mair	LU	ugs Only: Main Breaker: <b>90</b> Panel A.I.C. Rating: 22k		
ın	#		Description			Bre	eakei	L	oad		Phase		Lo	ad	Brea	ker	Description	#	T.,
ID	Ckt #		Description			Р	Trip	Code	VA	Α	В	C	VA	Code	Trip	Р	Description	Ckt #	Ш
	1		SPARE							1900			1900	С	20	1	49-H-14 (RM 14) - HUMIDIFIER	2	1
	3	-	SPACE								506		506	NC	20	1	49-P-1 (MECH 6)	4	
	5	A.A.	SPACE									120	120	NC	20	1	49-CP-2 (A TTIC)	6	1
	7		1.7 - 7							120			120	NC	20	1	49-CP-1 (MECH 6)	8	1
EX	9		SPD			3	30				120		120	NC	20	1	49-CP-3 (RM 14C)	10	1
	11											720	720	REC	20	1	RECPT - RM 6, RM 14, RM 14C, ATTIC	12	1
	13									262.5			262.5	Н	20	1	HEAT TRACE CONTROL PANEL 49-HT-001 (30m A)	14	(
	15														20	1	SPARE	16	1
	17	17				1											SPACE	18	
	19					-1											SPACE	20	
	21															1	SPACE	22	
	23													100			SPACE	24	Г
	25													-			SPACE	26	Г
	27																SPACE	28	Г
	29								1								SPACE	30	
EX	31	AHU	S1E LIGHTS 8	& REC		1	20	REC	360	360							SPACE	32	
EX	33	AHU	S2E LIGHTS 8	& REC		1	20	REC	360		360						SPACE	34	Г
EX	35	JOHNSON CON	NTROL PANEL	S EAST AT	TIC	1	20	С	360			360					SPACE	36	
EX	37	AHU	S1W LIGHTS 8	& REC		1	20	REC	360	1540			1180	REC	20	1	PENTHOUSE REC & WINDOW EXHAUST FAN	38	E
	39	AHU	S2W LIGHTS 8	& REC		1	20	REC	360		720		360	L	20	1	PENTHOUSE LIGHTS	40	
EX	41	JOHNSON CON	NTROL PANEL	S WEST AT	TIC	1	20	С	360			540	180	REC	20	1	REC ON NORTH EXTERIOR OF PENTHOUSE	42	E
						Total	Con	necte	d Load	4183	1706	1740	(VA/PI	(ASE)					
		N.E	EC. LOAD SU	IMMARY						ELECT	RICAL	DA TA					PANEL INFORMATION		
		I.T	Total Load	Demand	NEC	Sizing	Load	Ī	То	tal Conn	Load:	8	KVA		L	ocat	tion: PENTHOUSE		
	Load	Types and Codes	(VA)	Factor		(VA)			To	tal Conn	Load:	21	Amps		M	ount	ting: Surface Enclosure Type: Nema 1	1	***
	Δir	Conditioning (AC)		1.00				_	NI	EC Sizing	Load:	8	KVA		Fe	d Fr	rom: PANEL 49EQA-1 VIA 30KVA XFMR 49EQA		
	711	Heating (H)	263	1.00		263	••••••	•••		EC Sizing			Amps				uipment Ground Bus: Yes Bus Material: Copper	r	w
	Kito	hen Equipment (K)	200	1.00	***************************************					LO OIZING	Loud.						solated Ground Bus: No Neutral Size: 100%		~
	TAILO	Lighting (L)	360	1.00		360				Main Bu	s Size:	100	Amps				Neutral Size. 100%		
	Re	eceptacles (REC)	3520	1.00		3520	······			PANEL	LEGEN	ID (ID)		1			PANEL NOTES		1
		Existing (E)	0020	1.00		0020			0.7						501				1
		Continuous (C)	2620	1.00		2620			SI -	Shunt-Tr	ıp C.B.; ∟ock-On		C.B.				E D NQ		
		n-Continuous (NC)	866	1.00	***************************************	866			"	C1" - Cont	tactor De	esignati	on		ITE	VIS I	NOTED IN BOLD ARE NEW WORK.		
		frigeration (REF)		1.00						R	emodels	<b>;</b>							
									N -	New C.B	.; <b>EX</b> - E	xisting	C.B.						
	Be	c. Load Totals:	7629			7629		VA											

		Panel Name: Panel Voltage:			se,	4 Wi	re			Б	cisting F	Panel			Mair	ı Lu	gs Only: Yes Main Breaker:  Panel A.I.C. Rating: 22k		
ID	#		Description			В	reak	r	Load		Phase		Lo	ad	Brea	ker	Description	#	Τ
ייו	Ckt #		Description			F	Tri	p Co	de V	A A	В	C	VA	Code	Trip	Р	Description	Ckt	
EX	1		17M RECPT			1	20						942.9				51-CU-160*	2	
EX	3		17M RECPT			1	20				2023		942.9		25	3	(GRADE)	4	_
EX	5		7H, 17G RECF			1	20					2023	942.9					6	_
EX	7		, 17E, 17F RE			1	20						942.9		0.00		51-CU-244*	8	_
EX	9	17A,	, 17B, 17C RE	CPT		1	20				2023		942.9		25	3	(GRADE)	10	
EX	11		23 RECPT			1	20					2023	942.9					12	
EX	13		23C, 23D, RE			1	20	100					528	NC	15	1	51-P-1 (HOT WATER PUM P 51-A HU-160)*	14	_
EX	15		17 FRIDGE RE	450.00		1	20				1620		120	NC	20	1	51-CP-1	16	
EX	17		K RM 17M RE				20					1080			20	1	SPARE	18	
EX	19	DES	SK RM 23 REC	CPI		1	20	RE							20	1	SPARE	20	
	21		51-AHU-244*						221		443.7		221.9				51-AHU-160*	22	
N	23		(ATTIC)			3	18	A				443.7	221.9		15	3	(SOILED LINEN)	24	
<u>-</u>	25						0.0	1	221		/		221.9					26	
EX	27	51	-CP-2 (ATTI	C)		1	20	-	C 12	0	1120		1000	NC	20	2	HEAT TRACE CKT 1 AND 2 (30 m A) *	28	_
EX	29		SPARE			_ !	20	_	_			1000	1000		200	4	STORAGE 22	30 32	
EX EX	31		SPARE				20	_	_	_		-	-		20	1	SPARE SPARE	34	_
EX	35		SPARE SPARE				20	_					-		20	1	SPARE	36	
EX	37		SPARE				20	_	-				-		20	-	SPARE	38	
	39		SFARL			- 1	21	_				-	-	1	30	3	SPD*	40	_
EX	41		SPARE			2	20	)	+					+	00	3	31 5	42	
						Tot	al Co	nnec	ted Lo	ad 717	8 7230	6570	(VA/Pl	HASE)					Ī
		N.E	.C. LOAD SU	IMMARY						ELE	ECTRICAL	DATA					PANEL INFORMATION		
		-d.Td O-d	Total Load	Demand	NE	C Siz in	g Loa	d		Total Co	nn. Load	: 21	KVA		L	ocati	on: REFER TO FLOOR PLAN.		_
	LO	ad Types and Codes	(VA)	Factor		(VA	.)			Total Co	nn. Load	: 58	Amps		M	ounti	ng: Surface Enclosure Type: Nem	ia 1	w
	A	ir Conditioning (AC)	6989	1.00		698	9			NEC Siz	ing Load	: 21	KVA		Fe	ed Fro	om: EX FEEDERS AND CONDUIT(S).	***************************************	ww.
		Heating (H)		1.00							ing Load		Amps				ipment Ground Bus: Yes Bus Material: Cop	per	
	Ki	tchen Equipment (K)		1.00													colated Ground Bus: No Neutral Size: 100		
		Lighting (L)		1.00						Main	Bus Size	: 100	Amps				SOMEONIUM CONTRACTOR C		
		Receptacles (REC)	9720	1.00		972	0			PA	NEL LEGE	END (ID)		1			PANEL NOTES		T
		Existing (E)		1.00					9		t-Trip C.B.		CB	1	SOI	IADE	DNQ		1
		Continuous (C)		1.00					"		- "Lock-O		U.D.				IOTED IN BOLD ARE NEW WORK. REUSE EXISTING		
	N	on-Continuous (NC)	4268	1.00		426	8				Contactor	_	ion				BREAKER, UNO.		
		Refrigeration (REF)		1.00							Remode C.B.; EX -		СВ				IDE NEW BREAKER INPLACE OF EXISTING BREAKER	R(S).	
		∃ec. Load Totals:	20977			2097	77	v			J.D., D.	Laboring	J. <b>J</b> .						
		Tec Load Lotals'	/114//			71147		1 V	<b>■</b>					1	1				- 1

		Panel Name: Panel Voltage:			se, 4	Wir	е			Exis	ting P	anel			Mail		gs Only: No Main Breaker: 250 Panel A.I.C. Rating: 100k	
ID	Ckt #		Description				eaker	L	oad		Phase		Lo	ad	Brea	ker	Description	Ckt #
ייי	ठ		Description			Р	Trip	Code	VA	Α	В	С	VA	Code	Trip	Р	Description	ŏ
EX	1		SPARE			1	20		1.45.	1500			1500	NC	20	1	DOMESTIC WATER HEATER CONTOL& CIRC PUMP	2
EX	3	DOC	R SECURITY	PNL		1	20	NC	300		500		200	NC	20	1	METER POWER	4
EX	5		SPARE			1	20					300	300	NC	20	1	JOHNSON CONTROL	6
EX	7		SPARE			1	20			300			300	NC	20	1	JOHNSON CONTROL	8
N	9	116-P-1 (HOT W	A STATE OF THE STA		106)	1	15	NC	528		528					1	SPACE	10
N	11	RECE	PT - 116-AHU	-106*		1	20	REC	180			180				1	SPACE	12
	13		16-A HU-106*						360	2162			1801	1.			116-CU-106*	14
N	15		ENT CRAWL	SPACE)		3	15	AC	360		2162		1801	AC	25	3	(GRADE)	16
	17								360			2162	1801				(0.1.24)	18
N	19	116-CP-1 (BA		WL SPAC	E)*	1	15	NC	120	120						1	SPACE	20
EX	21		SPACE			1										1	SPACE	22
EX	23		SPACE			1						-1-4				1	SPACE	24
EX	25		SPACE			1		(1 = 1								1	SPACE	26
EX	27		SPACE	<u></u>		1										1	SPACE	2
EX	29		SPACE			1										1	SPACE	3
EX	31		SPACE			1		<b>C</b> = 1						17-2		1	SPACE	3
EX	33		SPACE			1							11			1	SPACE	34
EX	35		SPACE			1										1	SPACE	36
EX	37		SPACE			1											5,25,0	38
EX	39		SPACE			1									30	3	SPD*	4
EX	41		SPACE			1		i de l										4
						Tota	Con	necte	d Load	4082	3190	2642	(VA/PH	HASE)				
		N.E	.C. LOAD SU	MMARY						ELEC	TRICAL	DATA					PANEL INFORMATION	
	Load	Types and Codes	Total Load	Demand	NEC S	izing	Load		Tot	al Conn	. Load:	10	KVA		L	ocati	on: REFER TO FLOOR PLAN.	
	Loud	Types and codes	(VA)	Factor		(VA)			Tot	al Conn	. Load:	28	Amps		Me	ounti	ng: Surface Enclosure Type: Nema	1
	Air	Conditioning (AC)	6485	1.00		6485			NE	C Sizin	g Load:	10	KVA		Fe	d Fro	om: EX FEEDERS AND CONDUIT(S).	
		Heating (H)		1.00					NE	C Sizin	g Load:	28	Amps			Equ	ipment Ground Bus: Yes Bus Material: Coppe	er
	Kitc	nen Equipment (K)		1.00	,											Is	colated Ground Bus: No Neutral Size: 100%	0
		Lighting (L)		1.00						Main Bu	is Size:	250	Amps				NATIONAL	
	Re	ceptacles (REC)	180	1.00		180				PANE	L LEGE	ND (ID)		1			PANEL NOTES	
		Existing (E)		1.00					ST.	Shunt-T	rin C.B.	G - GEL	CB	1	SOI	IADE	DNQ	
	(	Continuous (C)		1.00					0,		Lock-On		O.D.				OTED IN BOLD ARE NEW WORK. REUSE EXISTING	
		-Continuous (NC)	3248	1.00		3248			"(	C1" - Con	tactor D	es ignatio	n				BREAKER, UNO.	
		frigeration (REF)		1.00					M	F New C.E	Remodels		B				IDE NEW BREAKER IN PLACE OF EXISTING BREAKER(	5).
		c. Load Totals:	9913			9913		VA	IV -	NOW U.L	, LA - L	Aisting (	J.U.					

TVDE	DIMENSIONS	DESCRIPTION	MOUNTING		LAMP	1	MATTAGE	VOLTAGE	DDIVED.	BASIS OF	DESIGN	DEMARKO
TYPE	DIMENSIONS	DESCRIPTION	MOUNTING	TYPE	LUMENS	COLOR	WATTAGE	VOLTAGE	DRIVER	MANUFACTURER	SERIES	REMARKS
A1		CLEANROOM-GRADE LED TROFFER. STEEL HOUSING WITH GASKETTED DOOR, IMPACT RESISTANT ACRYLIC LENS, 80 CRI, RATED FOR BSL-3 AND 4, IP-66	RECESSED	LED	6593	3500K	46	MVOLT	0-10V 10% DIM	KENALL	CSEDO	
A2		CLEANROOM-GRADE LED TROFFER. STEEL HOUSING WITH GASKETTED DOOR, IMPACT RESISTANT ACRYLIC LENS, 80 CRI, RATED FOR BSL-3 AND 4, IP-66	RECESSED	LED	5373	3500K	49	MVOLT	0-10V 10% DIM	KENALL	CSEDO	
C1	3 ///\range	MEDIUM BEAM, FLAT DIFFUSE ACRYLIC LENS WITH TONG HANGER AND WIREGUARD, 80 CRI	SURFACE	LED	2500	3500K	20	MVOLT	0-10V 10% DIM	LITHONIA	CLX	

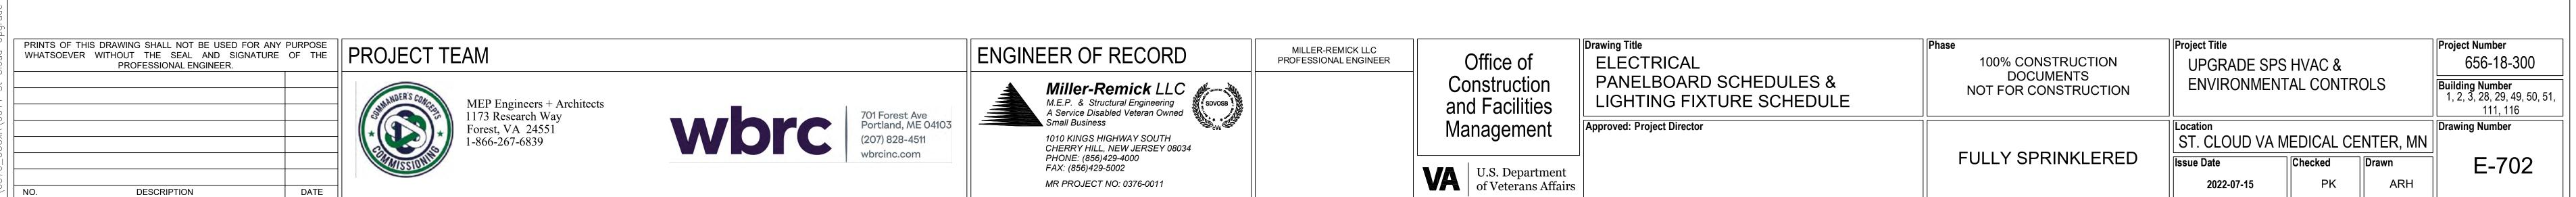

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