
SIOUX FALLS COURTHOUSE IRA WINDOW REPLACEMENT

CONTEX PHOTO

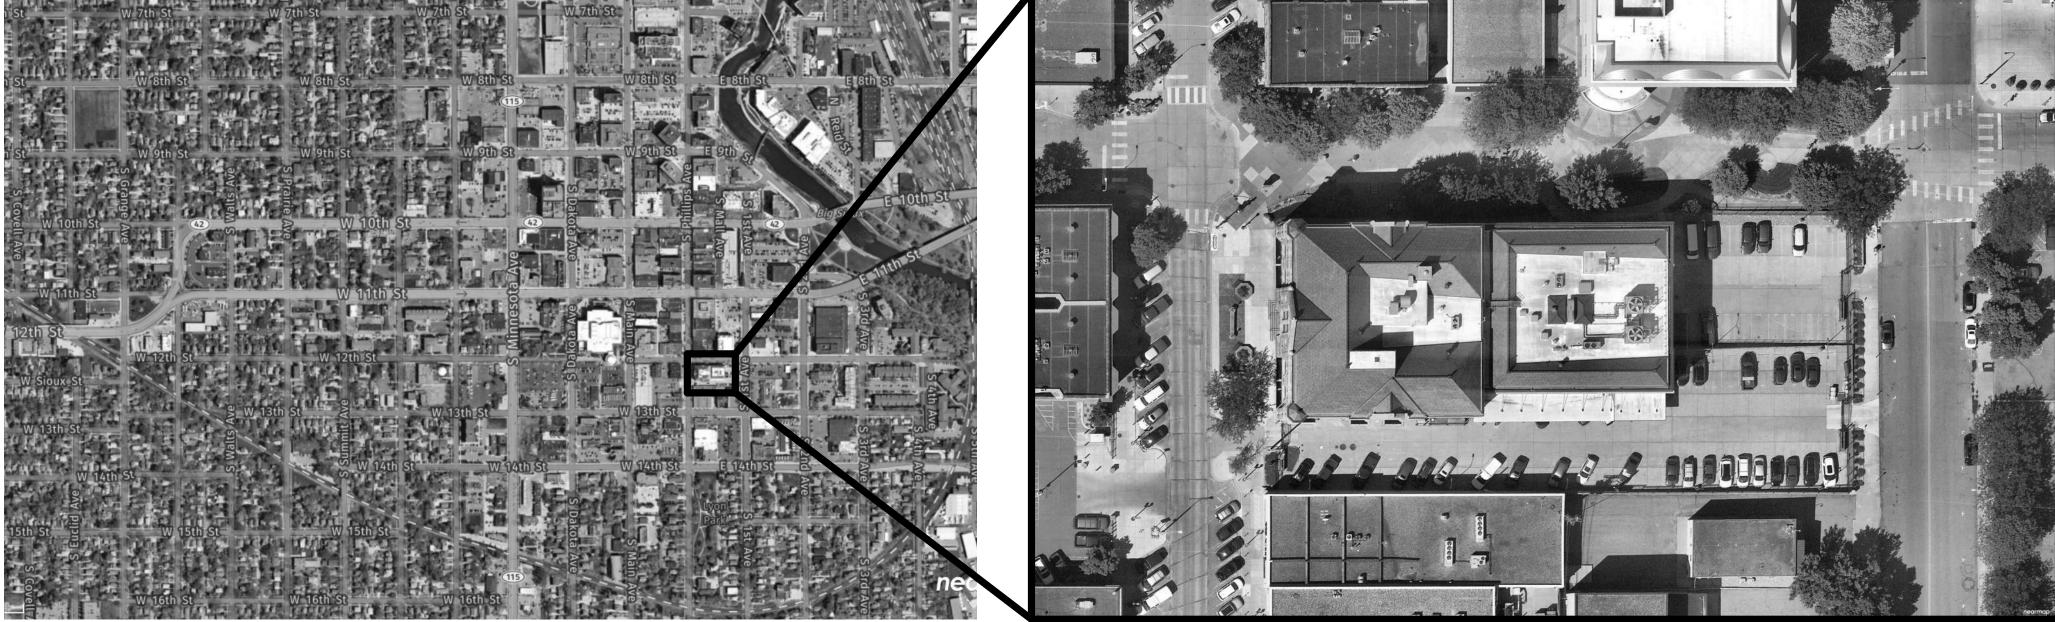

VICINITY MAP - NOT TO SCALE

ENLARGED SITE MAP - NOT TO SCALE

400 SOUTH PHILLIPS AVE SIOUX FALLS, SOUTH DAKOTA 57104



U.S. GENERAL SERVICES ADMINISTRATION, ROCKY MOUNTAIN REGION 8

400 SOUTH PHILLIPS AVE SIOUX FALLS, SOUTH DAKOTA 57104

SMITHGROUP

500 GRISWOLD SUITE 1700 DETROIT, MI 48226 313.983.3600 smithgroup.com

BID PACKAGE 2

ISSUED FOR: CONSTRUCTION SET

ISSUE DATE: 12/06/2024

13560.00

Sheet Number	Sheet Name							
GENERAL								
G0.1	PROJECT COVER SHEET							
ADOLUTEOTUDAL								
ARCHITECTURAL A0.2.1	ARCHITECTURAL ABBREVIATIONS & SYMBOLS							
A1.2.1	ARCHITECTURAL ABBREVIATIONS & STINBOLS ARCHITECTURAL EXISTING SITE PLAN - OVERALL							
A1.2.1	ARCHITECTURAL EXISTING SITE PLAIN - OVERALL							
AD4.2.1	DEMOLITION ELEVATIONS							
AD4.2.2	DEMOLITION ELEVATIONS							
AD4.2.3	DEMOLITION ELEVATIONS							
AD5.2.1	DEMOLITION WINDOW DETAILS							
AD5.2.2	DEMOLITION WINDOW DETAILS							
AD5.2.3	DEMOLITION WINDOW DETAILS							
AD5.2.4	DEMOLITION WINDOW DETAILS							
AD5.2.5	DEMOLITION WINDOW DETAILS							
AD5.2.6	DEMOLITION WINDOW DETAILS							
AD5.2.7	DEMOLITION WINDOW DETAILS							
AD5.2.8	DEMOLITION WINDOW DETAILS							
A4.2.1	EXTERIOR WINDOW TYPE SCHEDULE							
A4.2.2	WINDOW SCHEDULE							
A4.2.3	ELEVATIONS							
A4.2.4	ELEVATIONS							
A4.2.5	ELEVATIONS							
A4.2.6	ELEVATIONS							
A4.2.7	ENLARGED ELEVATIONS							
A4.2.8	ENLARGED ELEVATIONS							
A5.2.1	REPAIR DETAILS							
A5.2.2	REPAIR DETAILS							
A5.2.3	REPAIR DETAILS							
A5.2.4	REPAIR DETAILS							
A5.2.5	REFERENCE PHOTOS - WINDOWS							
A5.2.6	REFRENCE PHOTOS - WINDOWS							

MODULAR LAYOUT / DETAIL NUMBER ARCHITECTURAL ABBREVIATIONS ARCHITECTURAL GENERAL NOTES **DETAIL MODULE LAYOUT** THE FOLLOWING GENERAL NOTES APPLY TO ALL 2. EXCEPT WHERE DIRECTED TO PLACE ITEMS OF WORK AT ARCHITECTURAL SERIES SHEETS. FOR GENERAL NOTES THE APPROXIMATE LOCATIONS SHOWN, DO NOT SCALE DETAILS ARE NUMBERED ACCORDING TO THEIR APPLICABLE TO ALL SHEETS REFER TO THE "PROJECT DRAWINGS FOR DIMENSIONAL INFORMATION. ALL 66 | 58 | 50 | 42 | 34 | 26 | 18 | 10 LOCATION ON EACH SHEET AND ARE NOT GENERAL NOTES": ELEMENTS OF THE DRAWINGS MAY NOT BE DRAWN TO NUMBERED CONSECUTIVELY. EACH MODULE EXACT SCALE. ALL DIMENSIONS REQUIRED ARE SHOWN MAINTAINS THE NUMBER ASSOCIATED WITH IT ANCHOR BOLT QUARRY TILE OR MAY BE DERIVED FROM THOSE SHOWN ON THE FLOOR . THE ARCHITECTURAL SERIES SHEETS ARE PART OF A (67) (59) (51) (43) (35) (27) (19) (11) QTR QTY ACOUSTICAL CEILING TILE GAUGE, GAGE QUARTER PLANS, DETAIL PLANS, ELEVATIONS, SECTIONS, DETAILS, COMPLETE SET OF CONSTRUCTION DOCUMENTS QUANTITY THIS SYSTEM CAN BE APPLIED TO ANY SHEET ACP ACOUSTICAL CEILING PANEL GALLON DESCRIBING THE WORK FOR THIS PROJECT. USERS OF SCHEDULES, AND SPECIFICATIONS. |(68)|(60)|(52)|(44)|(36)|(28)|(20)|(12)| THAT CONTAINS MULTIPLE IMAGES. THE IMAGES GALVANIZED ACCESS PANEL THESE DOCUMENTS ARE RESPONSIBLE TO REVIEW ALL ARE NUMBERED ACCORDING TO THE MODULE AREA DRAIN GRAB BAR CONSTRUCTION DOCUMENTS TO UNDERSTAND AND |(69)|(61)|(53)|(45)|(37)|(29)|(21) SYSTEM SHOWN ILLUSTRATED TO THE LEFT GENERAL CONTRACTOR COORDINATE THE GRAPHIC AND ANNOTATED ADHESIVE GFRC GLASS FIBER REINFORCED CONCRETE INFORMATION PROVIDED IN THESE ARCHITECTURAL RISER EACH DETAIL MAY OCCUPY ONE OR MORE GFRG **ADJUSTABLE** GLASS FIBER REINFORCED GYPSUM 70)|(62)|(54)|(46)|(38)|(30)| SERIES SHEETS. RETURN AIR WHOLE MODULES. THE DETAIL MODULE IS USED ADJACENT GLASS RAD RADIUS TO ESTABLISH THE IDENTIFYING LABEL FOR ABOVE FINISH FLOOR GLU LAM GLUE LAMINATED RESILIENT BASE EACH DETAIL, NOT TO LIMIT THE SIZE OF THE ABOVE FINISH GRADE GLZ GLAZING RCP REFLECTED CEILING PLAN GRADE OR GRADING ABOVE FINISH SLAB RCPT RECEPTACLE AGGR GVL GRAVEL **AGGREGATE** ROOF DRAIN GYP GYPSUM RECTANGULAR GYP BD ALT ALTERNATE GYPSUM BOARD REFERENCE ANODIZED GYP PLAS GYPSUM PLASTER ANOD REFRIGERATOR **DETAIL NUMBERING EXAMPLE** APPROX APPROXIMATE(LY REGISTER ARCHITECT(URAL REINF REINFORCE (D) (ING) (MENT ASPH ASPHALT THE NUMBER OF THE MODULE WHICH REQD REQUIRED AVG AVERAGE OCCURS IN THE LOWER LEFT CORNER OF A REQUIREMEN^T SINGLE MODULE OR SEVERAL MODULES HOSE BIBB RESILIENT RESIL GROUPED TOGETHER WILL DEFINE THE FINAL HOLLOW CORE RETURN DETAIL NUMBER AS SHOWN IN THE REVISION ILLUSTRATION TO THE LEFT. ALTHOUGH THE HARDBOARD **BULLETIN BOARD** RESILIENT FLOORING MODULE NUMBERS OCCUR IN CONSECUTIVE HDW HARDWARE RIGHT HAND BOARD ORDER, NOT ALL NUMBERS ARE HDWD HARDWOOD ROUND HEAD MACHINE SCREW BETWEEN NECESSARILY USED ON EACH SHEET HGT HEIGHT ROUND HEAD WOOD SCREW BITUM BITUMINOUS **HOLLOW METAI** BLDG BUILDING HNDRL HANDRAIL ROUND **BENCHMARK** HORIZONTAL **ROUGH OPENING** HORIZ BASIS OF DESIGN HIGH POINT RIGHT OF WAY BOT BOTTOM HOUR RAIN WATER LEADER BOS **BOTTOM OF STEEL** 56 48 ARCHITECTURAL SYMBOL NOTES HEATING-VENTILATION-AIR CONDITIONING HVAC HOT WATER BASEMENT BUILT UP ROOFING SYSTEM SUPPLY AIR SPLASH BLOCK INSIDE DIAMETER THE PURPOSE OF THIS SHEET IS TO ILLUSTRATE AND CAB CB INCH SOLID CORE DEFINE TYPICAL GRAPHIC SYMBOLS WHICH MAY INCAND INCANDESCENT SCHEDULE CATCH BASIN TYPICALLY OCCUR ON THE ARCHITECTURAL DRAWINGS SCREEN CCR INCLUDE, INCLUDING SCRN CARD CONTROL READER STORM DRAIN CCT **CUBICLE CURTAIN TRACK** INFORMATION ADDITIONAL SYMBOLS NOT SHOWN OR DEFINED ON THIS SOUTHEAST INSUL INSULATION CCTV SHEET MAY BE USED ON THE ARCHITECTURAL INTR INTERIOR SECTION CG CORNER GUARD DRAWINGS AND ARE TYPICALLY DEFINED ON OTHER SEGMENT CEMENT, CEMENTITIOUS CEM INTRAVENOUS TRACK SEPARATION OR SEPARATE CER SEPARATION JOINT SYMBOLS ARE NOT DRAWN TO SCALE. TO DETERMINE **CHALKBOARD** SHEET, SHEETING THE ACTUAL SIZES OF ELEMENTS REPRESENTED BY CAST IRON SYMBOLS, REFER TO THE SPECIFICATIONS AND OTHER SHOWER **CONTROL JOINT** SHELVES, SHELVING **CENTER LINE** JAN SHEETS, AS MAY APPLY. CEILING JOIST JOINT CLR CLEAR SHEET METAL SCREW CMU CONCRETE MASONRY UNIT SPACE, SPACED, SPACING **SPECIFICATION** COLUMN SPRINKLER CONCRETE KILOGRAM SPEAKER SPKR CONF **CONFERENCE** KITCHEN SQUARE CONN CONNECTION KICK PLATE SANITARY SEWER CONSTR CONSTRUCTION KNEE SPACE SERVICE SINK CONT CONTINUOUS ARCHITECTURAL REFERENCE SYMBOLS STAINLESS STEEL CONTR CONTRACTOR STREET CORR STA STATION LENGTH, LONG CSK STAG STAGGERED COUNTERSUNK LAB LABORATORY SOUND TRANSMISSION COEFFICIENT STC COMBINATION STANDPIPE **BUILDING SECTION** REVISION NUMBER AND EXTENT STD STL STANDARD **CSWK** CASEWORK LAV LAVATORY WALL SECTION NUMBER STEEL CERAMIC TILE POUND STORAGE CU CUBIC LIGHT EMITTING DIODE STRUCT STRUCTURAL CW COLD WATER LINEAR FOOT STS SELF-TAPPING STEEL DIRECTION OF VIEW LENGTH SUSP SUSPENDED LINEAR SUSP CLG SUSPENDED CEILING LEAD LINED SVCE SERVICE SHEET WHERE DRAWN DEPTH LOW POINT SOUTHWEST SW DOUBLE DBL LIGHT SYMM SYMMETRICAL DBL ACT DOUBLE ACTING LT WT LIGHT WEIGHT SYST SYSTEM DEG DEGREE LTG LIGHTING DEMO DEMOLISH LOUVER SHEET KEYNOTE MARK DEPT DEPARTMENT DET DETAIL DRINKING FOUNTAIN WALL SECTION TREAD DIAMETER WALL SECTION NUMBER METERS TOP AND BOTTOM DIAG DIAGONAL MACHINE TONGUE AND GROOVE SHEET WHERE DRAWN DIFF MATERIAL TOP OF CONCRETE, TOP OF CURB DIMENSION MASTER ANTENNA TELEVISION SYSTEM TRENCH DRAIN REFERENCE KEYNOTE MARK DIM PT DIMENSION POINT MAXIMUM TELEPHONE DISP DISPENSER MACHINE BOLT DIRECTION OF VIEW TEMPORARY DIST DISTANCE MEDICINE CABINET THERM THERMAL DOWN MEDIUM DENSITY OVERLAY THICK, THICKNESS DRAIN MECH MECHANICAL THRESHOLD DOWNSPOUT THROUGH DSP DRY STANDPIPE 088000.A03 — MEMBRANE TMPD GL TEMPERED GLASS DRAPERY TRACK MFR MANUFACTURER TOP OF **EXTERIOR ELEVATION** DWG DRAWING MANHOLE TOP OF RAILING **DWGS** DRAWINGS ELEVATION NUMBER AND MINIMUM TOP OF STEEL MISCELLANEOUS TOT TOTAL MLDG MOLDING TOP OF WALL MILLIMETERS TOP OF PAVEMENT 061600 5/8" — **EXISTING** MASONRY OPENING TELEPHONE TERMINAL BOARD PLYWOOD EACH SHEET WHERE DRAWN MODULE, MODULAR TELEVISION EDR **EQUIPMENT DRAWING** MTD MOUNTED TYPICAL **DETAIL REFERENCE** EDGE GUARD MTG MOUNTING EIFS EXTERIOR INSULATION FINISH SYSTEM MATCH LINE REFERENCES MVBL MOVABLE ELEVATION MULL MULLION ELAST ELASTOMERIC MATCH LINE ELEC UNDER COUNTER ELECTRICAL REFER TO THE SHEET DETAIL NUMBER ELEV ELEVATOR UNDERWRITERS LABORATORIES SHEET A2.1.1 WHERE CONTINUATION IS **EMERGENCY** UNLESS OTHERWISE NOTED - SHEET WHERE DRAWN, NEW ENCLOSURE UPS UNINTERRUPTABLE POWER SUPPLY HYPHEN INDICATES DETAIL NOT APPLICABLE **ENGR** UTIL **ENGINEER** UTILITY ON SAME SHEET. NATURAL EOS EDGE OF SLAB NORTHEAST ELECTRICAL PANEL SHEET A2.1.2 NOT IN CONTRACT REFER TO THE SHEETS ELECTRICAL PANEL BOARD SHEET A2.1.1 EITHER SIDE OF THE ETHYLENE PROPYLENE DIENE MONOMER NUMBER **EPDM** VAC NOMINAL EQ VALVE BOX NOICE REDUCTION COEFFICIENT EQL SP EQUALLY SPACED VINYL COMPOSITION TILE NTS NOT TO SCALE EQUIP EQUIPMENT VERTICAL DRAWING TITLE SYMBOLS NORTHWEST EQUIV **EQUIVALENT** VEST VESTIBULE **ESCAL ESCALATOR** VERIFY IN FIELD SECTION DETAIL REFERENCE EST ESTIMATE(D) VITREOUS ELECTRIC WATER COOLER VENT PIPE EXC ON CENTER √ View Name EXCAVATED VOL VOLUME EXHAUST OVERALL VWC VINYL WALL COVERING SCALE: 1/8" = 1'-0" OUTSIDE DIAMETER EXPANSION ELEVATION NUMBER AND OFCI OWNER FURNISHED-CONTRACTOR INSTALLED EXPANSION JOINT DIRECTION OFOI OWNER FURNISHED-OWNER INSTALLED EXTERIOR OPP OPPOSITE SHEET WHERE DRAWN WEST ORD OVERFLOW ROOF DRAIN View Name_______BASIC DRAWING TITLE WITH OVHD OVERHEAD W/O WITHOUT OUNCE FACE TO FACE SCALE: 1/8" = 1'-0" WITH LINE W/W WALL TO WALL FIRE ALARM WATER CLOSET OR WALL COVERING FIRE ALARM STATION WD WOOD FLAT BAR INTERIOR ELEVATION REFERENCE WDW WINDOW FCU FAN COIL UNIT PUBLIC ADDRESS WIRE GLASS WGL FLOOR DRAIN PARTIAL View Name_ WHEELCHAIR FDC FIRE DEPARTMENT CONNECTION PARTICLEBOARD - ELEVATION NUMBER AND WIRE MESH SCALE: 1/8" = 1'-0" ONLY ONE PLAN EXISTS PRIVATE TELEPHONE EXCHANGE FOUNDATION DIRECTION OF VIEW WHERE OCCURS FEC FIRE EXTINGUISHER CABINET POUNDS PER CUBIC FOOT **WORKING POINT** FIRE EXTINGUISHER POUNDS PER CUBIC INCH WATER RESISTANT FINISH FACE PERFORATED WSCT WAINSCOT PERIM FIRE HOSE CABINET PERIMETER WSP WET STANDPIPE LAYOUT GRID LINES FIRE HOSE / FIRE EXTINGUISHER CABINET PERMANENT - SHEET WHERE DRAWN WEIGHT FLAT HEAD MACHINE SCREW PERP PERPENDICULAR WTHPRF WEATHERPROOF FLAT HEAD WOOD SCREW POINT OF INTERSECTION WTRPRF WATERPROOF FIRE HYDRANT WWF WELDED WIRE FABRIC WWM WELDED WIRE MESH ROOM NAME AND NUMBER Α PLAS PLASTER FLASH FLASHING PLBG PLUMBING FLEX **FLEXIBLE** FLUORESCENT PLF POUNDS PER LINEAR FOOT FLUOR PLYWD FO FACE OF PLYWOOD PNEU FOLDING SHOWER BENCH PNEUMATIC PANEL XFMR TRANSFORMER PNL FSTNR FASTENER PANEL BOARD FOOT, FEET PNL BD **WINDOW AND LOUVER TYPE MARK** PAINT FURN PORT PORTABLE FURNITURE FXTR FIXTURE YARD PUSH PLATE SEE CORRESPONDING PARTS PER MILLION NUMBER ON SCHEDULE PAIR PRCST PRECAST M-X SEE ASSEMBLY TYPE PREP PREPARATION FOR DETAILS. PREFAB **PREFABRICATION** PROJ PROJECT **LEVEL LINE** NORTH ARROW REFERENCES PROP PROPERTY POUNDS PER SQUARE FOOT NAME OF LEVEL POUNDS PER SQUARE INCH ____ SECOND LEVEL PARTITION PNEUMATIC TUBE STATION POLYVINYL CHLORIDE

SIOUX FALLS COURTHOUSE IRA WINDOW REPLACEMENT

400 SOUTH PHILLIPS AVE SIOUX FALLS, SOUTH DAKOTA 57104

SMITHGROUP

500 GRISWOLD SUITE 1700 DETROIT, MI 48226 313.983.3600 smithgroup.com

REVISION NUMBER - SEE

REVISION HISTORY ON

THE TITLE BLOCK OF

EXTENT OF CURRENT

SEE CORRESPONDING

REFERENCE OCCURS

THE FIRST SIX DIGITS

SPECIFICATION SECTION

FOLLOWING THE PERIOD

REPRESENT PARTICULAR

ITEMS OF THE SPECIFIED

THE TEXT IS THE PRODUCT

REPRESENT THE

THE CHARACTERS

EXAMPLE 1:

EXAMPLE 2:

MATCH LINE

DRAWING TITLE WHEN

ON THE DRAWING

NEW GRID

IDENTIFICATION

EXISTING GRID

PROJECT NORTH TRUE NORTH

- INDICATES HEIGHT

ABOVE PROJECT DATUM

IDENTIFICATION

DESCRIPTION

SHEET WHERE

NUMBERED KEYNOTE ON

EACH SHEET

CONSTRUCTION SET <u>5 12/06/2024</u> 100% FINAL DESIGN SUBMITTAL 4 04/02/2024 95% PRE-FINAL DESIGN SUBMITTAL 3 12/26/2023 65% MID-POINT DESIGN SUBMITTAL 2 10/20/2023 35% CONCEPTUAL DESIGN SEALS AND SIGNATURES

REV DATE

ISSUED FOR

SHEET TITLE ARCHITECTURAL **ABBREVIATIONS & SYMBOLS**

13560.00 PROJECT NUMBER


PVG


PVMT

PAVING

PWR POWER


PAVEMENT

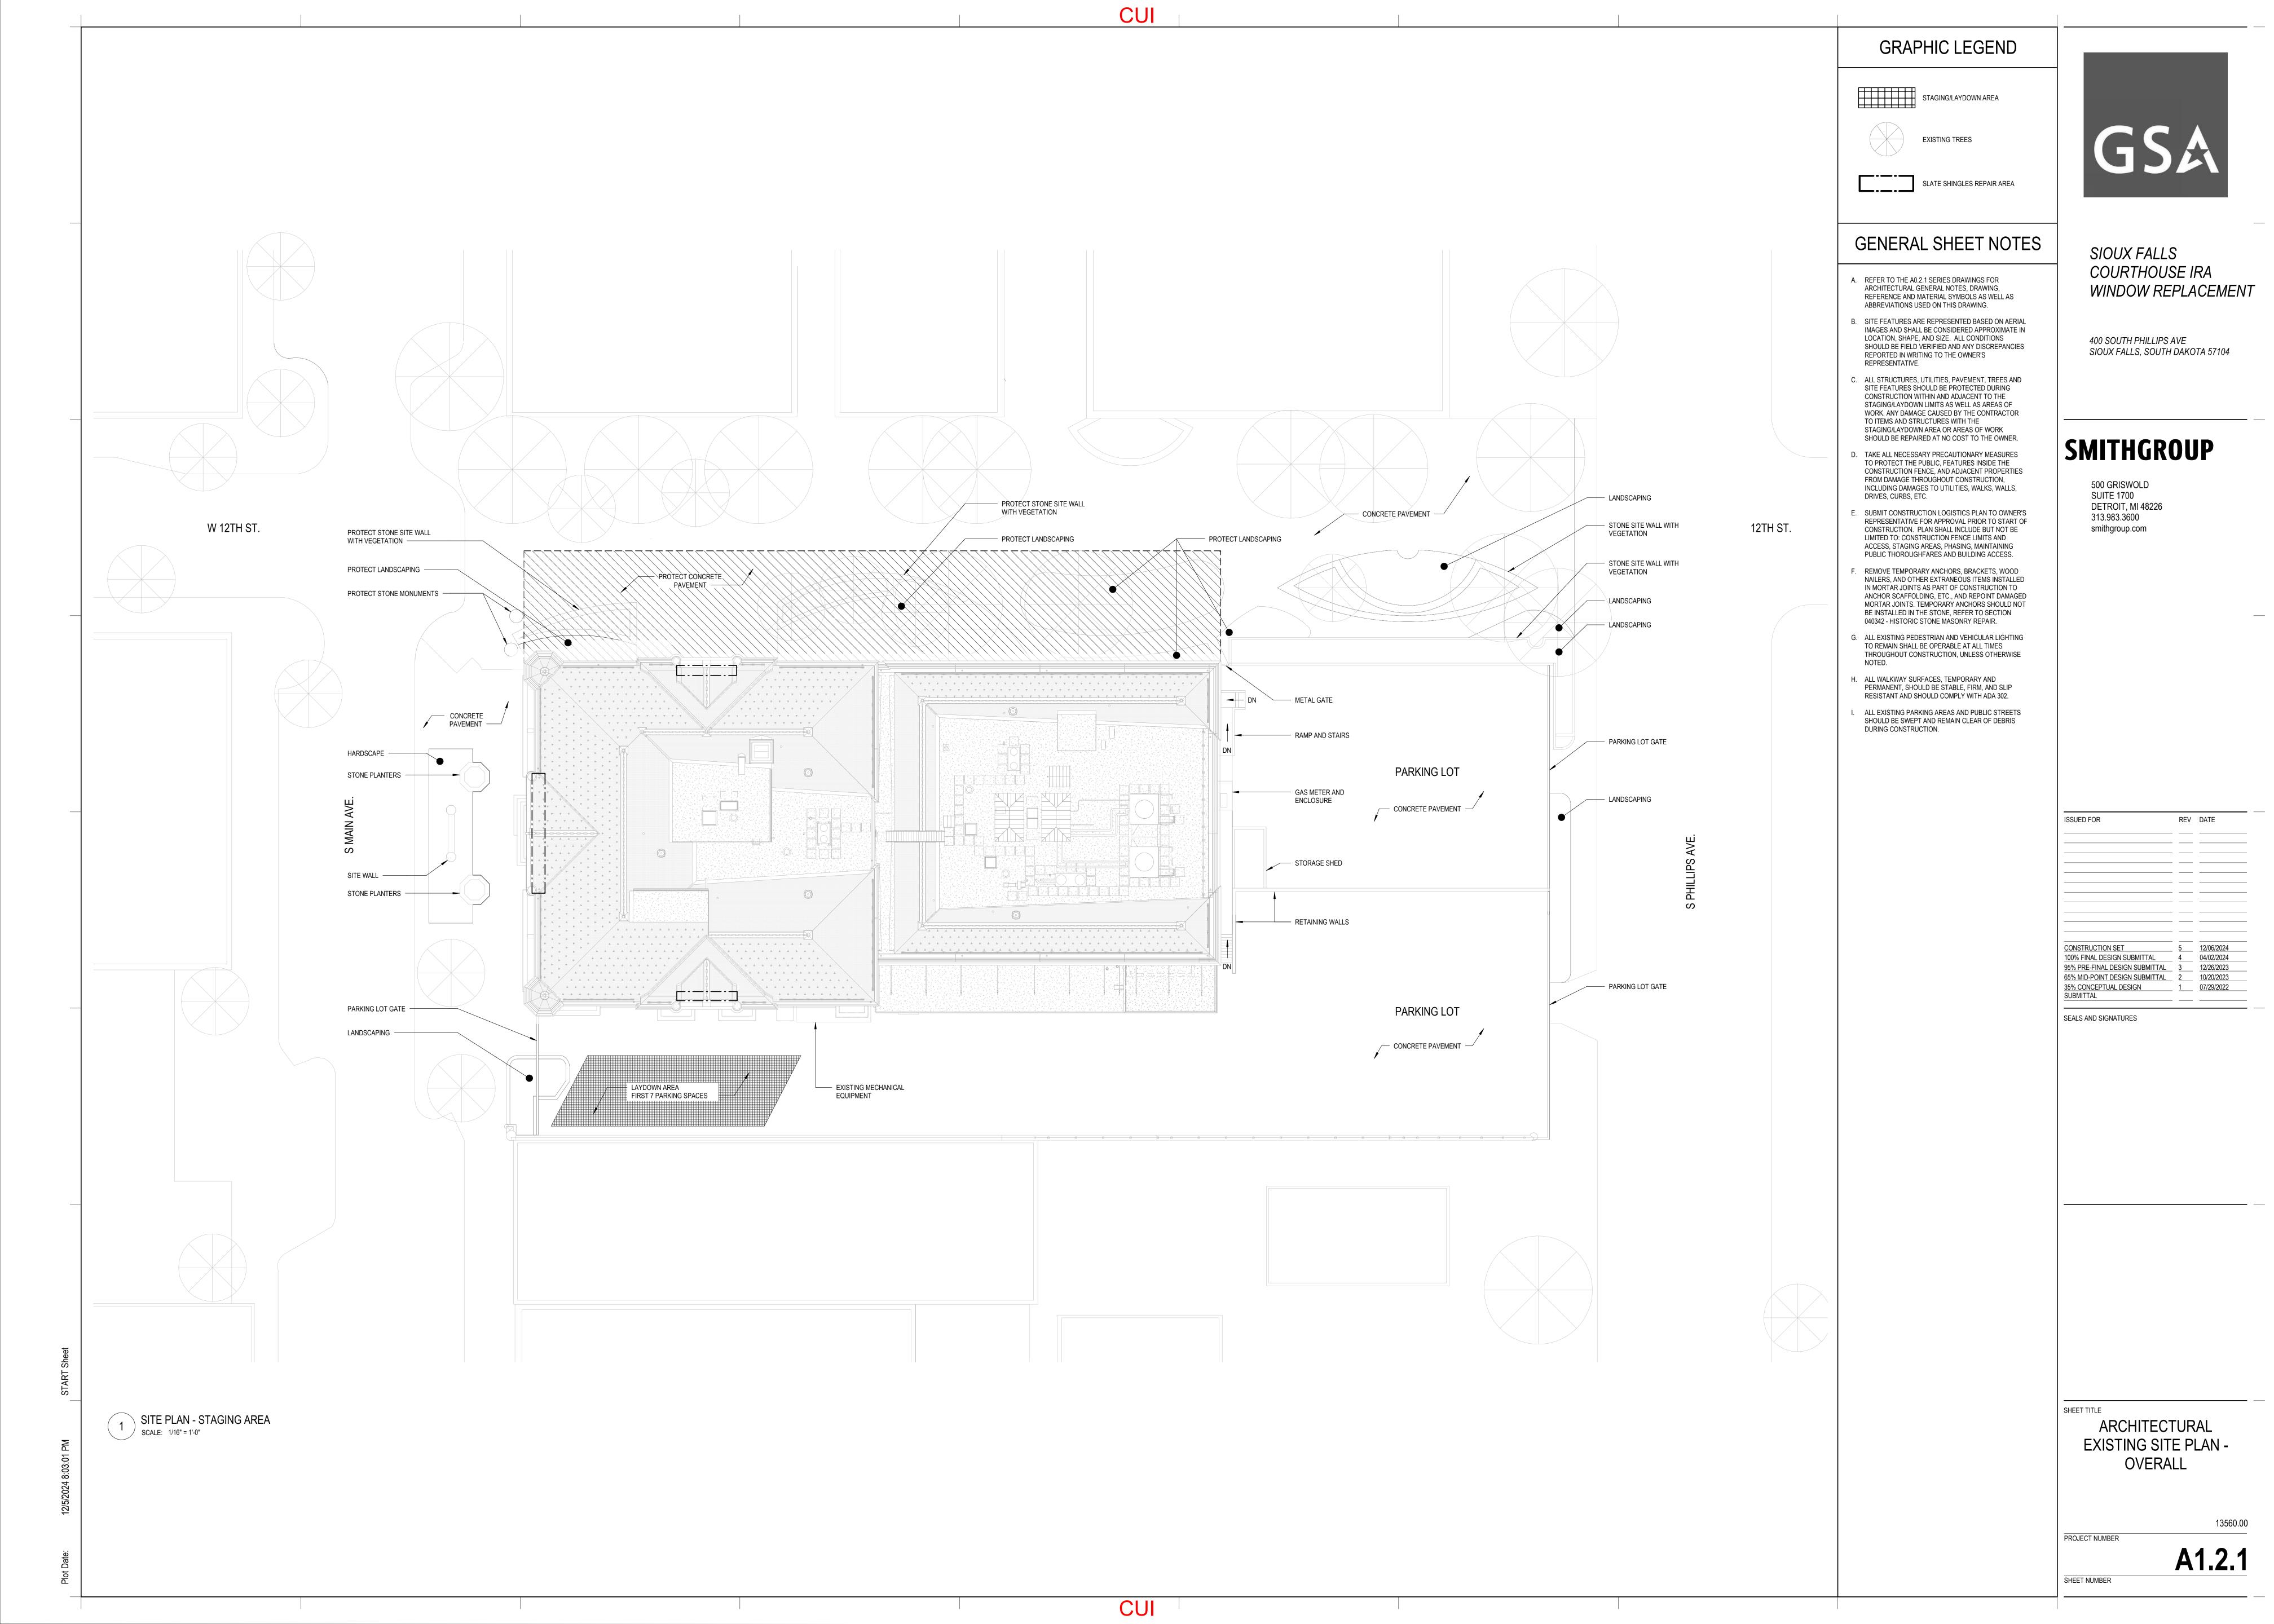


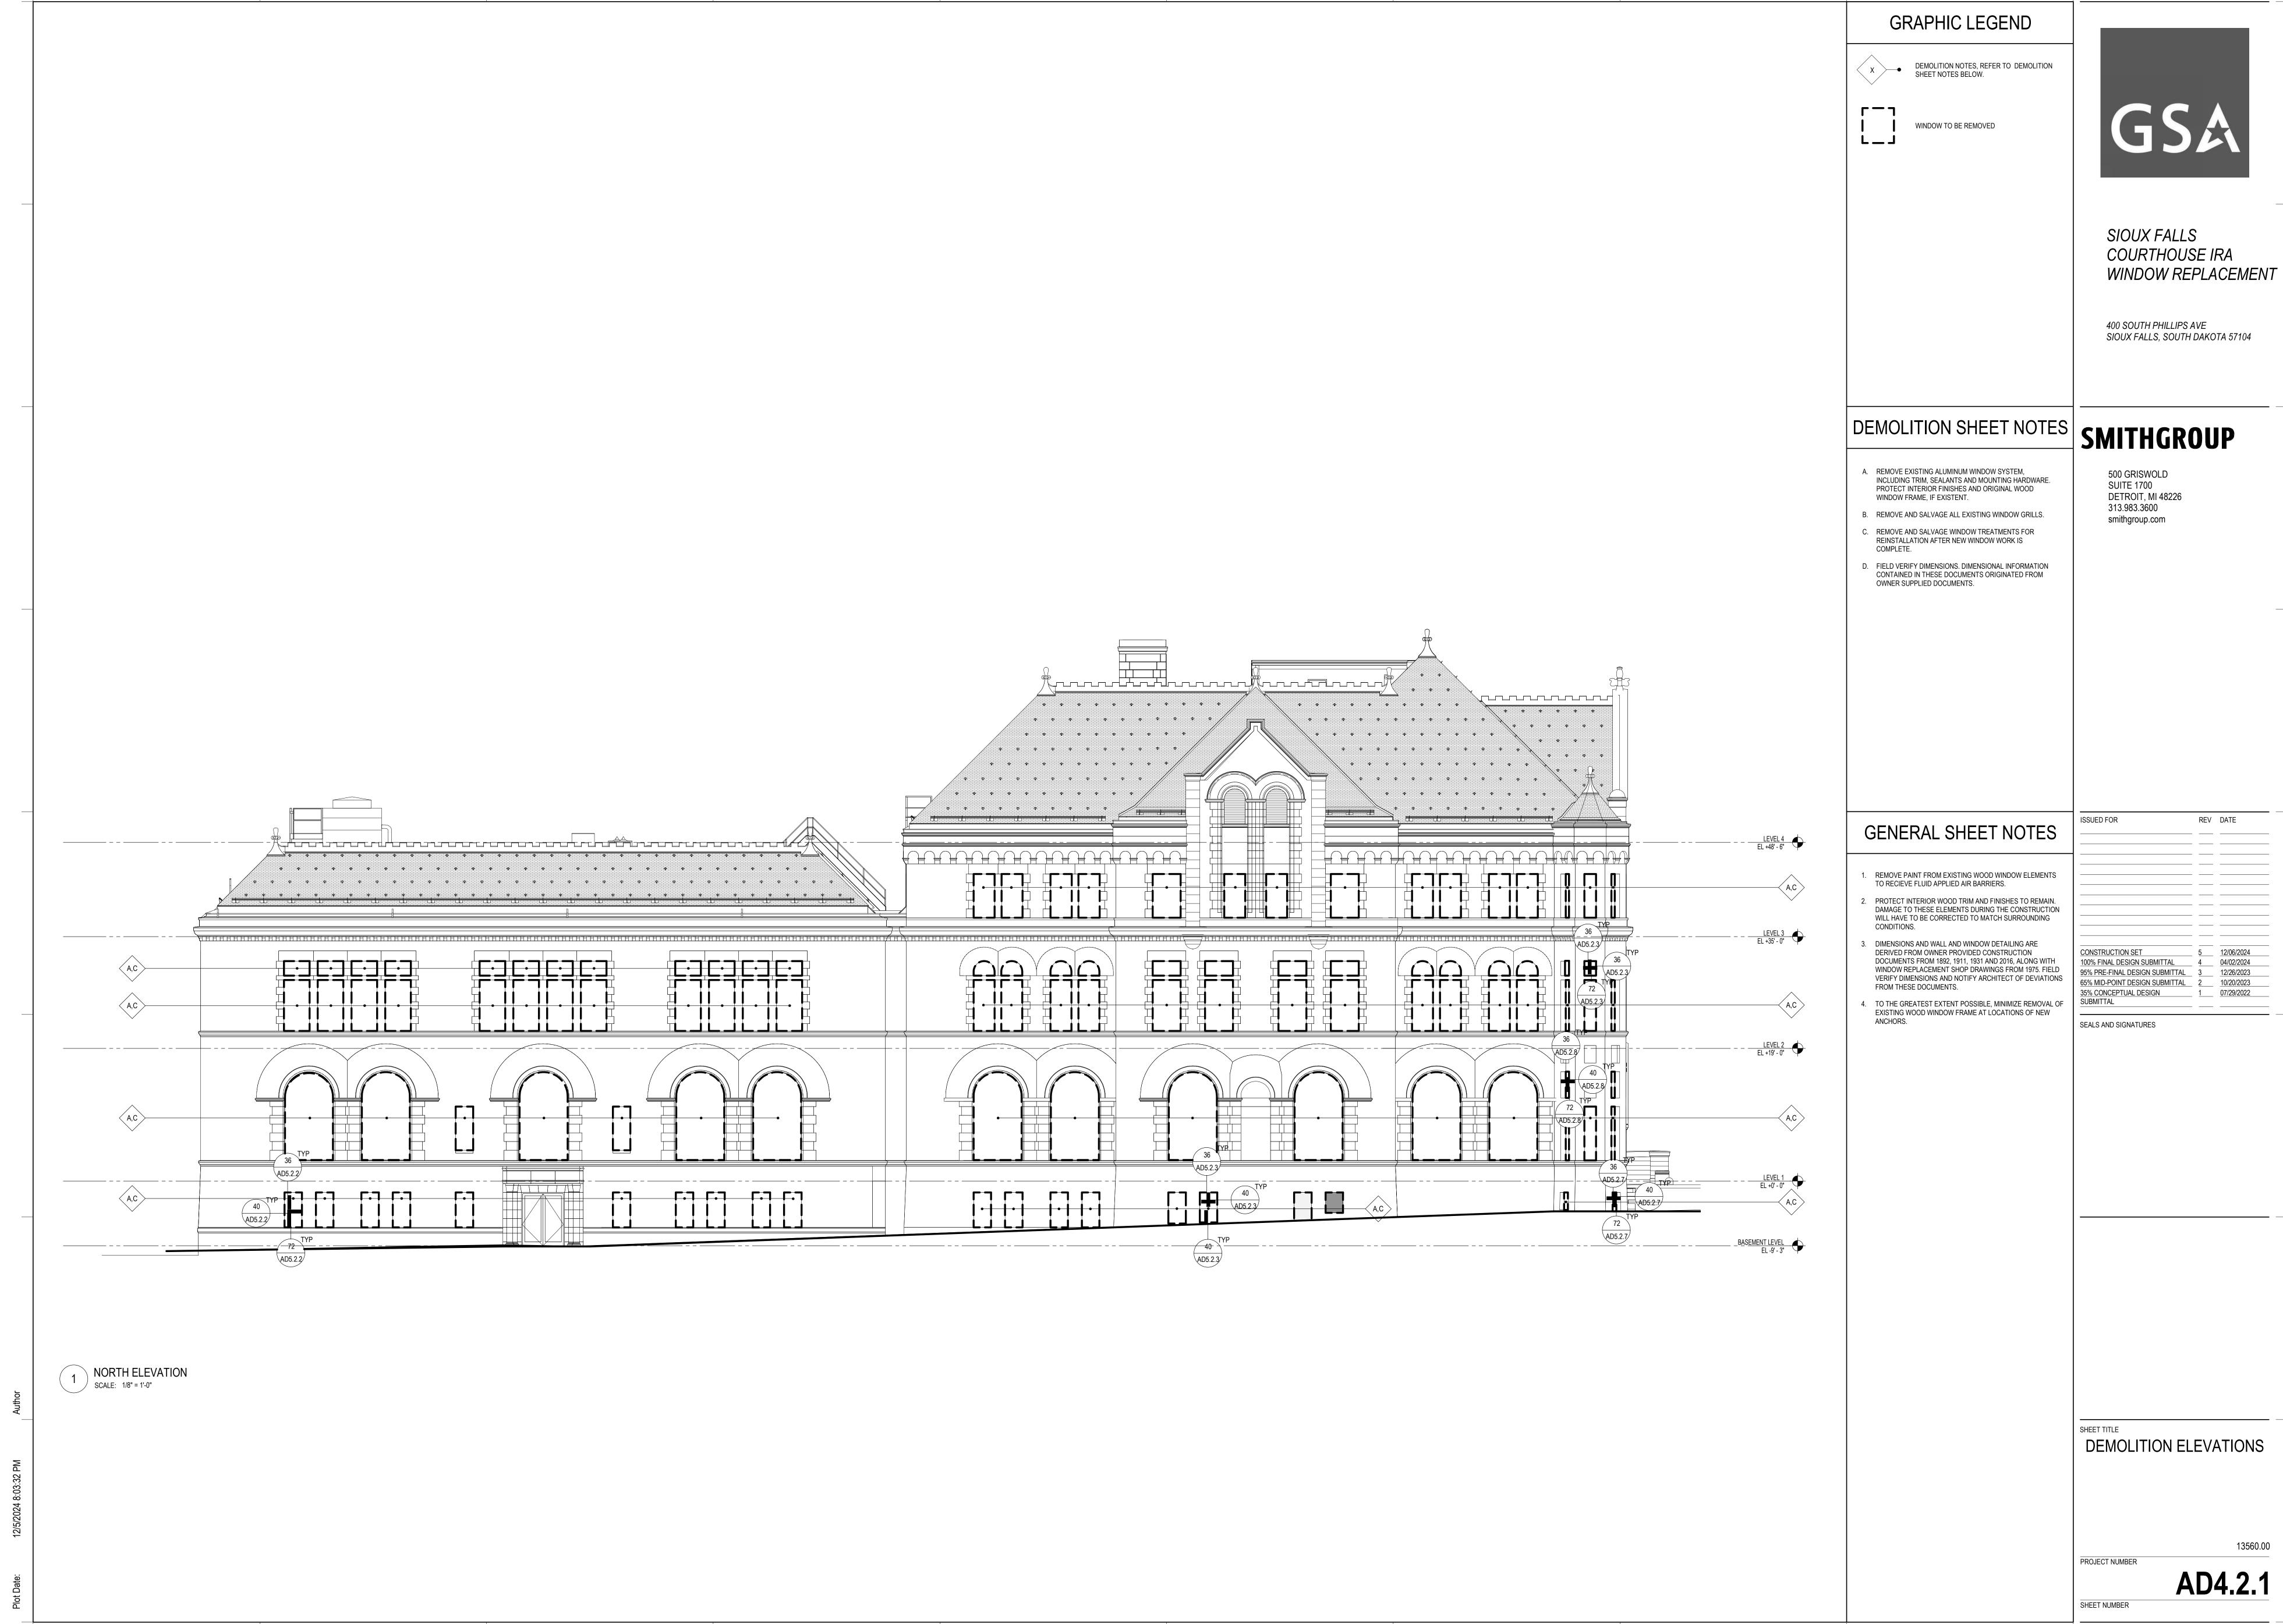



CUI


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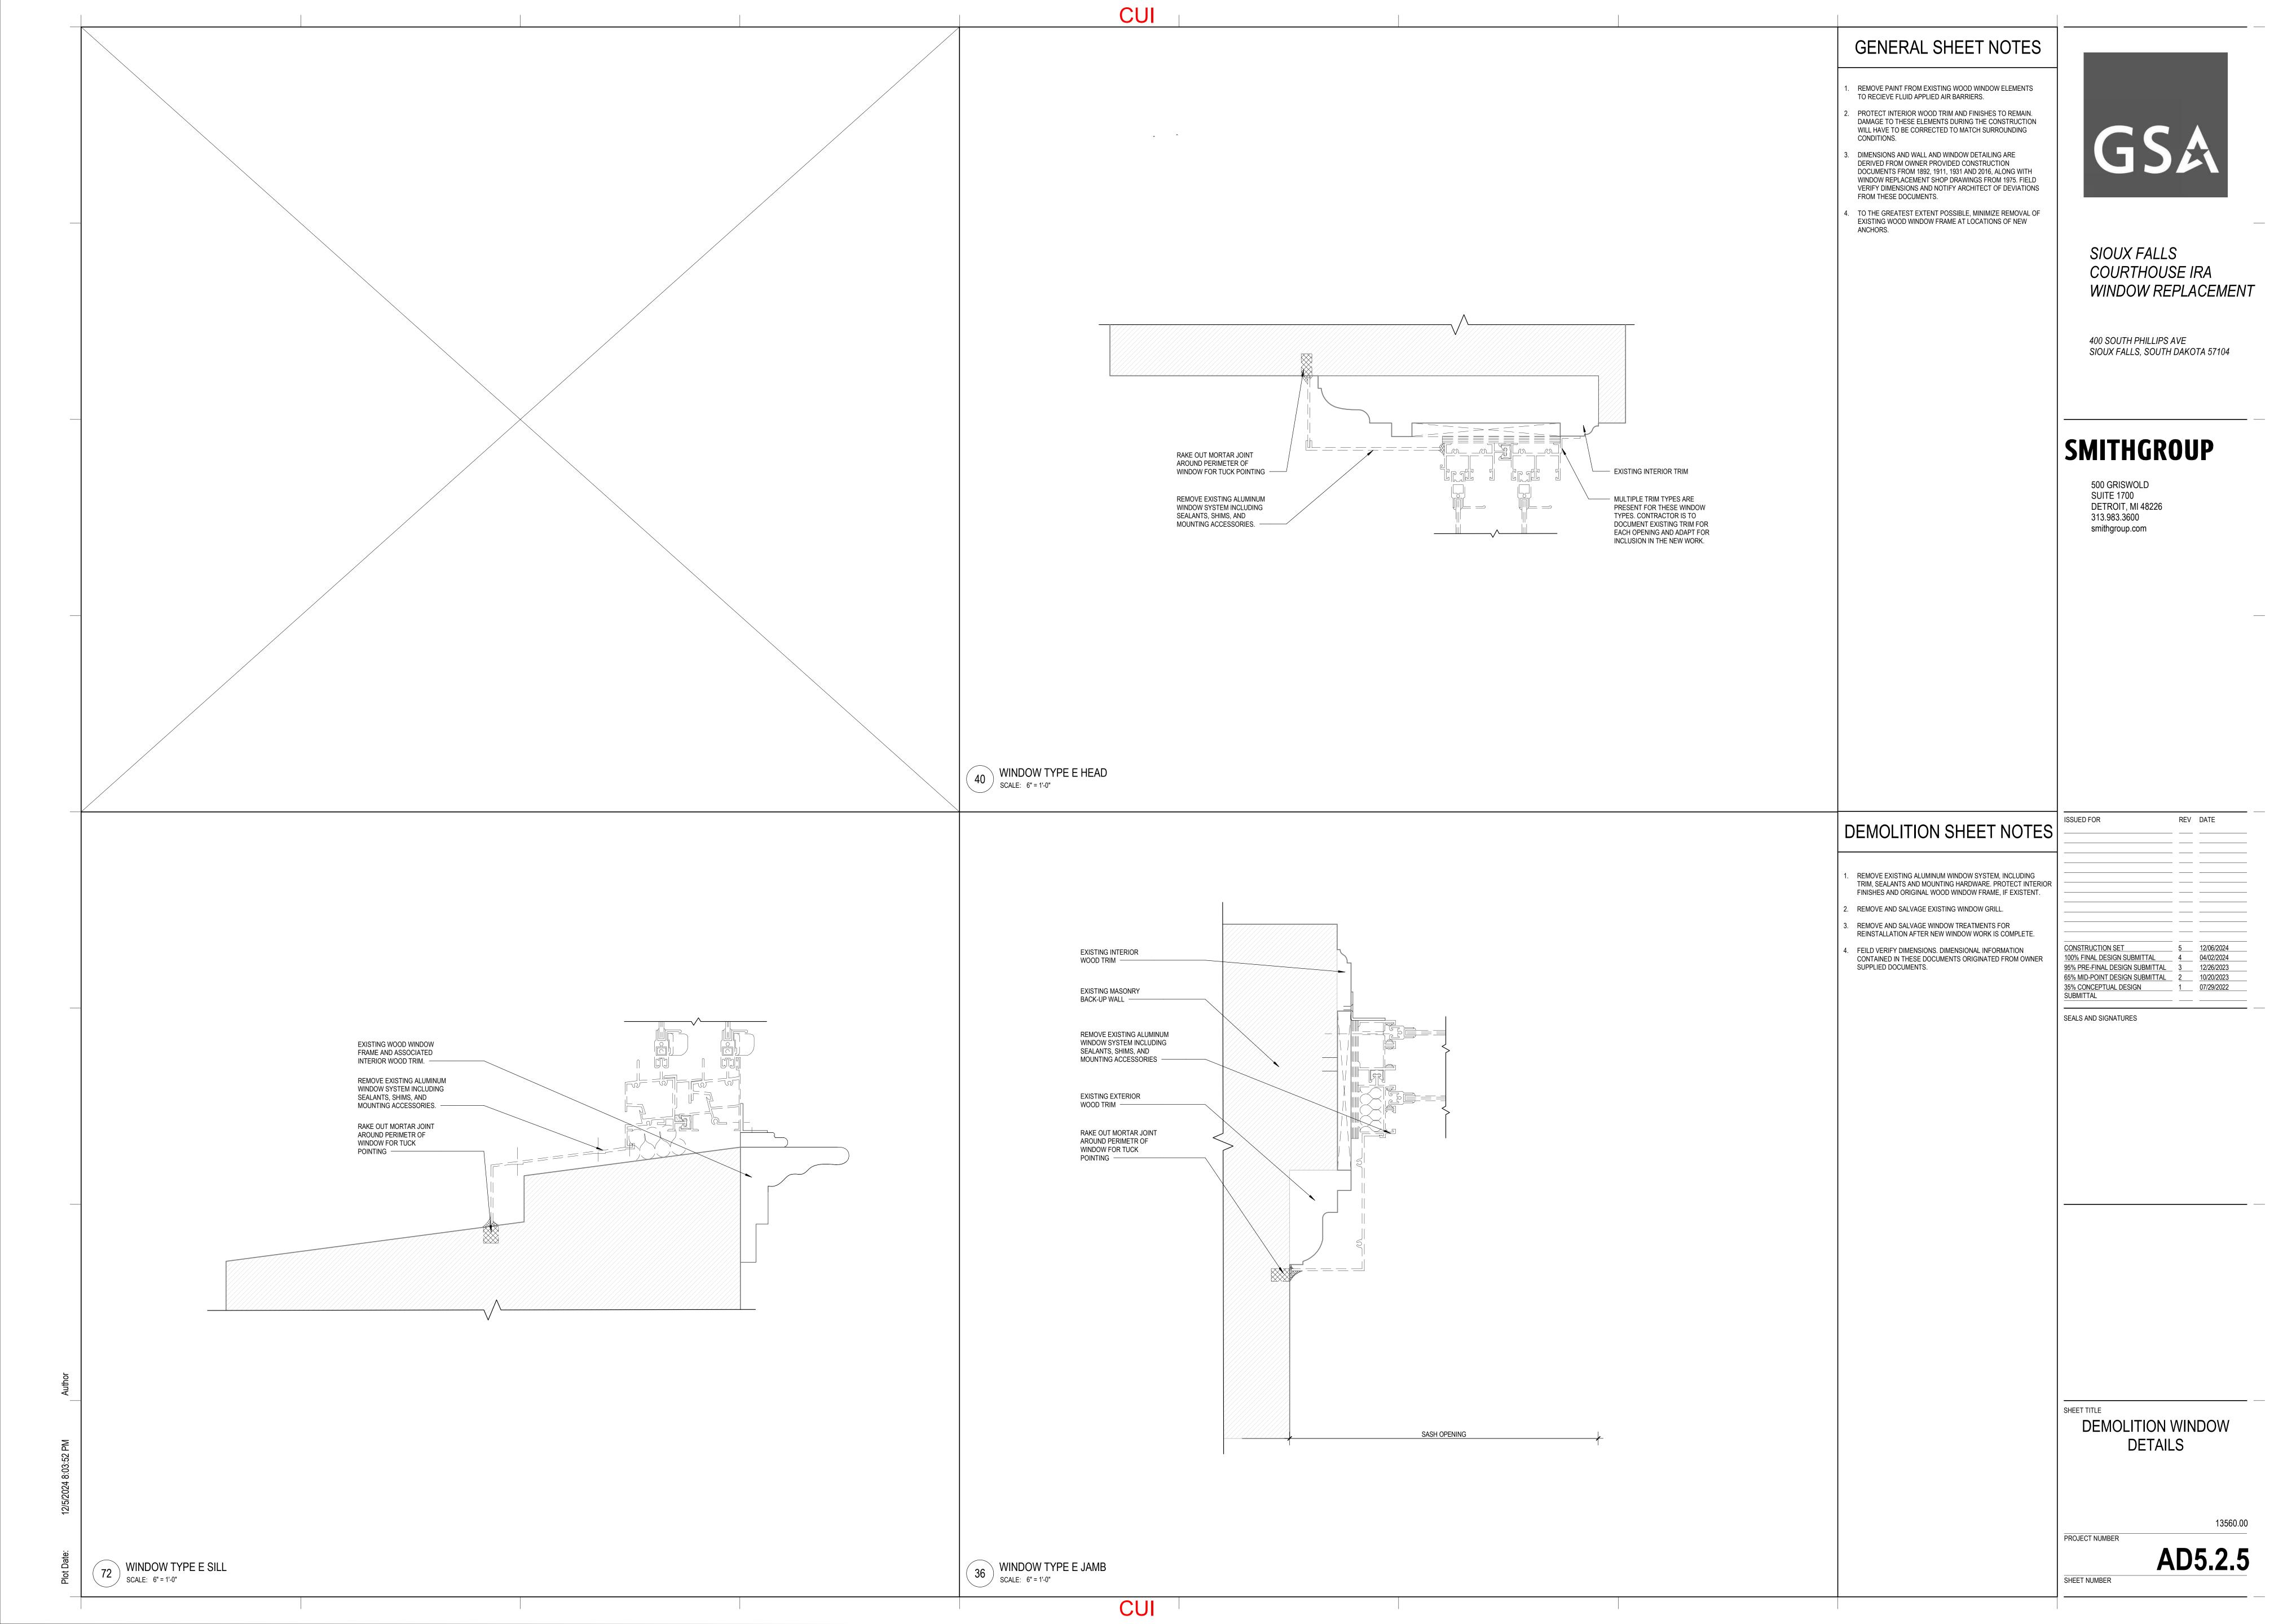


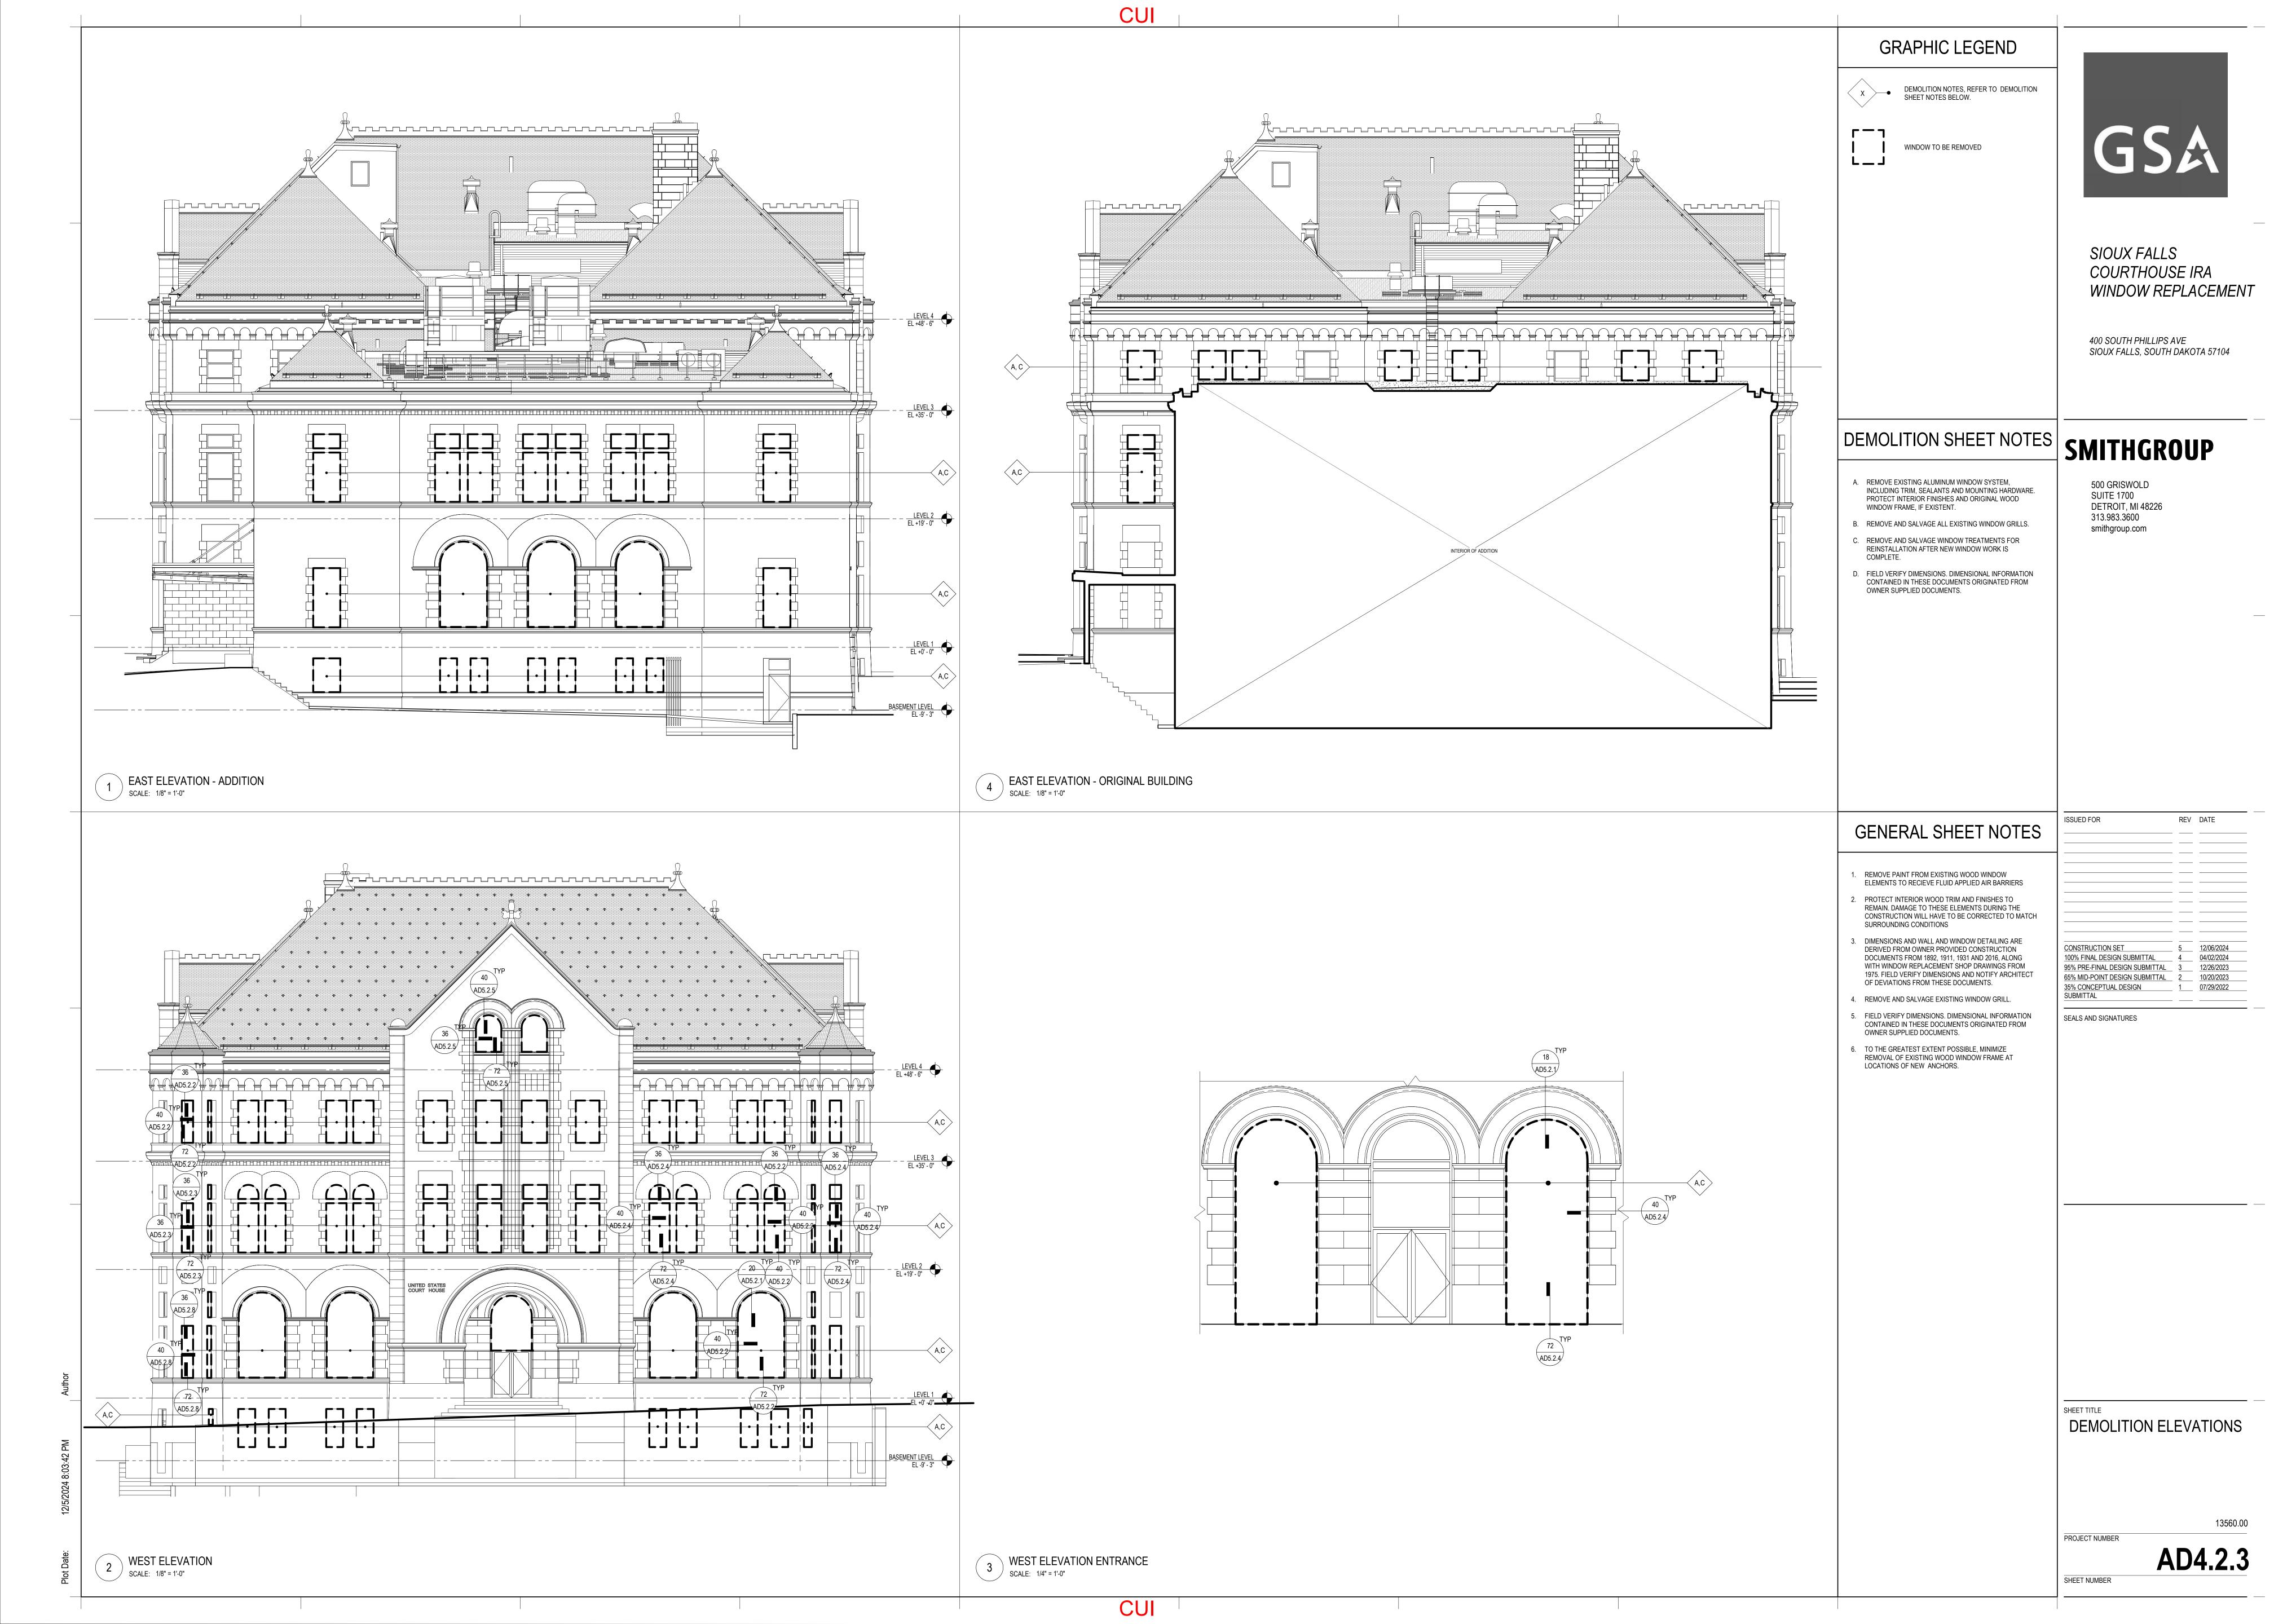


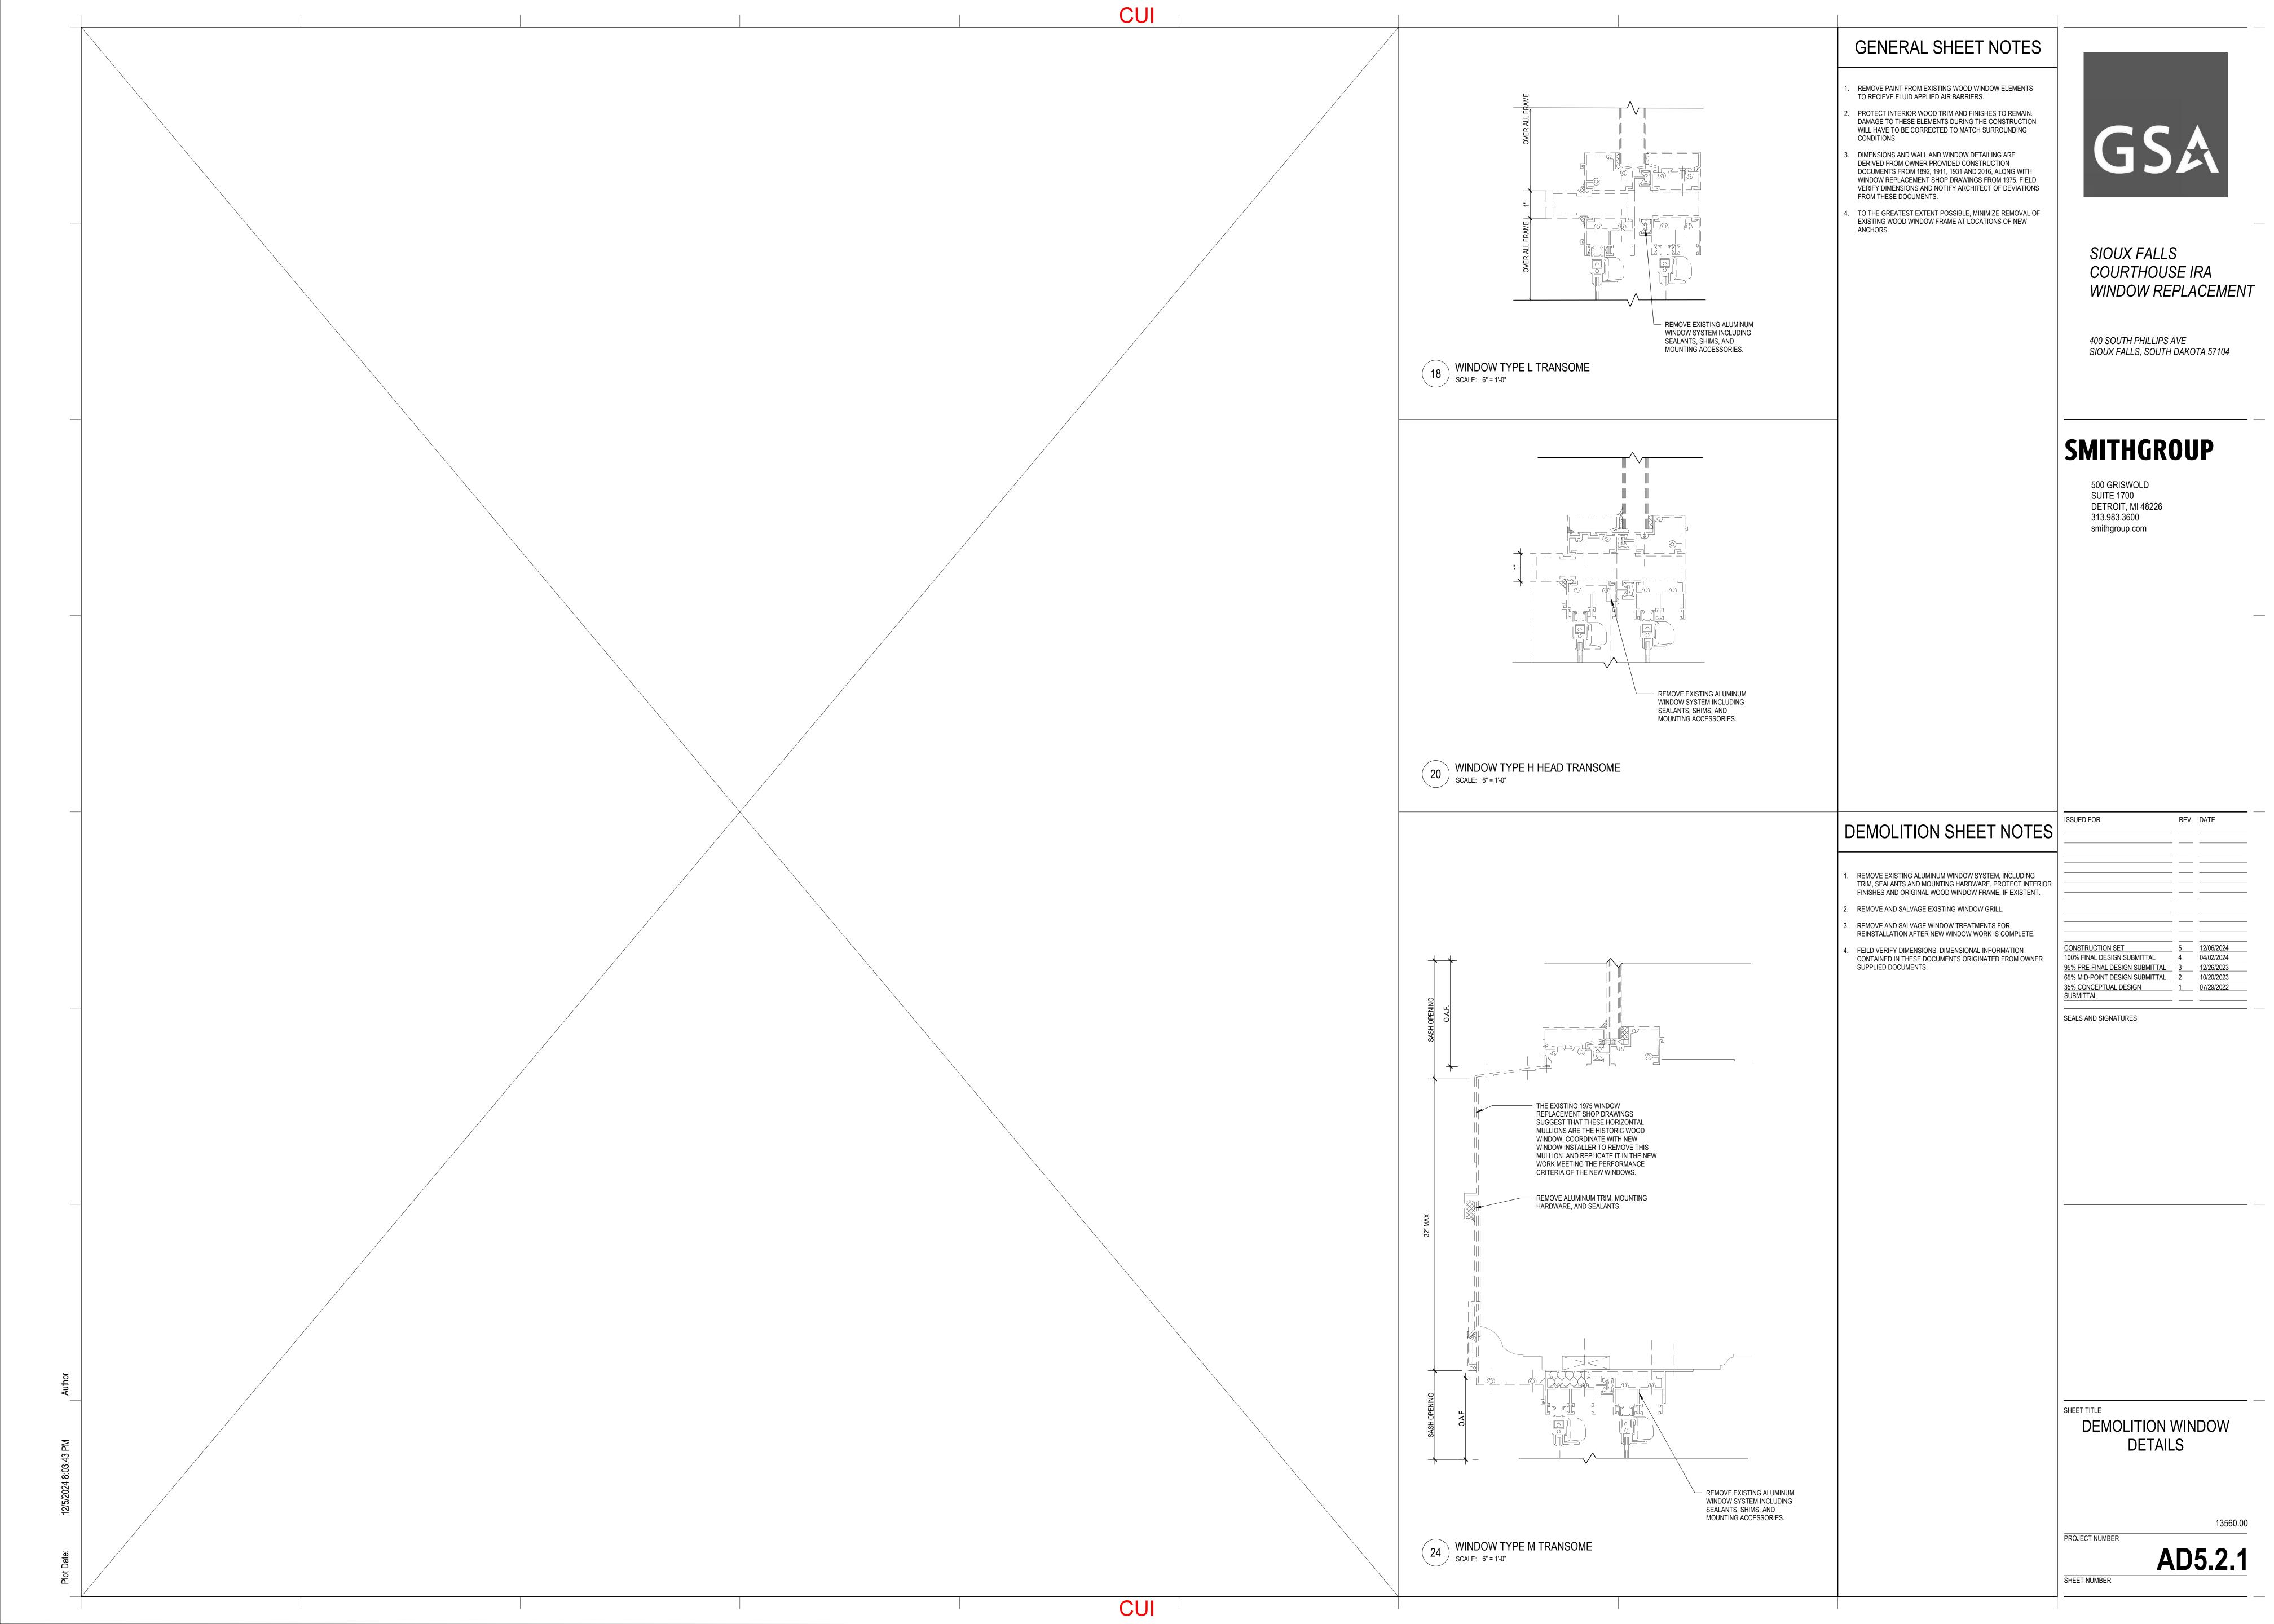


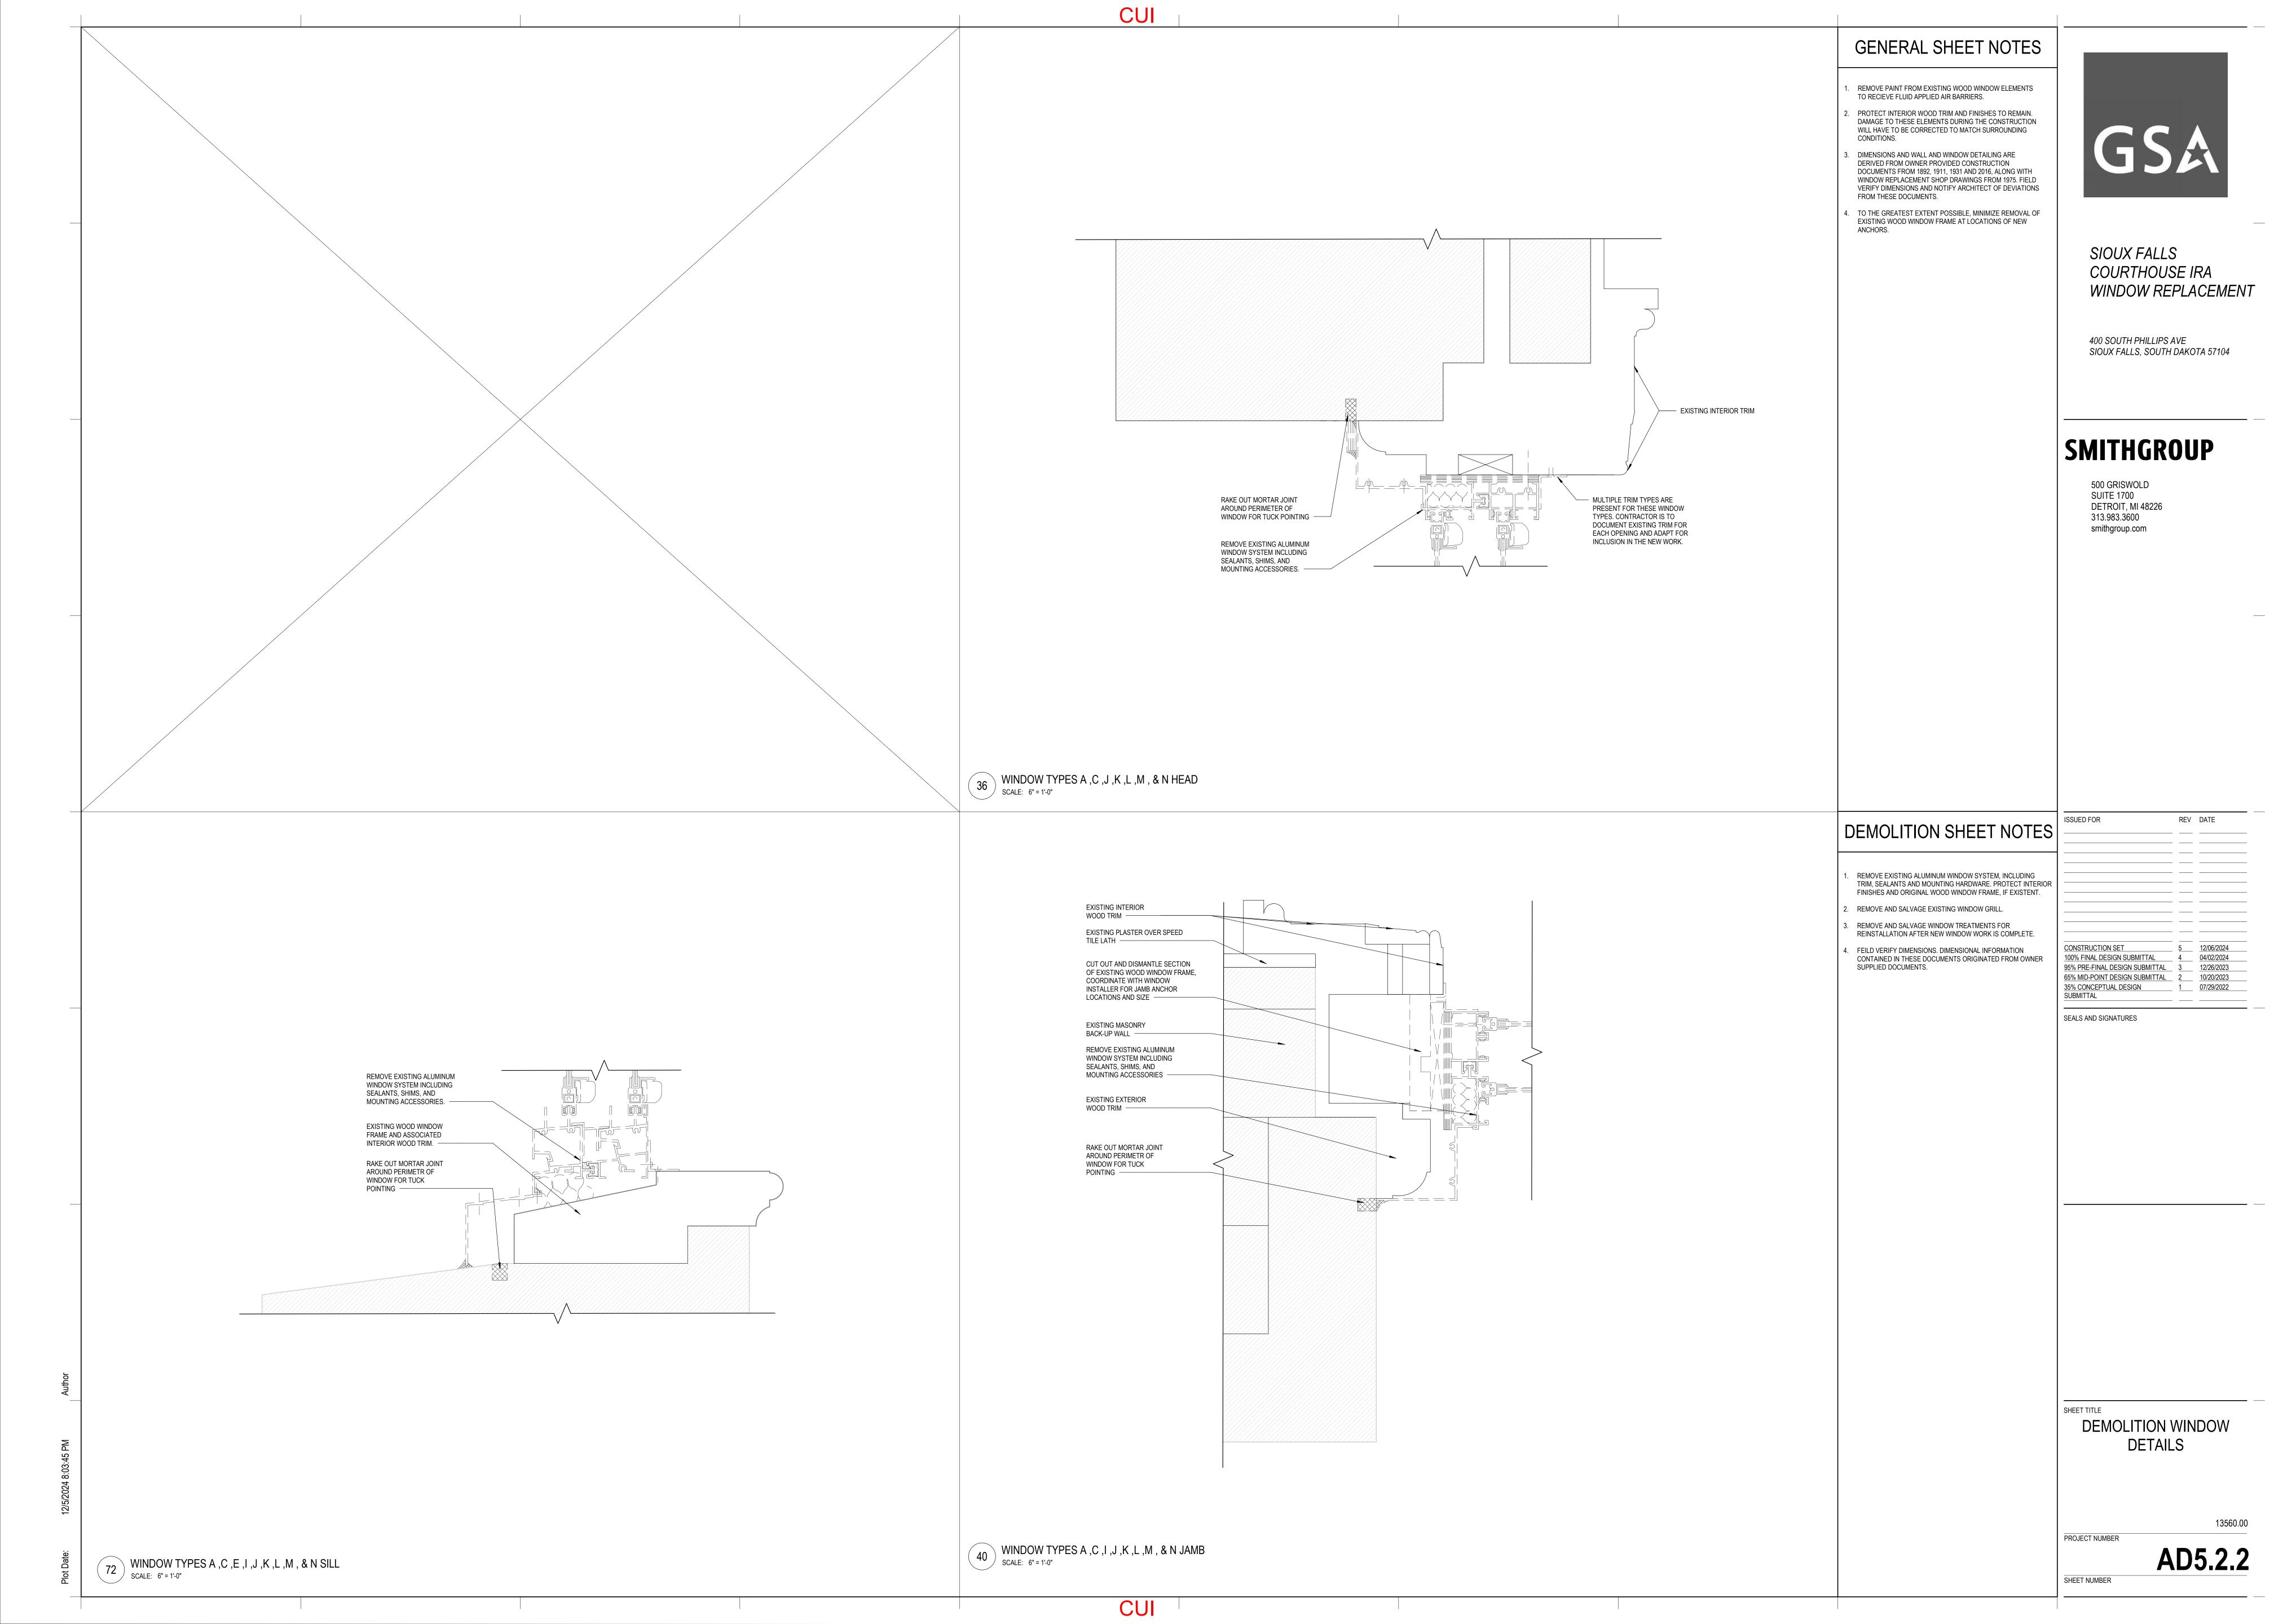


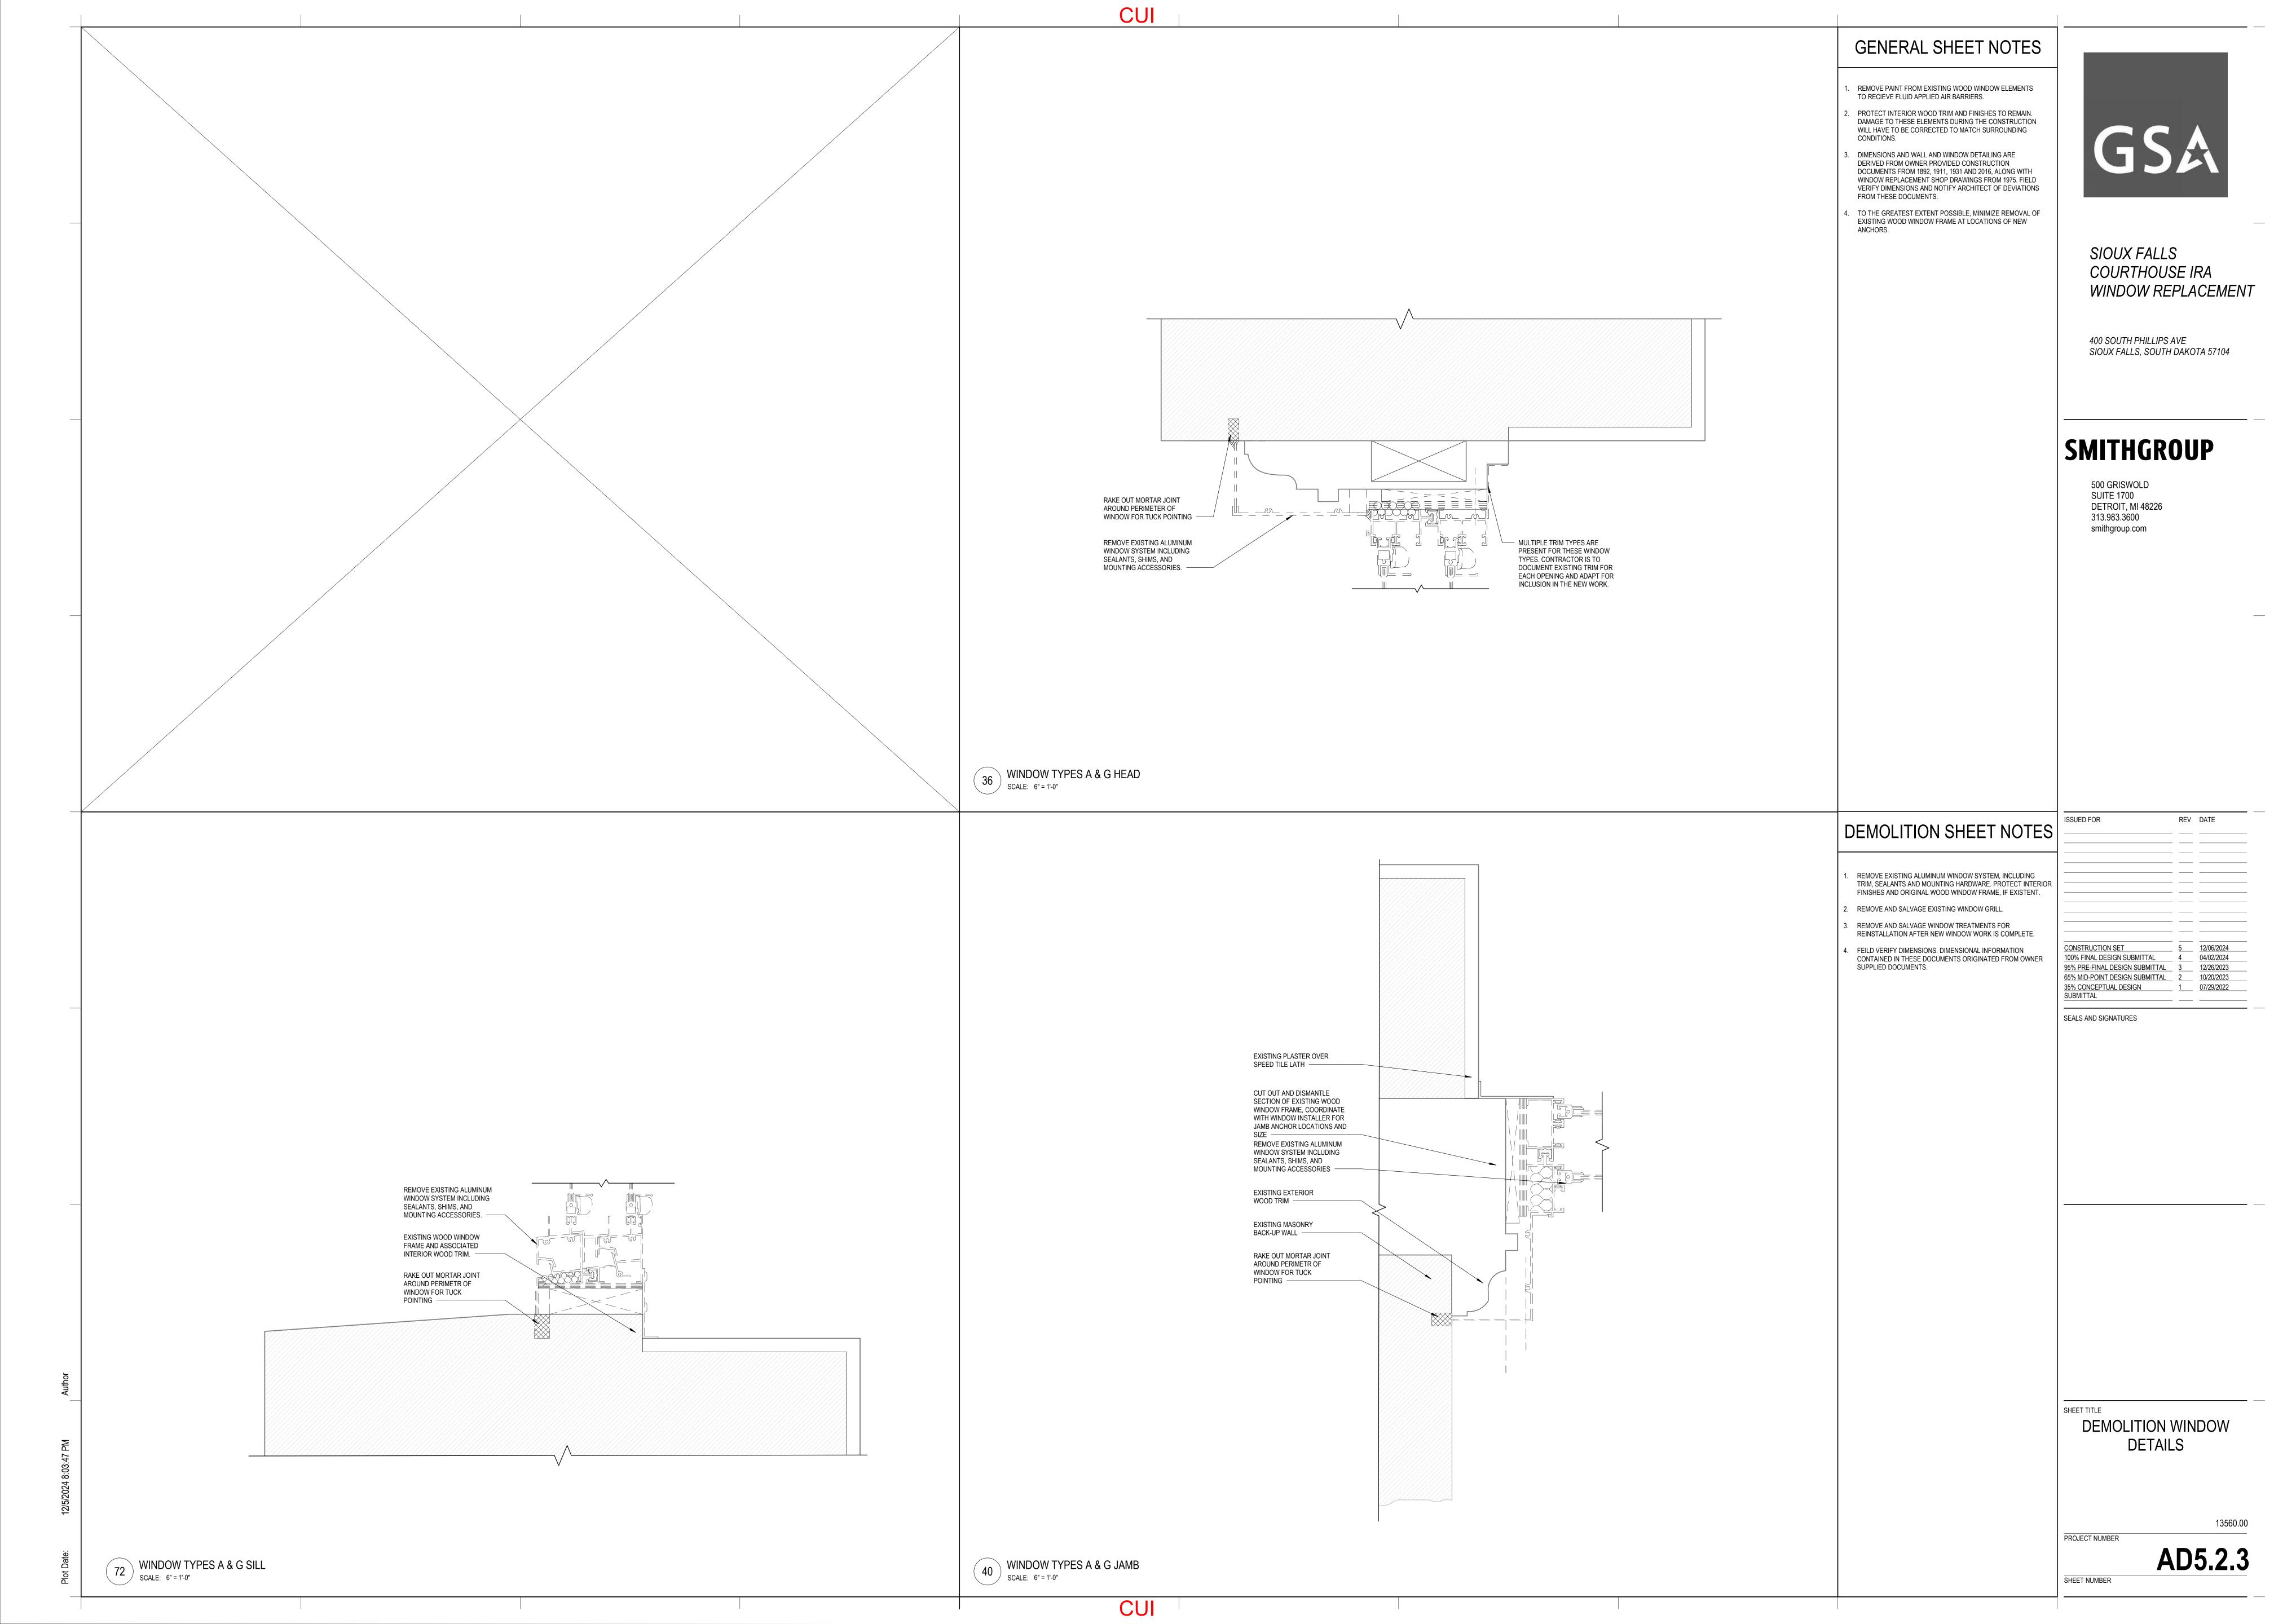


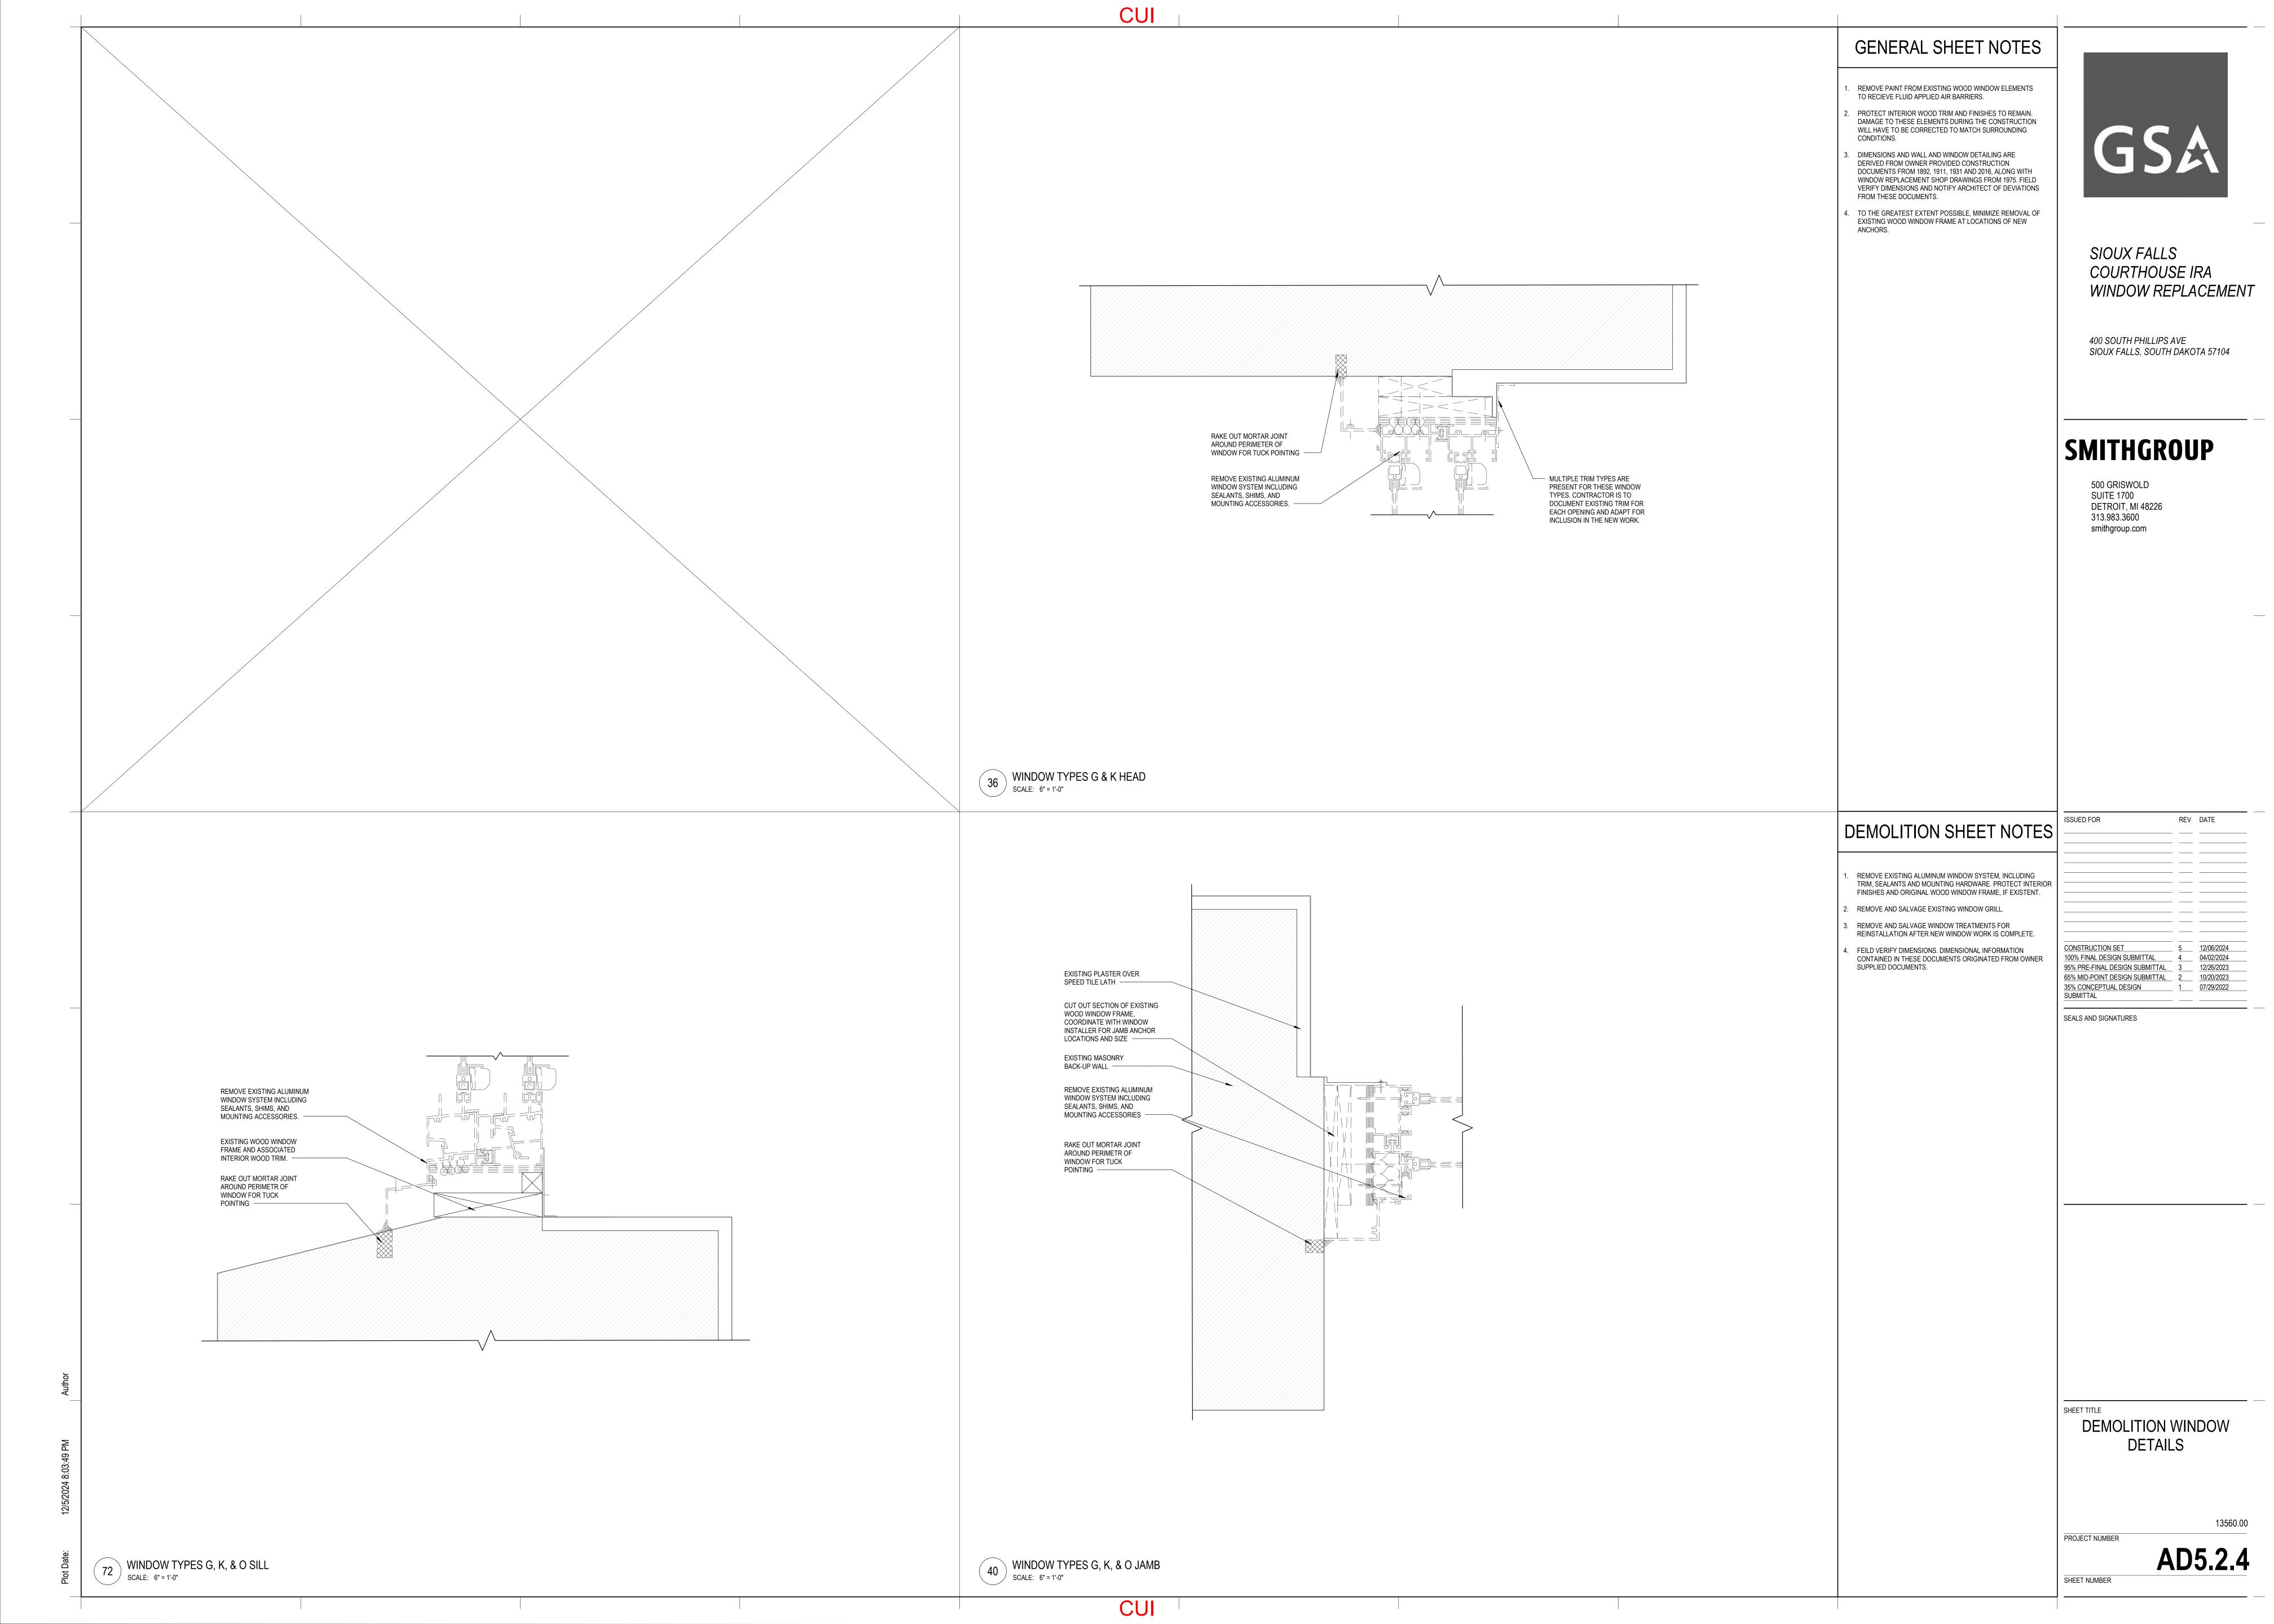

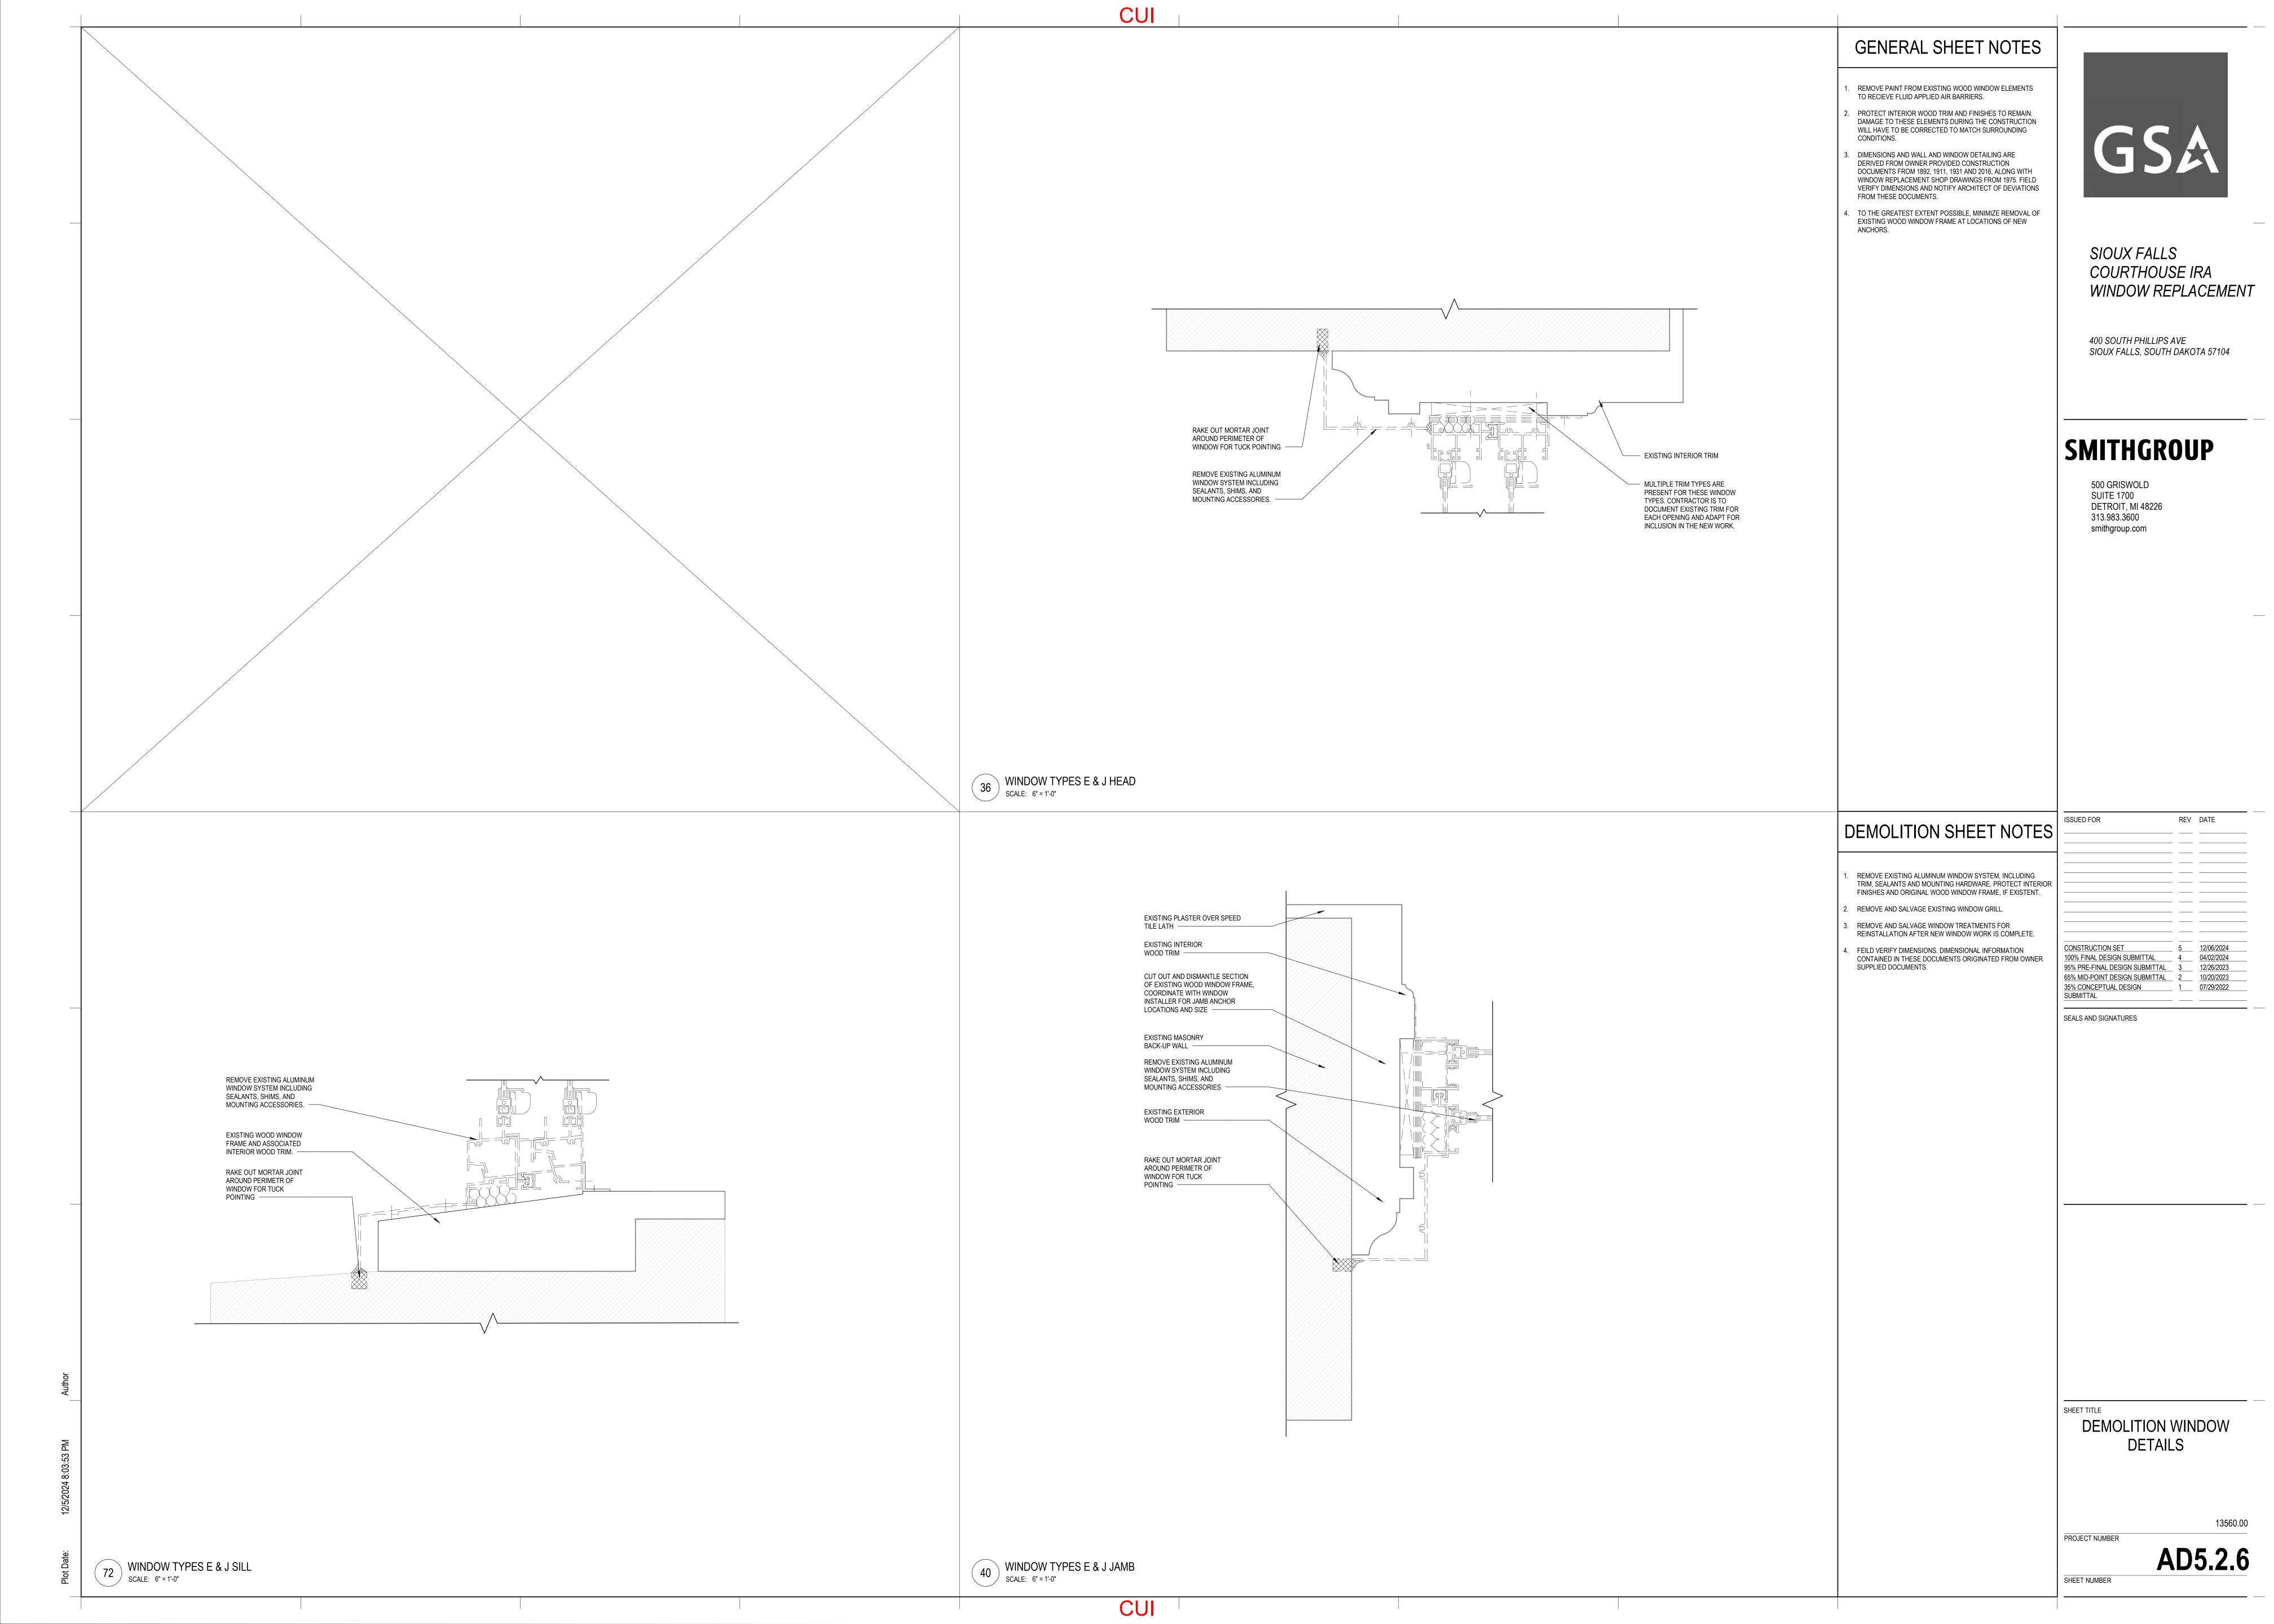

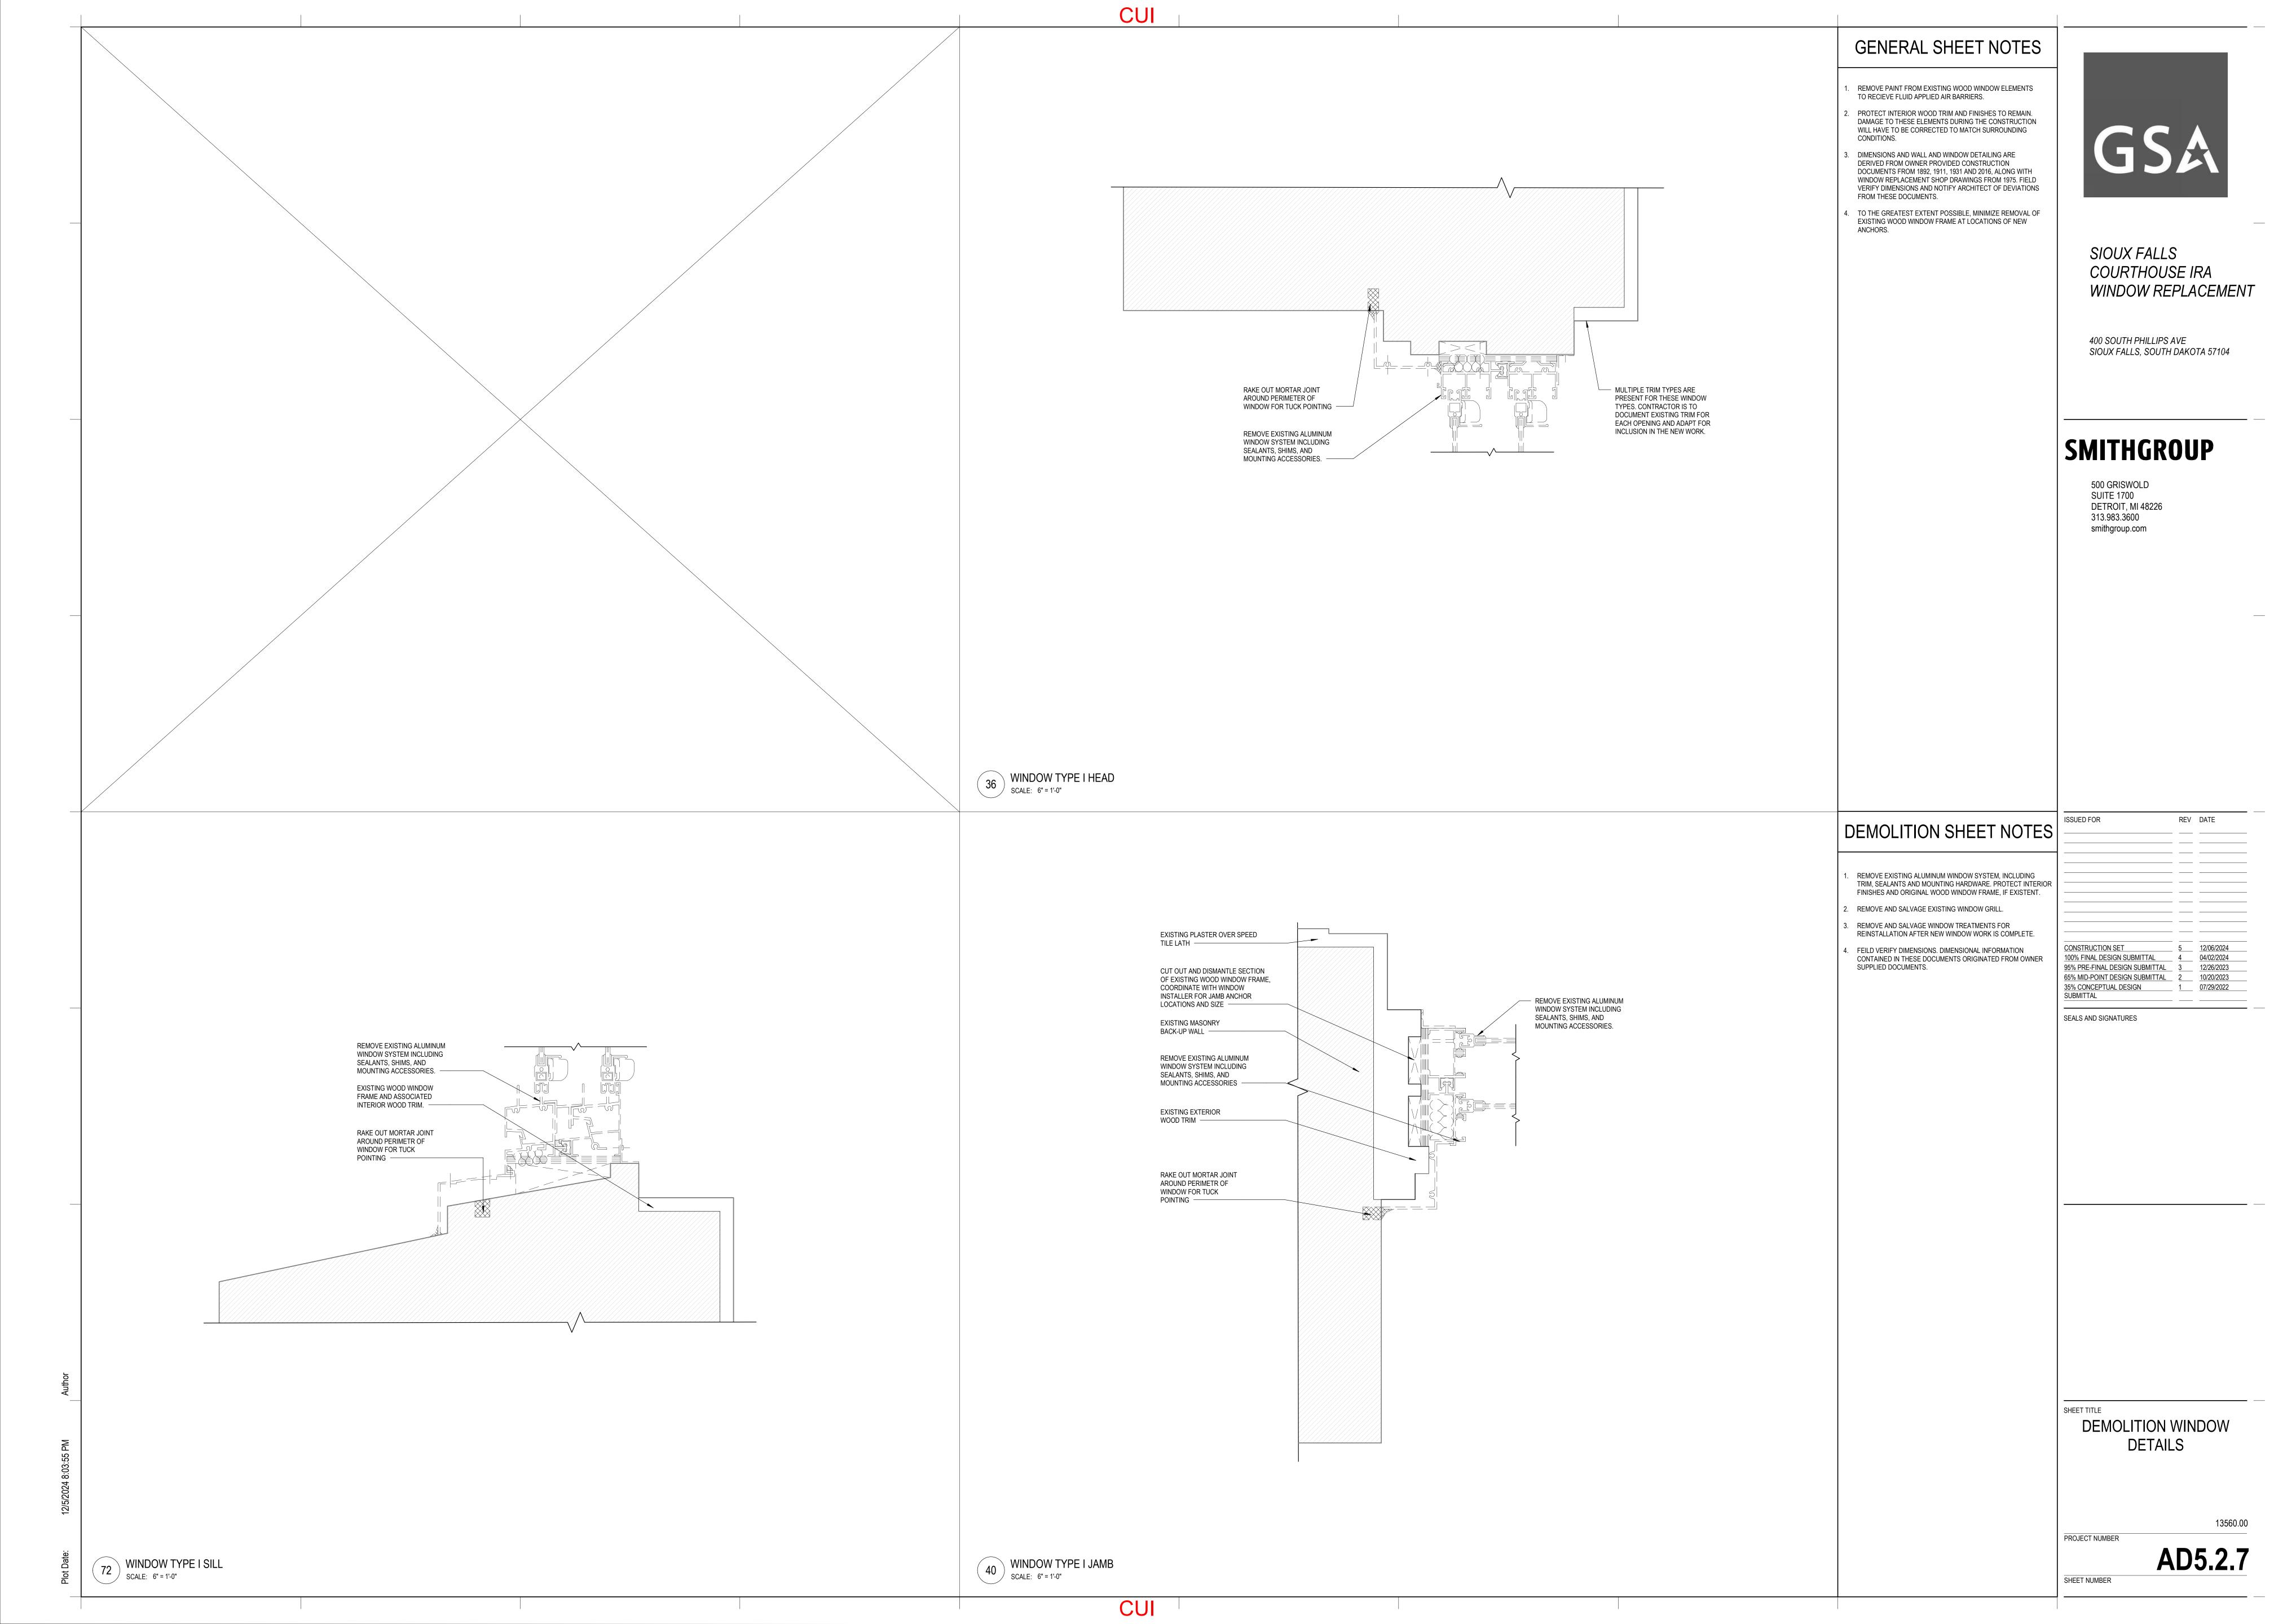

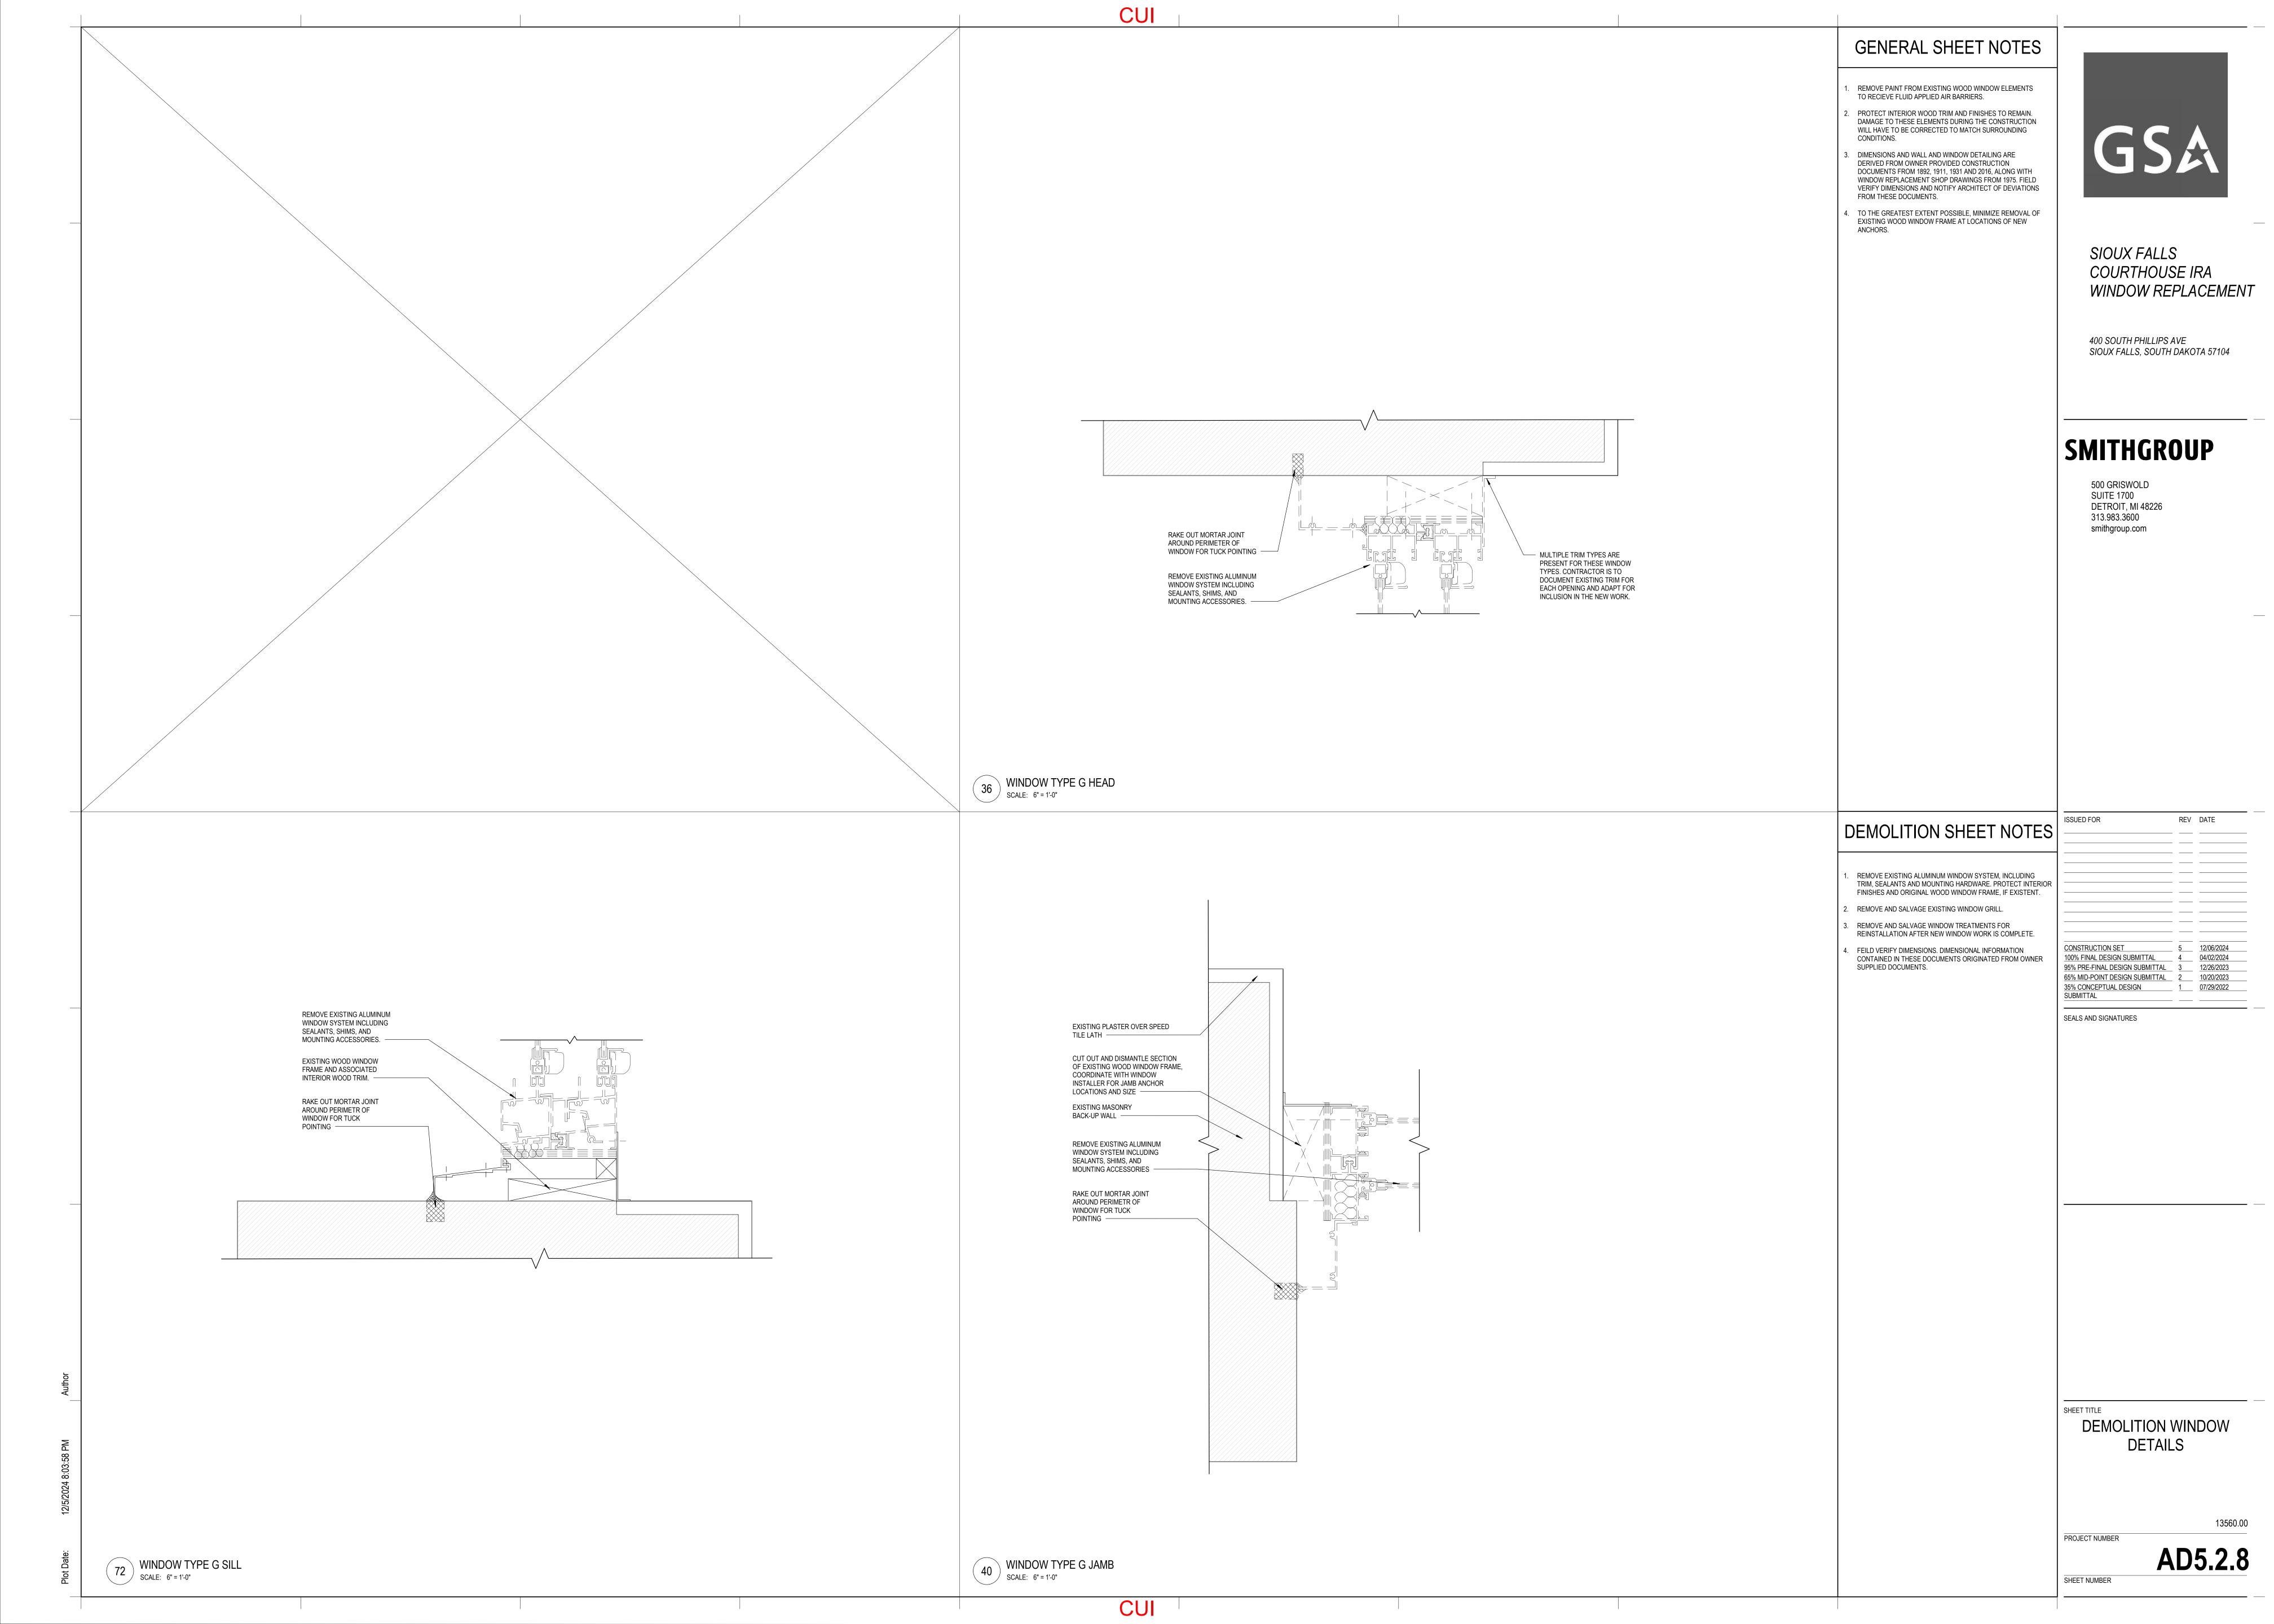

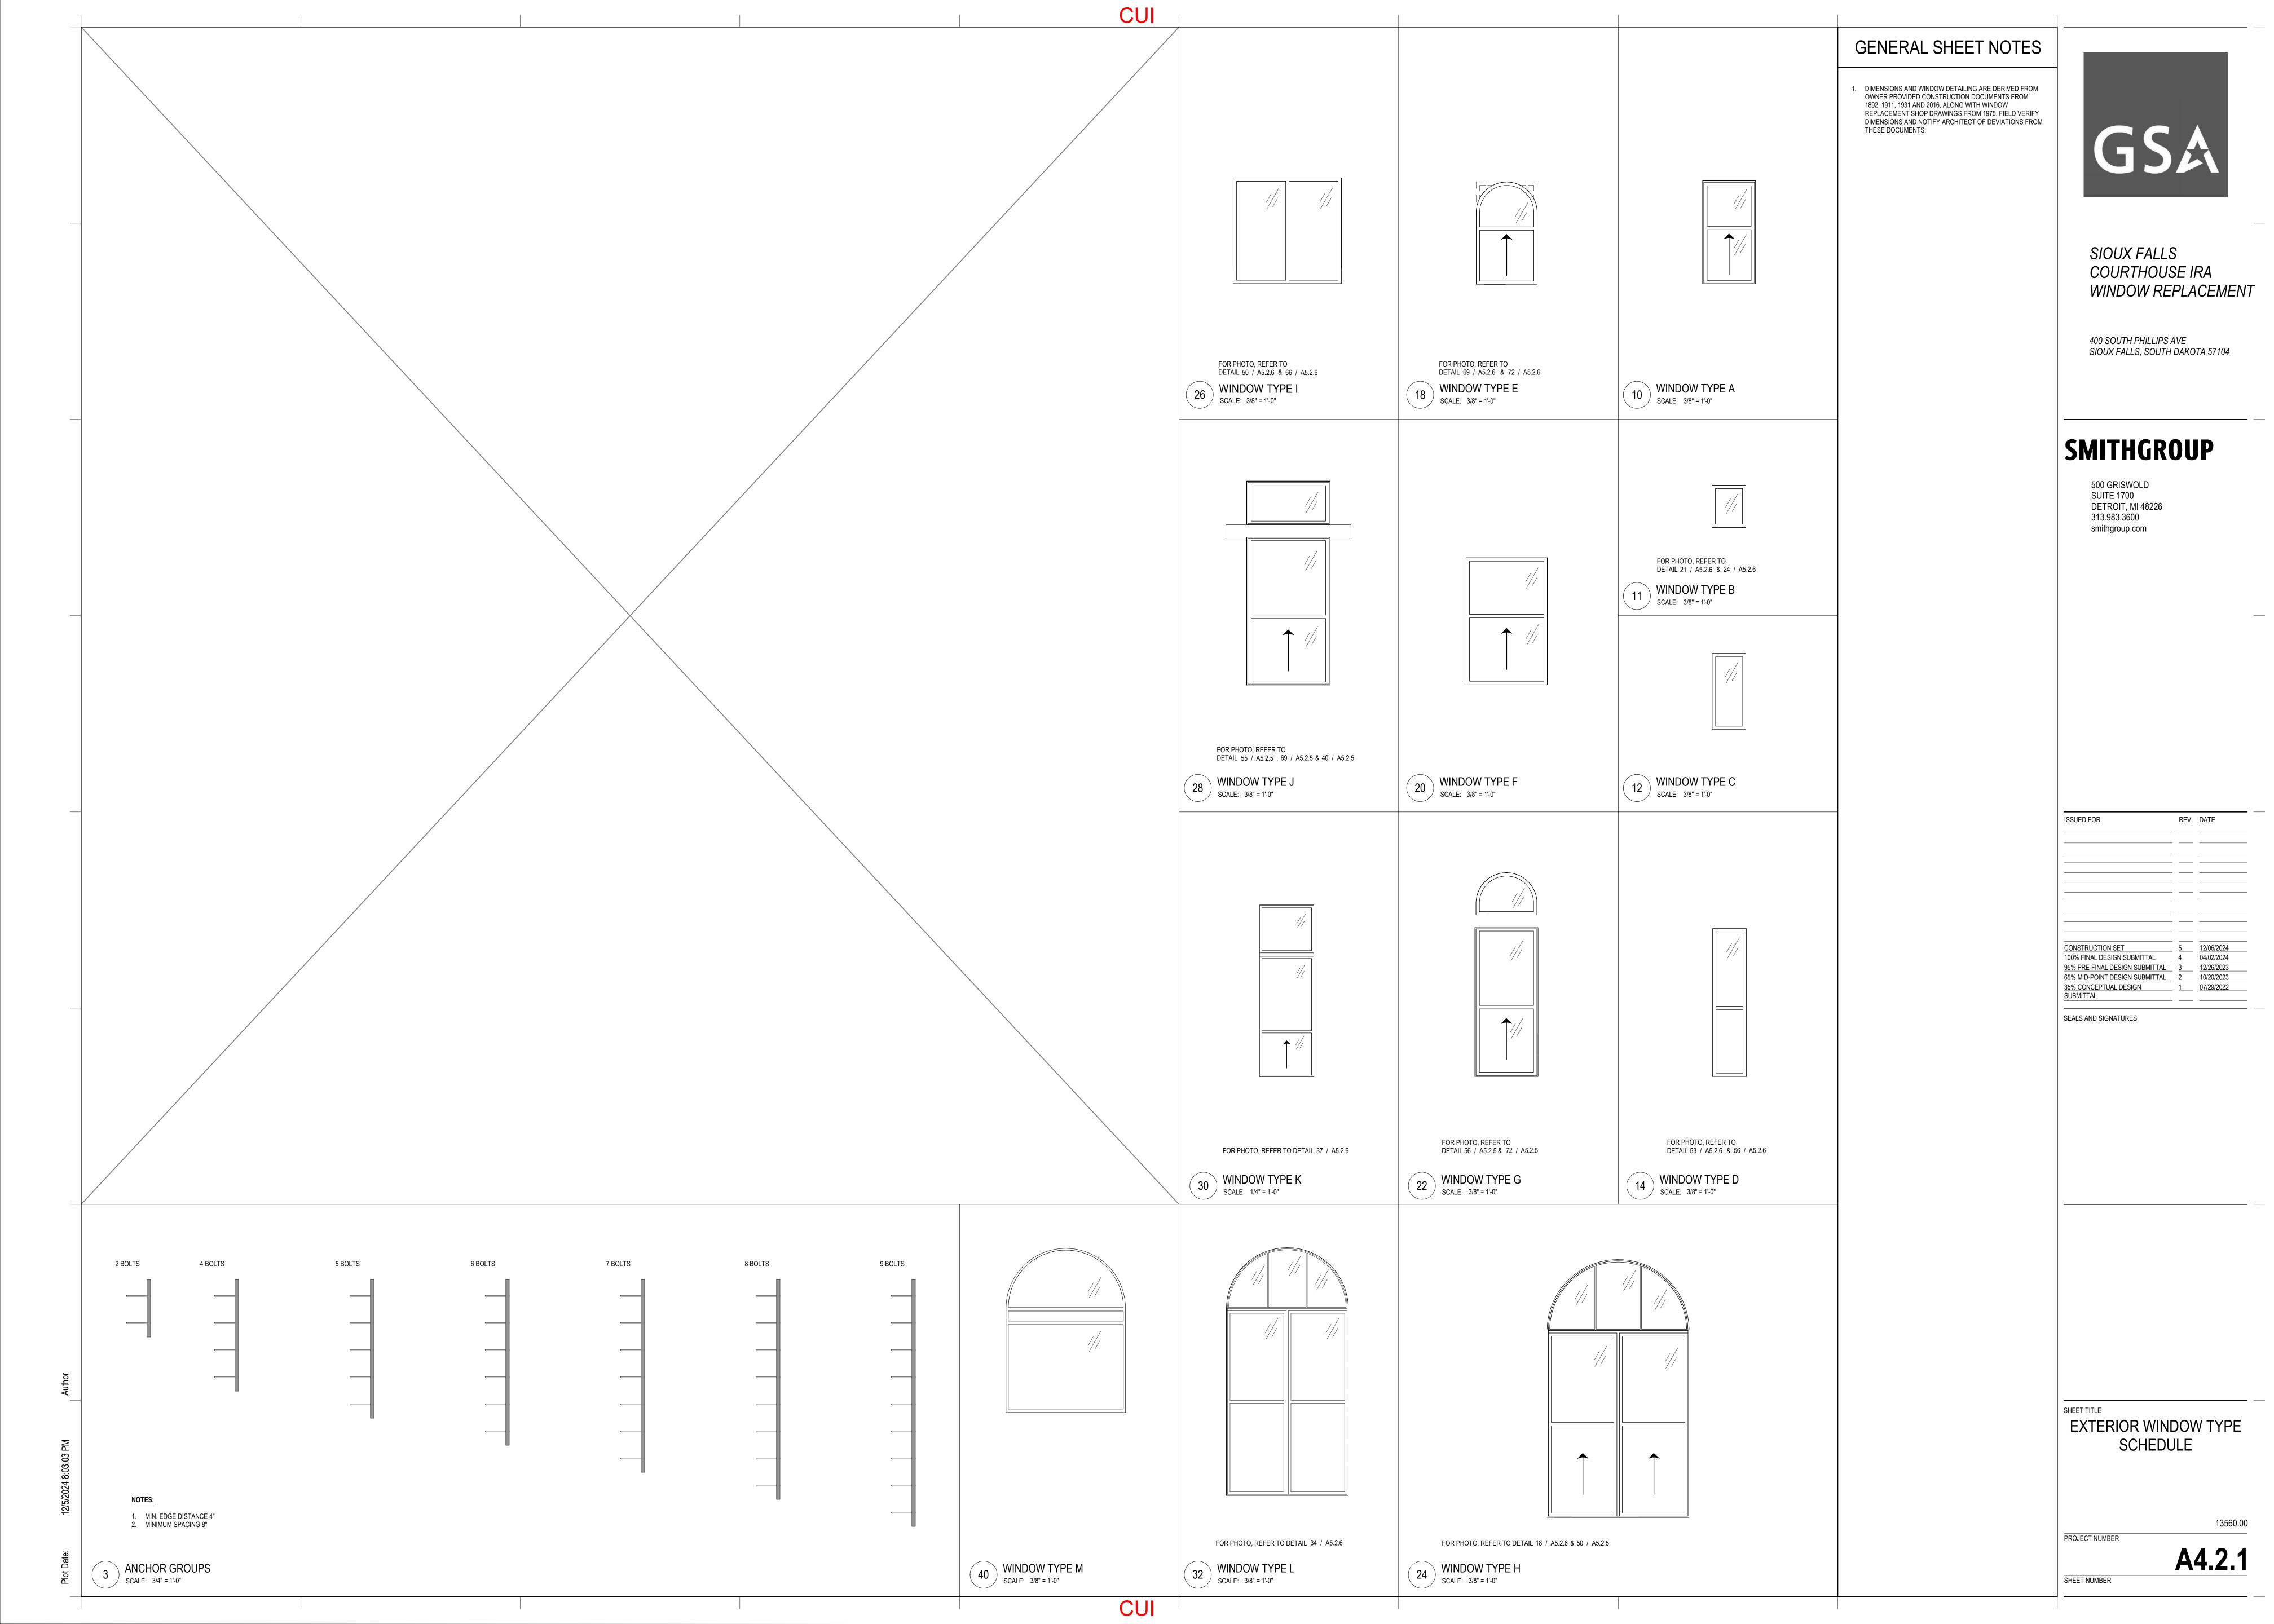

				WINDOW SO	CHEDULE									WINDOW S	CHEDULE					GENERAL SHEET NOTES
					DOUBLE HUNG	1									DOUBLE HUNG	3				
WINDOW MARK	WINDOW TYPE	ANCHOR GROUP	SASH OPENING	CLEAR OPENING	OVERALL	HEAD DETAIL	JAM DETAIL	SILL DETAIL	REMARKS	WINDOW MARK	WINDOW TYPE	ANCHOR GROUP	SASH OPENING	CLEAR OPENING	OVERALL	HEAD DETAIL	JAM DETAIL	SILL DETAIL	REMARKS	1. DIMENSIONS AND WINDOW DETAILING ARE DERIVED FROM OWNER PROVIDED CONSTRUCTION DOCUMENTS FROM 1892, 1911, 1931 AND 2016, ALONG WITH WINDOW REPLACEMENT SHOP DRAWINGS FROM 1975. FIELD VERIFY
E101	F	6	44 1/2" x 102 3/4"		43" x 102 3/4"	36/A5.2.4	40/A5.2.4	72/A5.2.4	2	S116	C	3				36/A5.2.1	40/A5.2.1	72/A5.2.1	3	DIMENSIONS AND NOTIFY ARCHITECT OF DEVIATIONS FROM THESE DOCUMENTS.
E102 E103	H H	7 7 7			39" x 103 1/2" 39" x 103 1/2" 39" x 103 1/2"	36/A5.2.2 36/A5.2.2 36/A5.2.4 36/A5.2.4 36/A5.2.2	40/A5.2.2 40/A5.2.2 40/A5.2.4	72/A5.2.2 72/A5.2.2 72/A5.2.4	4 4 24	S117 S118 S110	D 3	3	18" x 90" 18" x 90"		17 1/2" x 90" 17 1/2" x 90"	36/A5.2.1 36/A5.2.1 36/A5.2.1	40/A5.2.1 40/A5.2.1 40/A5.2.1	72/A5.2.1 72/A5.2.1 72/A5.2.1	1	
E105 E201	F J	6 6	44 1/2" x 102 3/4" 44 1/2" x 84"		43" x 102 3/4" 43" x 84"	36/A5.2.4 36/A5.2.2	40/A5.2.4 40/A5.2.2	72/A5.2.4 72/A5.2.2	2 4	S120 S201	D 3	3	18" x 90" 40 1/2" x 84"		17 1/2" x 90" 39" x 84"	36/A5.2.1 36/A5.2.2	40/A5.2.1 40/A5.2.2	72/A5.2.1 72/A5.2.1 72/A5.2.2	1 4	1
E202 E203	J J	6	40 1/2" x 84" 40 1/2" x 84"		39" x 84" 39" x 84"	36/A5.2.2 36/A5.2.2	40/A5.2.2 40/A5.2.2	72/A5.2.2 72/A5.2.2	4	S202 S203	J 6	3	40 1/2" x 84" 40 1/2" x 84"		39" x 84" 39" x 84"	36/A5.2.2 36/A5.2.2	40/A5.2.2 40/A5.2.2	72/A5.2.2 72/A5.2.2	4	
E204 E205	J	6	40 1/2" x 84" 40 1/2" x 84" 40 1/2" x 84"		39" x 84" 39" x 84" 39" x 84"	36/A5.2.2 36/A5.2.2 36/A5.2.2	40/A5.2.2 40/A5.2.2 40/A5.2.2	72/A5.2.2 72/A5.2.2 72/A5.2.2	4	\$204 \$205 \$206	J (6	3	40 1/2" x 84" 40 1/2" x 84" 40 1/2" x 84"		39" x 84" 39" x 84" 39" x 84"	36/A5.2.2 36/A5.2.2 36/A5.2.2	40/A5.2.2 40/A5.2.2 40/A5.2.2	72/A5.2.2 72/A5.2.2 72/A5.2.2	4	1
E200 E207 E208	J	6	40 1/2" x 84" 40 1/2" x 84" 44 1/2" x 84"		39" x 84" 43" x 84"	36/A5.2.2 36/A5.2.2	40/A5.2.2 40/A5.2.2 40/A5.2.2	72/A5.2.2 72/A5.2.2 72/A5.2.2	4 4	S207 S208	J 6	3	40 1/2" x 84" 40 1/2" x 84"		39" x 84" 39" x 84"	36/A5.2.2 36/A5.2.2	40/A5.2.2 40/A5.2.2 40/A5.2.2	72/A5.2.2 72/A5.2.2 72/A5.2.2	4 4	
E209 E301	J F	6 2	44 1/2" x 84" 44 1/2" x 46"		43" x 84" 43" x 45 1/2"	36/A5.2.2 36/A5.2.4	40/A5.2.2 40/A5.2.4	72/A5.2.2 72/A5.2.4	2,4	S209 S210	J 6	S 3	40 1/2" x 84" 16 1/2" x 58 3/4"		39" x 84" 16" x 58 3/4"	36/A5.2.2 36/A5.2.2	40/A5.2.2 40/A5.2.2	72/A5.2.2 72/A5.2.2	4	
E302 E303	F	2	44 1/2" x 46" 44 1/2" x 46" 44 1/2" x 46"		43" x 45 1/2" 43" x 45 1/2" 43" x 45 1/2"	36/A5.2.4 36/A5.2.4 36/A5.2.4	40/A5.2.4 40/A5.2.4 40/A5.2.4	72/A5.2.4 72/A5.2.4		S211 S212	J 6	3	40 1/2" x 84" 40 1/2" x 84" 40 1/2" x 84"		39" x 84" 39" x 84" 39" x 84"	36/A5.2.2 36/A5.2.2 36/A5.2.2	40/A5.2.2 40/A5.2.2	72/A5.2.2 72/A5.2.2 72/A5.2.2	4	
E305 E306	F F	2 2	44 1/2" x 46" 44 1/2" x 46" 44 1/2" x 46"		43" x 45 1/2" 43" x 45 1/2" 43" x 45 1/2"	36/A5.2.4 36/A5.2.4	40/A5.2.4 40/A5.2.4 40/A5.2.4	72/A5.2.4 72/A5.2.4 72/A5.2.4		S214 S215	J 6	3	40 1/2" x 84" 16 1/2" x 58 3/4"		39" x 84" 16" x 58 3/4"	36/A5.2.2 36/A5.2.2	40/A5.2.2 40/A5.2.2 40/A5.2.2	72/A5.2.2 72/A5.2.2 72/A5.2.2	4	
E307 EB01	F A	2 4	44 1/2" x 46" 26 1/2" x 55 1/4"		43" x 45 1/2" 25" x 55 1/4"	36/A5.2.4 36/A5.2.2	40/A5.2.4 40/A5.2.2	72/A5.2.4 72/A5.2.2		S216 S217	J 6	6	44 1/2" x 84" 40 1/2" x 84"		43" x 84" 43" x 84"	36/A5.2.2 36/A5.2.2	40/A5.2.2 40/A5.2.2	72/A5.2.2 72/A5.2.2	2,3 2,3	
EB02 EB03	A	4	26 1/2" x 55 1/4" 26 1/2" x 55 1/4"		25" x 55 1/4" 25" x 55 1/4" 25" x 55 1/4"		40/A5.2.2 40/A5.2.2	72/A5.2.2 72/A5.2.2		S218 S219	J 6	3	40 1/2" x 84" 44 1/2" x 84"		43" x 84" 43" x 84" 43" x 84"	36/A5.2.2 36/A5.2.2		72/A5.2.2 72/A5.2.2	2,3	
EB05 FB06	A A	4 4 4	26 1/2" x 55 1/4" 26 1/2" x 55 1/4" 26 1/2" x 55 1/4"		25" x 55 1/4" 25" x 55 1/4" 25" x 55 1/4"	36/A5.2.2	40/A5.2.2 40/A5.2.2 40/A5.2.2	72/A5.2.2 72/A5.2.2 72/A5.2.2		S220 S221 S222	J 6	6	40 1/2" x 84" 40 1/2" x 84" 40 1/2" x 84"		43" x 84" 43" x 84"	36/A5.2.2 36/A5.2.2 36/A5.2.2	40/A5.2.2 40/A5.2.2 40/A5.2.2	72/A5.2.2 72/A5.2.2 72/A5.2.2	2,3	
EB07 N101	A D	4 3	44 1/2' x 55 1/4" 18" x 90"		43" x 55 1/4" 17 1/2" x 90"	36/A5.2.2 36/A5.2.1	40/A5.2.2 40/A5.2.1	72/A5.2.2 72/A5.2.1	1	S223 S224	G 6	3	40 1/2" x 84"	32" x 84 3/4" 32" x 84 3/4"	31 1/2" x 83 3/8" 31 1/2" x 83 3/8"	36/A5.2.2 36/A5.2.2	40/A5.2.2 40/A5.2.2	72/A5.2.2 72/A5.2.2	1,2,4 1,2,4	
N102 N103	C D	3	18" x 90" 18" x 90"		17 1/2" x 90" 17 1/2" x 90"	36/A5.2.1	40/A5.2.1 40/A5.2.1	72/A5.2.1 72/A5.2.1	1	S225 S226	G 6		40 1/2" x 84" 40 1/2" x 84"	32" x 84 3/4" 32" x 84 3/4"	31 1/2" x 83 3/8" 31 1/2" x 83 3/8"	36/A5.2.2 36/A5.2.2	40/A5.2.2 40/A5.2.2	72/A5.2.2 72/A5.2.2	1,2,4	
N105 N106	C H	3 7	18" x 90" 18" x 90" 80 1/2" x 150 1/2"		17 1/2" x 90" 17 1/2" x 90" 39" x 105 1/4"	36/A5.2.1	40/A5.2.1 40/A5.2.1 40/A5.2.2	72/A5.2.1 72/A5.2.1 72/A5.2.2	3 4	S227 S228 S229	D 4	1 1 		16" x 84 3/4"	15 1/2" x 83 3/8"	36/A5.2.1 36/A5.2.1 36/A5.2.1	40/A5.2.1 40/A5.2.1 40/A5.2.1	72/A5.2.1 72/A5.2.1 72/A5.2.1	1, 2 2, 3	
N107 N108	H H_	7	80 1/2" x 150 1/2"	80 1/4" x 100"	39" x 98 5/8" 39" x 105 1/4"	36/A5.2.2 36/A5.2.2	40/A5.2.2 40/A5.2.2	72/A5.2.2 72/A5.2.2	1, 4	S230 S231	D 4	4 [16" x 84 3/4"	15 1/2" x 83 3/8"	36/A5.2.1 36/A5.2.1 36/A5.2.1	40/A5.2.1 40/A5.2.1	72/A5.2.1 72/A5.2.1 72/A5.2.1	1, 2 2, 3	
N109 N110	H H	7 7	80 1/2" x 150 1/2" 80 1/2" x 150 1/2"		39" x 105 1/4" 39" x 105 1/4"	36/A5.2.2 36/A5.2.2	40/A5.2.2 40/A5.2.2	72/A5.2.2 72/A5.2.2	4 4	S232 S301	D 4		44 1/2" x 46"		15 1/2" x 83 3/8" 43" x 45 1/2"	36/A5.2.1 36/A5.2.2	40/A5.2.1 40/A5.2.2	72/A5.2.1 72/A5.2.2	1, 2	
N111 N112 N113	H H	7	80 1/2" x 150 1/2" 80 1/2" x 150 1/2" 80 1/2" x 150 1/2"		39" x 105 1/4" 39" x 105 1/4" 39" x 105 1/4"	36/A5.2.2	40/A5.2.2 40/A5.2.2 40/A5.2.2	72/A5.2.2 72/A5.2.2 72/A5.2.2	4 4	S302 S303 S304	F	2	44 1/2" x 46" 44 1/2" x 46" 44 1/2" x 46"		43" x 45 1/2" 43" x 45 1/2"	36/A5.2.2 36/A5.2.2 36/A5.2.2	40/A5.2.2 40/A5.2.2 40/A5.2.2	72/A5.2.2 72/A5.2.2 72/A5.2.2		
N114 N115	A H	7	26 1/4" x 69 1/2" 80 1/2" x 150 1/2"		28" x 69 1/2" 39" x 105 1/4"		40/A5.2.2 40/A5.2.2 40/A5.2.2	72/A5.2.2 72/A5.2.2 72/A5.2.2	4	S305 S306	F 2	2	32 1/2" x 46 32 5/8" x 71"		31 1/2" x 46" 15" x 70 1/2"	36/A5.2.2 36/A5.2.2	40/A5.2.2 40/A5.2.2 40/A5.2.2	72/A5.2.2 72/A5.2.2 72/A5.2.2	2	
N116 N117	A H	7	26 1/4" x 69 1/2" 80 1/2" x 150 1/2"		28" x 69 1/2" 39" x 105 1/4"	36/A5.2.2 36/A5.2.2	40/A5.2.2 40/A5.2.2	72/A5.2.2 72/A5.2.2	4	S307 S308	F 2	2	44 5/8" x 71"		43" x 70 1/2"	36/A5.2.2 36/A5.2.2	40/A5.2.2 40/A5.2.2	72/A5.2.2 72/A5.2.2	2 2	
N118 N201	H D	7	16 1/4" x 83 1/2"		39" x 103 1/2" 14 3/4" x 82"	36/A5.2.1	40/A5.2.4 40/A5.2.1	72.A5.2.4 72/A5.2.1	2, 4	S309 S310	F 2	2	32 5/8" x 71" 32 5/8" x 71"		31" x 70 1/2" 31" x 70 1/2"	36/A5.2.2 36/A5.2.2	40/A5.2.2 40/A5.2.2	72/A5.2.2 72/A5.2.2		
N202 N203 N204	D B	4	16 1/4" x 83 1/2"		14 3/4" x 82"		40/A5.2.1 40/A5.2.1 40/A5.2.1	72/A5.2.1 72/A5.2.1 72/A5.2.1	2,3	S311 S312 S313	F 2	2	32 5/8" x 71" 32 5/8" x 71" 16 5/8" x 71"		31" x 70 1/2" 31" x 70 1/2" 15" x 70 1/2"	36/A5.2.2 36/A5.2.2 36/A5.2.1	40/A5.2.2 40/A5.2.2 40/A5.2.1	72/A5.2.2 72/A5.2.2 72/A5.2.1		
N205 N206	D B	4	16 1/4" x 83 1/2"		14 3/4" x 82"	36/A5.2.1	40/A5.2.1 40/A5.2.1	72/A5.2.1 72/A5.2.1	2 2,3	S314 S315	D 3	3	16 5/8" x 71" 16 5/8" x 71"		15" x 70 1/2" 15" x 70 1/2"	36/A5.2.1 36/A5.2.1	40/A5.2.1 40/A5.2.1	72/A5.2.1 72/A5.2.1		+
N207 N208	G G	6	32 1/2" x 84" 32 1/2" x 84"		31" x 84" 31" x 84"	36/A5.2.2	40/A5.2.2 40/A5.2.2	72/A5.2.2 72/A5.2.2	2,4 2,4	S401 S402	E 5	5	32 5/8" x 60" 32 5/8" x 60"		31" x 59 1/4" 31" x 59 1/4"	36/A5.2.2 36/A5.2.2	40/A5.2.2 40/A5.2.2	72/A5.2.2 72/A5.2.2		
N209 N210 N211	G G	6	32 1/2" x 84" 32 1/2" x 84" 44 1/2" x 84"		31" x 84" 31" x 84" 43" x 84"		40/A5.2.2 40/A5.2.2 40/A5.2.2	72/A5.2.2 72/A5.2.2 72/A5.2.2	2,4 2,4	SB01 SB02 SB03	Α	 	N/A N/A			36/A5.2.2 36/A5.2.2 36/A5.2.2	40/A5.2.2 40/A5.2.2 40/A5.2.2	72/A5.2.2 72/A5.2.2 72/A5.2.2		1
N212 N213	J J	6	44 1/2" x 84" 44 1/2" x 84"		43" x 84" 43" x 84"	36/A5.2.2	40/A5.2.2 40/A5.2.2	72/A5.2.2 72/A5.2.2	4 4	SB04 SB05	A A	, 1	N/A N/A			36/A5.2.2 36/A5.2.2	40/A5.2.2 40/A5.2.2	72/A5.2.2 72/A5.2.2		1
N214 N215	J G	6	44 1/2" x 84" 32 1/2" x 84"		43" x 84" 31" x 84"	36/A5.2.2 36/A5.2.2	40/A5.2.2 40/A5.2.2	72/A5.2.2 72/A5.2.2	4	SB06 SB07	A 4	 	N/A N/A			36/A5.2.2 36/A5.2.2	40/A5.2.2 40/A5.2.2	72/A5.2.2 72/A5.2.2		
N216 N217	G G	6	32 1/2" x 84" 32 1/2" x 84" 32 1/2" x 84"		31" x 84" 31" x 84"	36/A5.2.2	40/A5.2.2 40/A5.2.2 40/A5.2.2	72/A5.2.2 72/A5.2.2 72/A5.2.2	4	SB08 SB09	A 4	 	N/A N/A			36/A5.2.2 36/A5.2.2	40/A5.2.2 40/A5.2.2 40/A5.2.2	72/A5.2.2 72/A5.2.2 72/A5.2.2		1
N216 N219 N220	J	6	40 1/2" x 84" 40 1/2" x 84"		39" x 84" 39" x 84"	36/A5.2.2	40/A5.2.2 40/A5.2.2 40/A5.2.2	72/A5.2.2 72/A5.2.2 72/A5.2.2	2,4	W101 W102	D 3	3	18" x 90" 18" x 90"		17 1/2" x 90" 17 1/2" x 90"	36/A5.2.2 36/A5.2.1 36/A5.2.1	40/A5.2.1 40/A5.2.1	72/A5.2.1 72/A5.2.1	1	
N221 N222	J	6	40 1/2" x 84" 40 1/2" x 84"		39" x 84" 39" x 84"	36/A5.2.2 36/A5.2.2	40/A5.2.2 40/A5.2.2	72/A5.2.2 72/A5.2.2	2,4	W103 W104	C 3		80 1/2" x 150 1/2"		39" x 105 1/4"	36/A5.2.1 36/A5.2.2	40/A5.2.1 40/A5.2.2	72/A5.2.1 72/A5.2.2	3 4	1
N223 N224	J	6	40 1/2" x 84" 40 1/2" x 84"		39" x 84" 39" x 84" 39" x 84"	36/A5.2.2	40/A5.2.2 40/A5.2.2	72/A5.2.2 72/A5.2.2	4	W105 W106	H 7	7	80 1/2" x 150 1/2"		39" x 105 1/4" 33 1/8" x 100 1/2"	36/A5.2.2 36/A5.2.2	40/A5.2.2 40/A5.2.2	72/A5.2.2 72/A5.2.2	3 1, 3	
N225 N226 N227	J J	6	40 1/2" x 84" 40 1/2" x 84" 40 1/2" x 84"		39" x 84" 39" x 84"	36/A5.2.2	40/A5.2.2 40/A5.2.2 40/A5.2.2	72/A5.2.2 72/A5.2.2 72/A5.2.2	4 4 4	W107 W108 W109	L 7	7	80 1/2" x 150 1/2"		33 1/8" x 100 1/2" 39" x 105 1/4"	36/A5.2.2 36/A5.2.2 36/A5.2.2	40/A5.2.2 40/A5.2.2 40/A5.2.2	72/A5.2.2 72/A5.2.2 72/A5.2.2	1, 3	1
N228 N229	J	6	40 1/2" x 84" 40 1/2" x 84"		39" x 84" 39" x 84"		40/A5.2.2 40/A5.2.2	72/A5.2.2 72/A5.2.2	4	W110 W111	H 7		80 1/2" x 150 1/2"		39" x 105 1/4"	36/A5.2.2 36/A5.2.1	40/A5.2.2 40/A5.2.1 40/A5.2.1	72/A5.2.2 72/A5.2.1	4 3	+
N230 N301	J D	6 3	40 1/2" x 84" 16 5/8" x 71"		39" x 84" 15" x 70 1/2"	36/A5.2.2 36/A5.2.1	40/A5.2.2 40/A5.2.1	72/A5.2.2 72/A5.2.1	2	W112 W113	D 3		18" x 90" 18" x 90"		17 1/2" x 90" 17 1/2" x 90"	36/A5.2.1 36/A5.2.1	40/A5.2.1	72/A5.2.1 72/A5.2.1	1	
N302 N303	D D	3	16 5/8" x 71" 16 5/8" x 71" 32 5/8" x 71"		15" x 70 1/2" 15" x 70 1/2" 31" x 70 1/2"	36/A5.2.1	40/A5.2.1 40/A5.2.1 40/A5.2.2	72/A5.2.1 72/A5.2.1 72/A5.2.2	2 2	W201 W202 W203	B '	<u> </u> 			15 1/2" x 83 3/8" 15 1/2" x 83 3/8" 15 1/2" x 83 3/8"	36/A5.2.1 36/A5.2.1 36/A5.2.1	40/A5.2.1 40/A5.2.1 40/A5.2.1	72/A5.2.1 72/A5.2.1 72/A5.2.1	1,2 2,3	1
N305 N306	F F	4 4	32 5/8" x 71" 32 5/8" x 71" 32 5/8" x 71"		31" x 70 1/2" 31" x 70 1/2" 31" x 70 1/2"	36/A5.2.2	40/A5.2.2 40/A5.2.2 40/A5.2.2	72/A5.2.2 72/A5.2.2 72/A5.2.2	2 2	W204 W205	B) 		32" x 84 3/4"	31 1/2" x 83 3/8"	36/A5.2.1 36/A5.2.4	40/A5.2.1 40/A5.2.4	72/A5.2.1 72/A5.2.1 72/A5.2.4	2,3	1
N307 N308	F F	4	32 5/8" x 71" 44 5/8" x 71"		31" x 70 1/2" 43" x 70 1/2"	36/A5.2.2 36/A5.2.2	40/A5.2.2 40/A5.2.2	72/A5.2.2 72/A5.2.2	2	W206 W207	G 6))	32 1/2" x 84"	32" x 84 3/4"	31 1/2" x 83 3/8" 31" x 84"	36/A5.2.4 36/A5.2.2	40/A5.2.4 40/A5.2.2	72/A5.2.4 72/A5.2.2	1, 2	1
N309 N310 N311	F	4 4	32 5/8" x 71" 32 5/8" x 71" 44 5/8" x 71"		31" x 70 1/2" 31" x 70 1/2" 43" x 70 1/2"		40/A5.2.2 40/A5.2.2 40/A5.2.2	72/A5.2.2 72/A5.2.2 72/A5.2.2		W208 W209 W210	G		32 1/2" x 84" 38 1/2" x 84" 41 5/8" x 84"		31" x 84" 37" x 84" 40" x 84"	36/A5.2.2 36/A5.2.2 36/A5.2.2	40/A5.2.2 40/A5.2.2 40/A5.2.2	72/A5.2.2 72/A5.2.2 72/A5.2.2	4 4	
N312 N313	F	4	32 5/8" x 71" 32 5/8" x 71"		31" x 70 1/2" 31" x 70 1/2"	36/A5.2.2 36/A5.2.2	40/A5.2.2 40/A5.2.2	72/A5.2.2 72/A5.2.2 72/A5.2.2	2 2	W211 W212	J 6	6	41 5/8" x 84" 38 1/2" x 84"		40" x 84" 37" x 84"	36/A5.2.2 36/A5.2.2	40/A5.2.2 40/A5.2.2 40/A5.2.2	72/A5.2.2 72/A5.2.2 72/A5.2.2	2, 4	1
N314 N401	F E	5	32 5/8" x 71" 32 5/8" x 60"		31" x 70 1/2" 31" x 59 1/4"		40/A5.2.2	72/A5.2.2	2	W213 W214	G 6	3	32 1/2" x 84" 32 1/2" x 84"		31" x 84" 31" x 84"	36/A5.2.4 36/A5.2.4	40/A5.2.4 40/A5.2.4	72/A5.2.4 72/A5.2.4	2, 4	
N402 NB01 NB02	E B	5 2	32 5/8" x 60" 16 1/2" x 27" 16 1/2" x 27"		31" x 59 1/4"		40/A5.2.1 40/A5.2.1	72/A5.2.1 72/A5.2.1	1	W215 W216 W217	G 6) }	32 1/2" x 84" 32 1/2" x 84"		31" x 84" 31" x 84"	36/A5.2.4 36/A5.2.4 36/A5.2.1		72/A5.2.4 72/A5.2.4 72/A5.2.1	2, 4	-
NB03 NB04	A A	4	16 1/2" x 2/" 26" x 56 1/4" 26" x 56 1/4"		25 1/2" x 56 1/4" 25 1/2" x 56 1/4"	36/A5.2.2	40/A5.2.1 40/A5.2.2 40/A5.2.2	72/A5.2.1 72/A5.2.2 72/A5.2.2		W217 W218 W219	D 4	1 1 1	16 1/4" x 83 1/2"		14 3/4" x 82"	36/A5.2.1 36/A5.2.1 36/A5.2.1	40/A5.2.1 40/A5.2.1 40/A5.2.1	72/A5.2.1 72/A5.2.1 72/A5.2.1	2 2,3	
NB05 NB06	A A	4	26" x 56 1/4" 26" x 56 1/4"		25 1/2" x 56 1/4" 25 1/2" x 56 1/4"	36/A5.2.2 36/A5.2.2	40/A5.2.2 40/A5.2.2	72/A5.2.2 72/A5.2.2		W220 W301	D 2	3	16 1/4" x 83 1/2" 16 5/8" x 71"		14 3/4" x 82" 15" x 70 1/2"	36/A5.2.1 36/A5.2.1	40/A5.2.1 40/A5.2.1	72/A5.2.1 72/A5.2.1	2	
NB07 NB08	A A	4	26" x 56 1/4" 26" x 56 1/4"		25 1/2" x 56 1/4" 25 1/2" x 56 1/4"	36/A5.2.2	40/A5.2.2 40/A5.2.2	72/A5.2.2 72/A5.2.2		W302 W303	D 3	1	16 5/8" x 71" 32 5/8" x 71"		15" x 70 1/2" 31" x 70 1/2"	36/A5.2.1 36/A5.2.2	40/A5.2.2	72/A5.2.1 72/A5.2.2		
NB10	A A	4 4 4	26 1/2" x 55 1/4" 26 1/2" x 55 1/4" 26 1/2" x 55 1/4"		25" x 55 1/4" 25" x 55 1/4" 25" x 55 1/4"		40/A5.2.2 40/A5.2.2 40/A5.2.2	72/A5.2.2 72/A5.2.2 72/A5.2.2		W304 W305 W306	F	1	32 5/8" x 71" 32 5/8" x 71" 32 5/8" x 71"		31" x 70 1/2" 31" x 70 1/2" 31" x 70 1/2"	36/A5.2.2 36/A5.2.2 36/A5.2.2	40/A5.2.2 40/A5.2.2 40/A5.2.2	72/A5.2.2 72/A5.2.2 72/A5.2.2		1
NB12 NB13	A A	4	26 1/2" x 55 1/4" 26 1/2" x 55 1/4"		25" x 55 1/4" 25" x 55 1/4"	36/A5.2.4 36/A5.2.4	40/A5.2.4 40/A5.2.4	72/A5.2.4 72/A5.2.4	2 2	W307 W308	F 4	1 1	38 5/8" x 71" 41 5/8" x 71"		37" x 70 1/2" 40" x 70 1/2"	36/A5.2.2 36/A5.2.2	40/A5.2.2 40/A5.2.2	72/A5.2.2 72/A5.2.2		
NB14 NB15	A	4	26 1/2" x 55 1/4" 26 1/2" x 55 1/4"		25" x 55 1/4" 25" x 55 1/4"	36/A5.2.4 36/A5.2.4	40/A5.2.4 40/A5.2.4	72/A5.2.4 72/A5.2.4	2	W309 W310	F 4	1 1	41 5/8" x 71" 38 5/8" x 71"		40" x 70 1/2" 37" x 70 1/2"	36/A5.2.2 36/A5.2.2	40/A5.2.2 40/A5.2.2	72/A5.2.2 72/A5.2.2	2	
NB17 NB18	A A	4 4 4	26 1/2" x 55 1/4" 26 1/2" x 55 1/4" 26 1/2" x 55 1/4"		25" x 55 1/4" 25" x 55 1/4" 25" x 55 1/4"	36/A5.2.4	40/A5.2.4 40/A5.2.4 40/A5.2.4	72/A5.2.4 72/A5.2.4 72/A5.2.4	2 2	W311 W312 W313	F 4	1	32 5/8" x 71" 32 5/8" x 71" 32 5/8" x 71"		31" x 70 1/2" 31" x 70 1/2" 31" x 70 1/2"	36/A5.2.2 36/A5.2.2 36/A5.2.2	40/A5.2.2 40/A5.2.2 40/A5.2.2	72/A5.2.2 72/A5.2.2 72/A5.2.2	2 2	-
\$101 \$102	K K	6	40 1/2" x 102" 40 1/2" x 102"		39" x 102" 39" x 102"	36/A5.2.4	40/A5.2.4 40/A5.2.4 40/A5.2.4	72/A5.2.4 72/A5.2.4 72/A5.2.4	2 2	W314 W315	F 4	1	32 5/8" x 71" 16 5/8" x 71"		31" x 70 1/2" 31" x 70 1/2" 15" x 70 1/2"	36/A5.2.2 36/A5.2.1	40/A5.2.2 40/A5.2.1	72/A5.2.2 72/A5.2.2 72/A5.2.1	2 2	-
S103 S104	K K	6	40 1/2" x 102" 40 1/2" x 102"		39" x 102" 39" x 102"	36/A5.2.4 36/A5.2.4	40/A5.2.4 40/A5.2.4	72/A5.2.4 72/A5.2.4	2 2	W316 W401	D 3		16 5/8" x 71"		15" x 70 1/2"	36/A5.2.1 36/A5.2.2	40/A5.2.1 40/A5.2.2	72/A5.2.1 72/A5.2.2	2 2	
\$105 \$106 \$107	 	4	59 1/4" 59 3/8" 59 1/4" 59 3/8"		58 3/4" 59 3/8" 58 3/4" 59 3/8"	36/A5.2.4 36/A5.2.4	40/A5.2.4 40/A5.2.4	72/A5.2.4 72/A5.2.4	1, 2	W402 WB01 WB02	E 5		16 1/2" x 27"		25 1/2" X 63 1/2"	36/A5.2.2 36/A5.2.2	40/A5.2.2 40/A5.2.2	72/A5.2.2 72/A5.2.2 72/A5.2.2	2	
\$108 \$109	I K	4 6	59 1/4" 59 3/8" 59 1/4" 59 3/8" 44 1/2" x 94 1/2"		58 3/4" 59 3/8" 58 3/4" 59 3/8" 43" x 94 1/4"		40/A5.2.4 40/A5.2.4 40/A5.2.2	72/A5.2.4 72/A5.2.4 72/A5.2.2	1, 2	WB02 WB03 WB04	A 2	1	26" X 63 1/2" 26" X 63 1/2" 26" X 63 1/2"		25 1/2" X 63 1/2" 25 1/2" X 63 1/2" 25 1/2" X 63 1/2"	36/A5.2.2 36/A5.2.2 36/A5.2.2	40/A5.2.2	72/A5.2.2 72/A5.2.2 72/A5.2.2		
S110 S111	K K	6	44 1/2" x 94 1/2" 44 1/2" x 72 1/2"		43" x 94 1/4" 43" x 72 1/4"	36/A5.2.2 36/A5.2.2	40/A5.2.2 40/A5.2.2	72/A5.2.2 72/A5.2.2	4	WB05 WB06	A 2	1 1	26" X 63 1/2" 26" X 63 1/2"		25 1/2" X 63 1/2" 25 1/2" X 63 1/2"	36/A5.2.2 36/A5.2.2	40/A5.2.2 40/A5.2.2	72/A5.2.2 72/A5.2.2		
S112 S113	H H	7	80 1/2" x 150 1/2" 80 1/2" x 150 1/2"		39" x 105 1/4" 39" x 105 1/4"	36/A5.2.2 36/A5.2.2	40/A5.2.2 40/A5.2.2	72/A5.2.2 72/A5.2.2	4	WB07 WB08	A 4	1 1	26" X 63 1/2" 26" X 63 1/2"		25 1/2" X 63 1/2" 25 1/2" X 63 1/2"	36/A5.2.2 36/A5.2.2	40/A5.2.2 40/A5.2.2	72/A5.2.2 72/A5.2.2		
S114 S115	H H	7	80 1/2" x 150 1/2" 80 1/2" x 150 1/2"		39" x 105 1/4" 39" x 105 1/4"		40/A5.2.2 40/A5.2.2	72/A5.2.2 72/A5.2.2	4	WB09 WB10	A		26" X 63 1/2" 16 1/2" x 27"		25 1/2" X 63 1/2"	36/A5.2.2 36/A5.2.1	40/A5.2.2 40/A5.2.1	72/A5.2.2 72/A5.2.1	1	

REPLACEMENT SHOP DRAWINGS FROM 1975. FIELD VERIFY DIMENSIONS AND NOTIFY ARCHITECT OF DEVIATIONS FROM THESE DOCUMENTS.

SIOUX FALLS COURTHOUSE IRA WINDOW REPLACEMENT

400 SOUTH PHILLIPS AVE SIOUX FALLS, SOUTH DAKOTA 57104

SMITHGROUP

500 GRISWOLD SUITE 1700 DETROIT, MI 48226 313.983.3600 smithgroup.com

_____ _____ _____ _____ ____ ____ _____ _____
 CONSTRUCTION SET
 5
 12/06/2024
 100% FINAL DESIGN SUBMITTAL 4 04/02/2024 95% PRE-FINAL DESIGN SUBMITTAL 3 12/26/2023 65% MID-POINT DESIGN SUBMITTAL 2 10/20/2023 <u>35% CONCEPTUAL DESIGN</u> <u>1</u> <u>07/29/2022</u> SUBMITTAL SEALS AND SIGNATURES

REV DATE

ISSUED FOR

WINDOW SCHEDULE

PROJECT NUMBER

SHEET NUMBER

REMARKS:


1. OWNER PROVIDED DOCUMENT, SHOP DRAWING FOR EXISTING WINDOWS, DO NOT DEPICT THE EXISTENCE OF THE ORIGINAL HISTORIC WOOD FRAME.


2. FIXED, BALLISTIC


3. INTERIOR GLAZED


4. EXTERIOR GLAZED




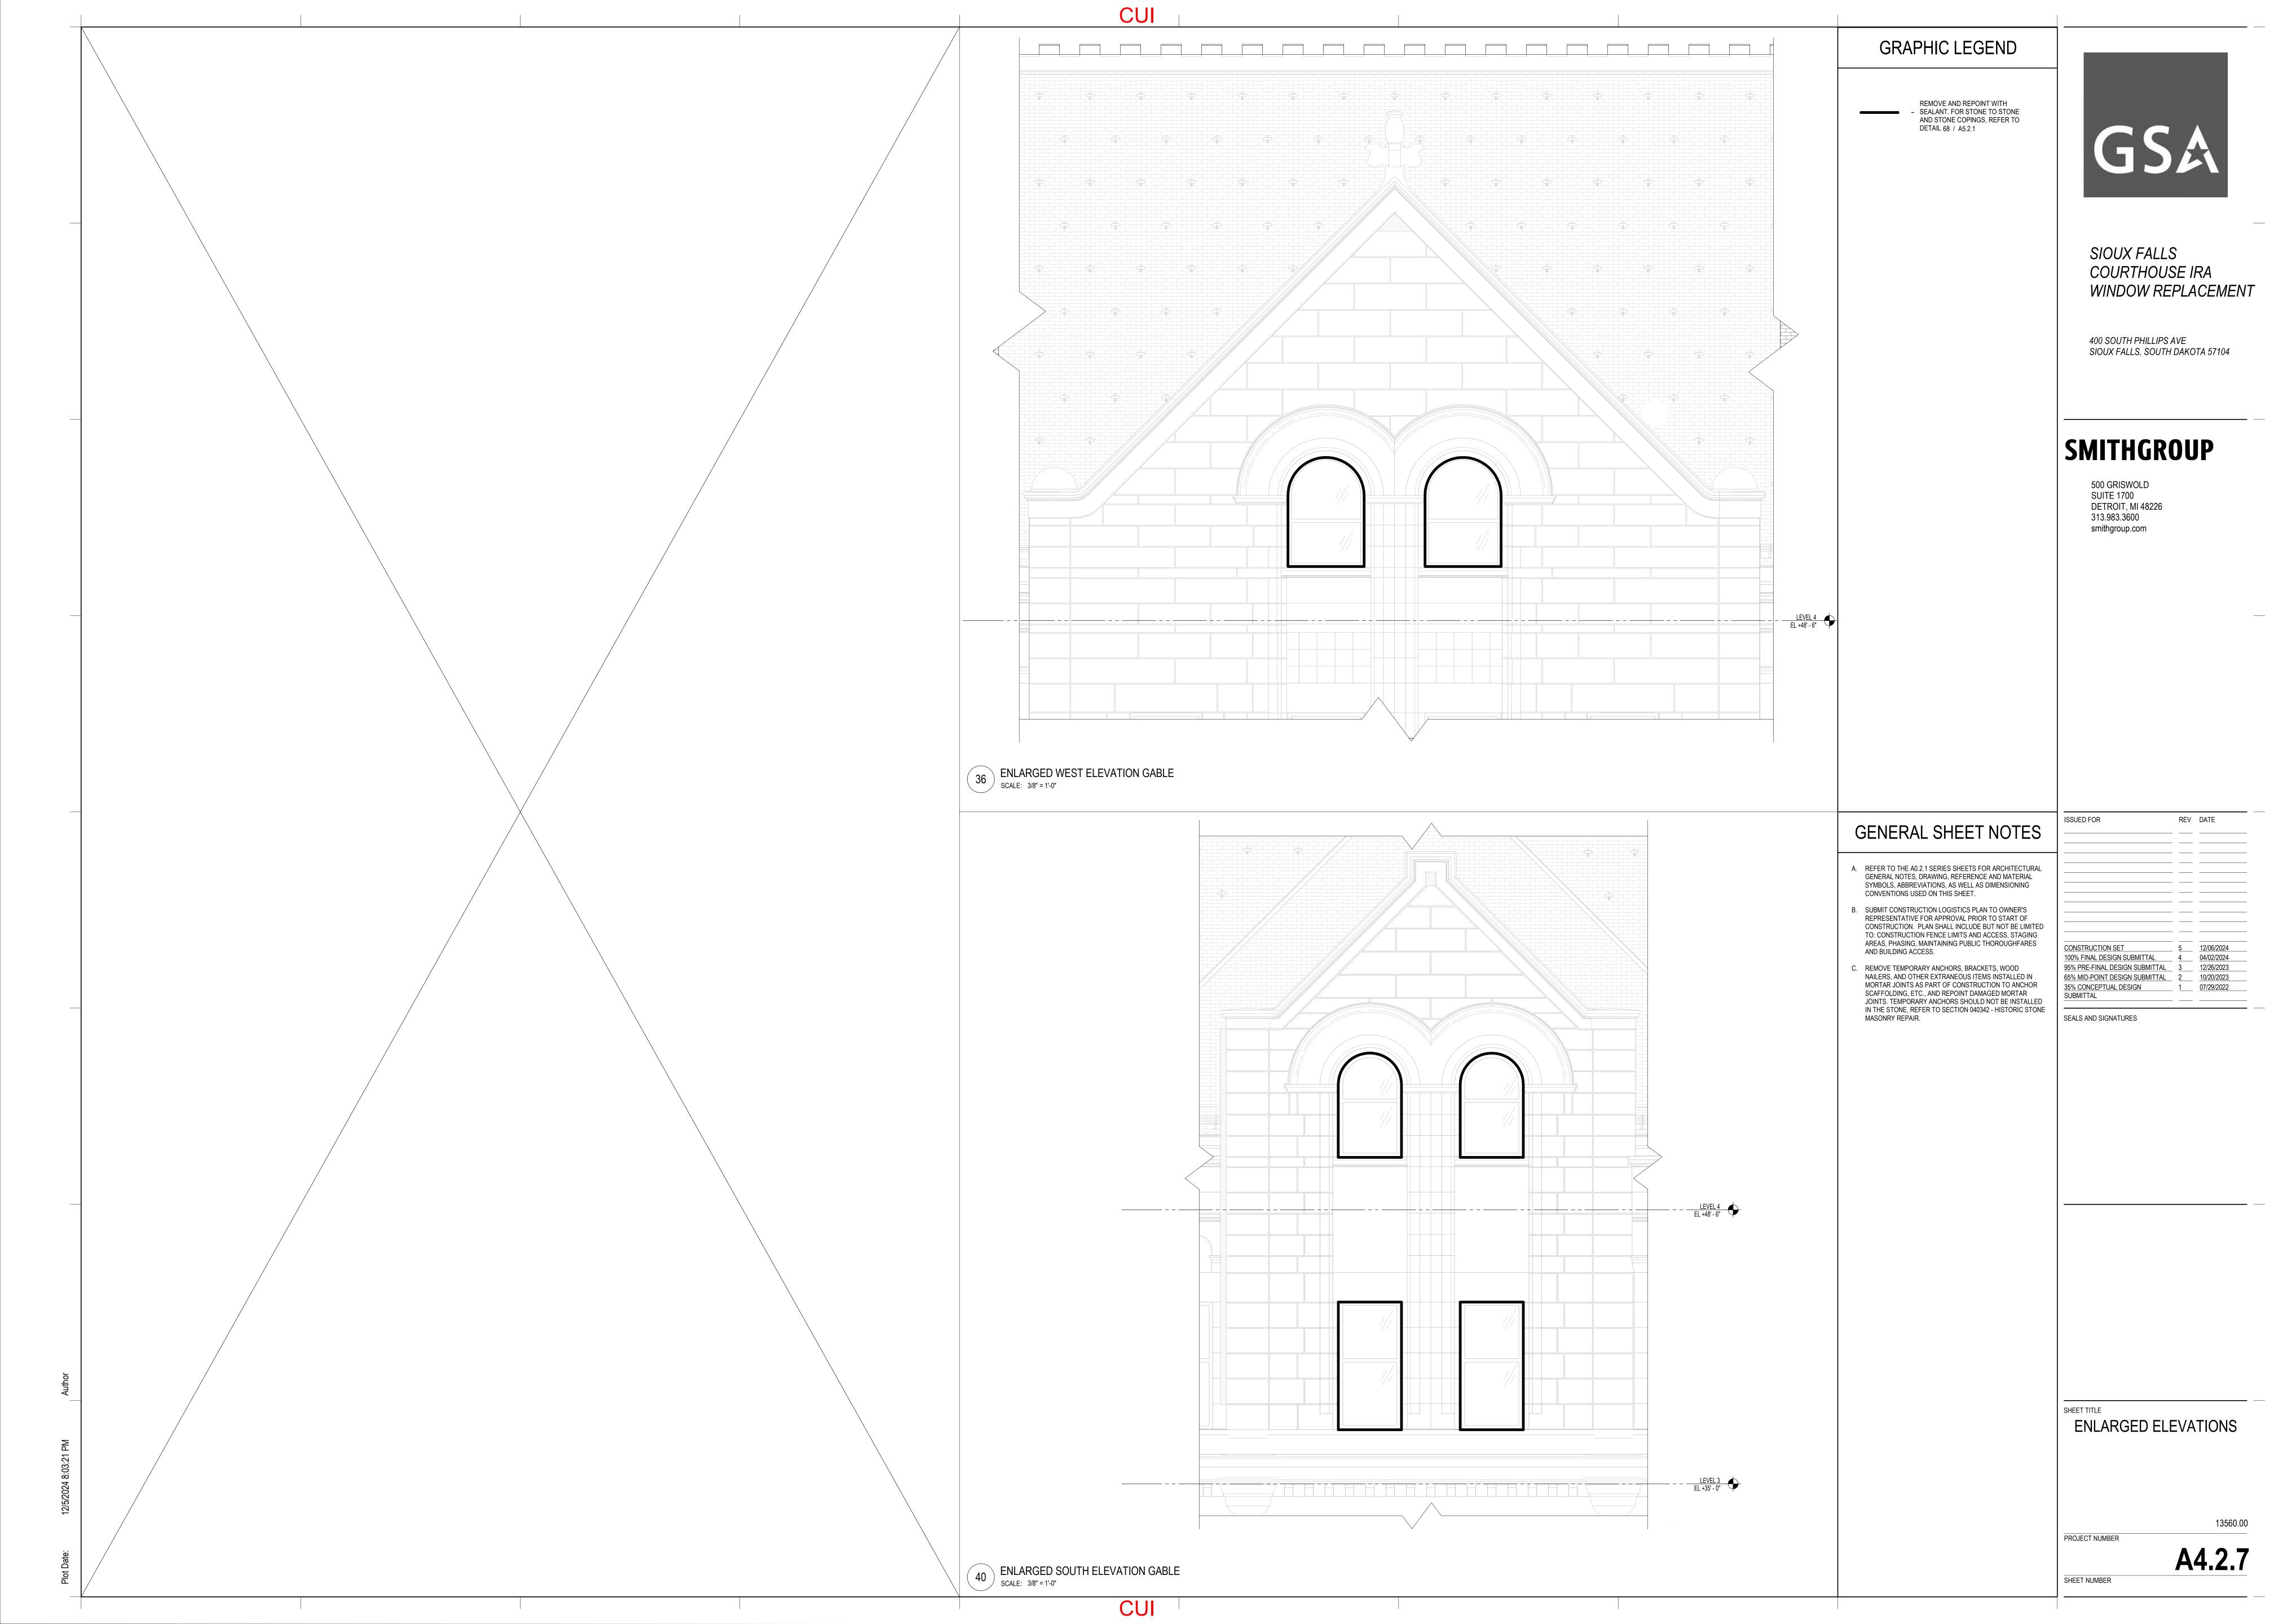


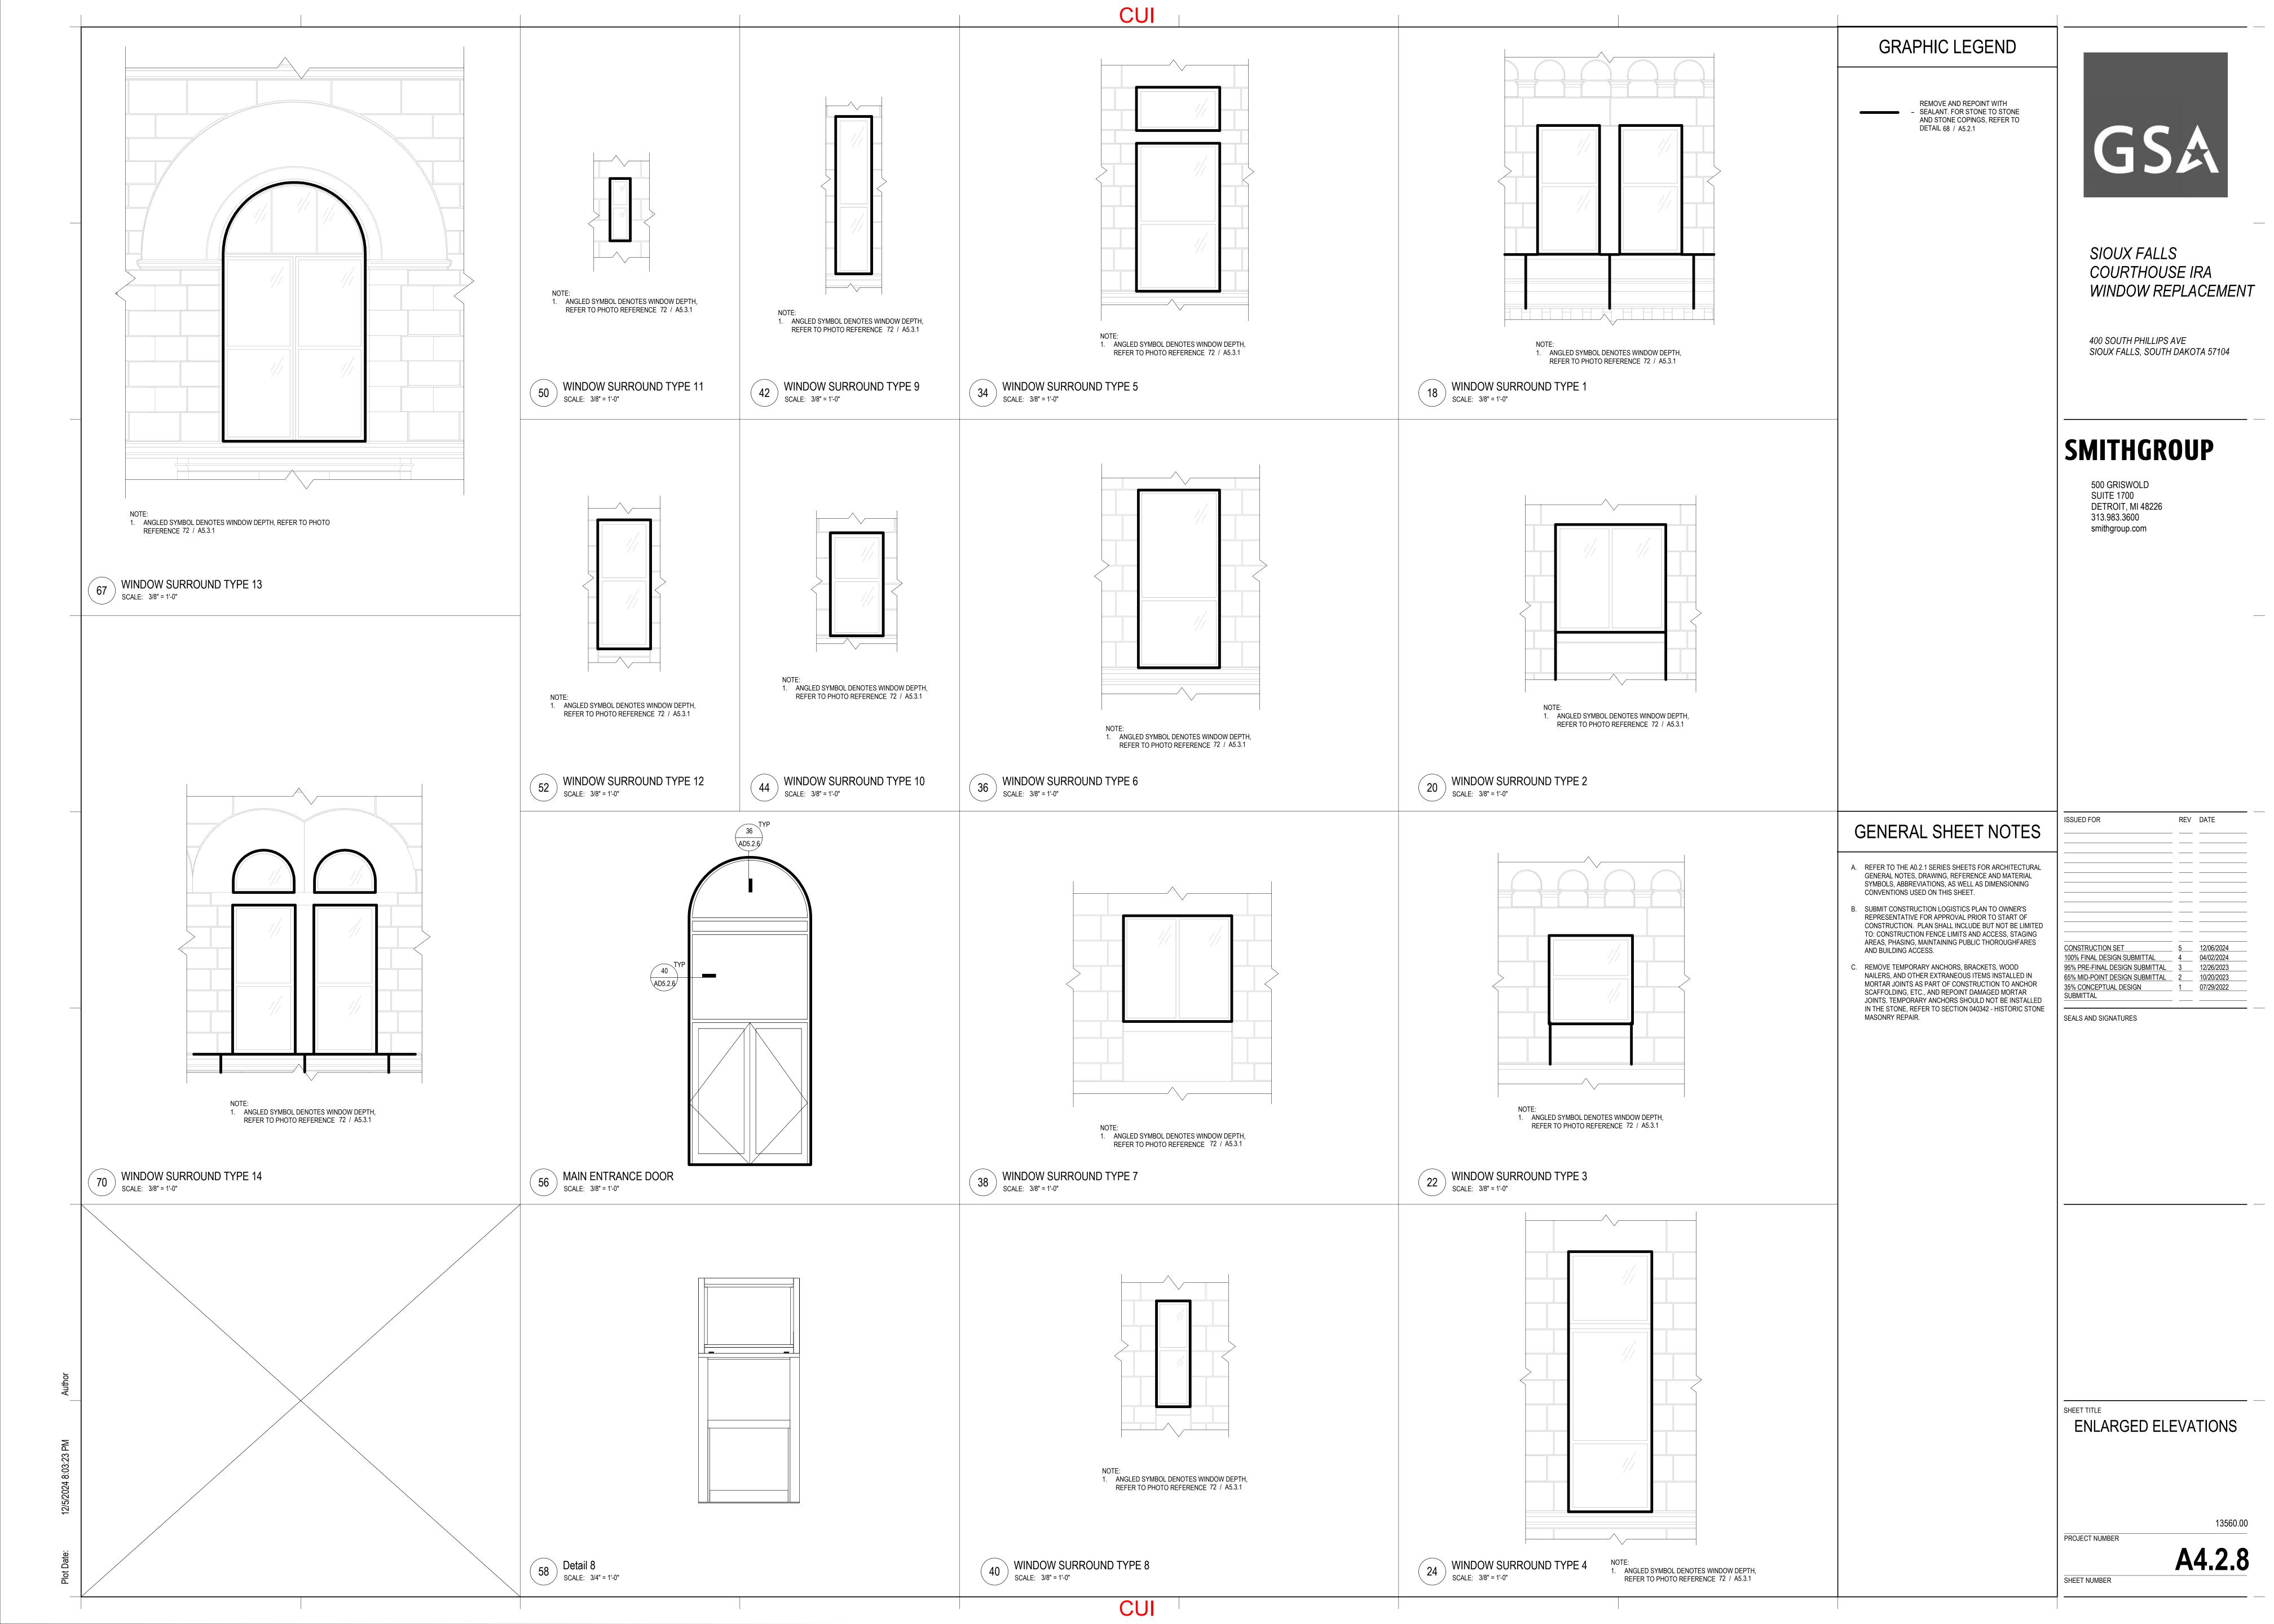

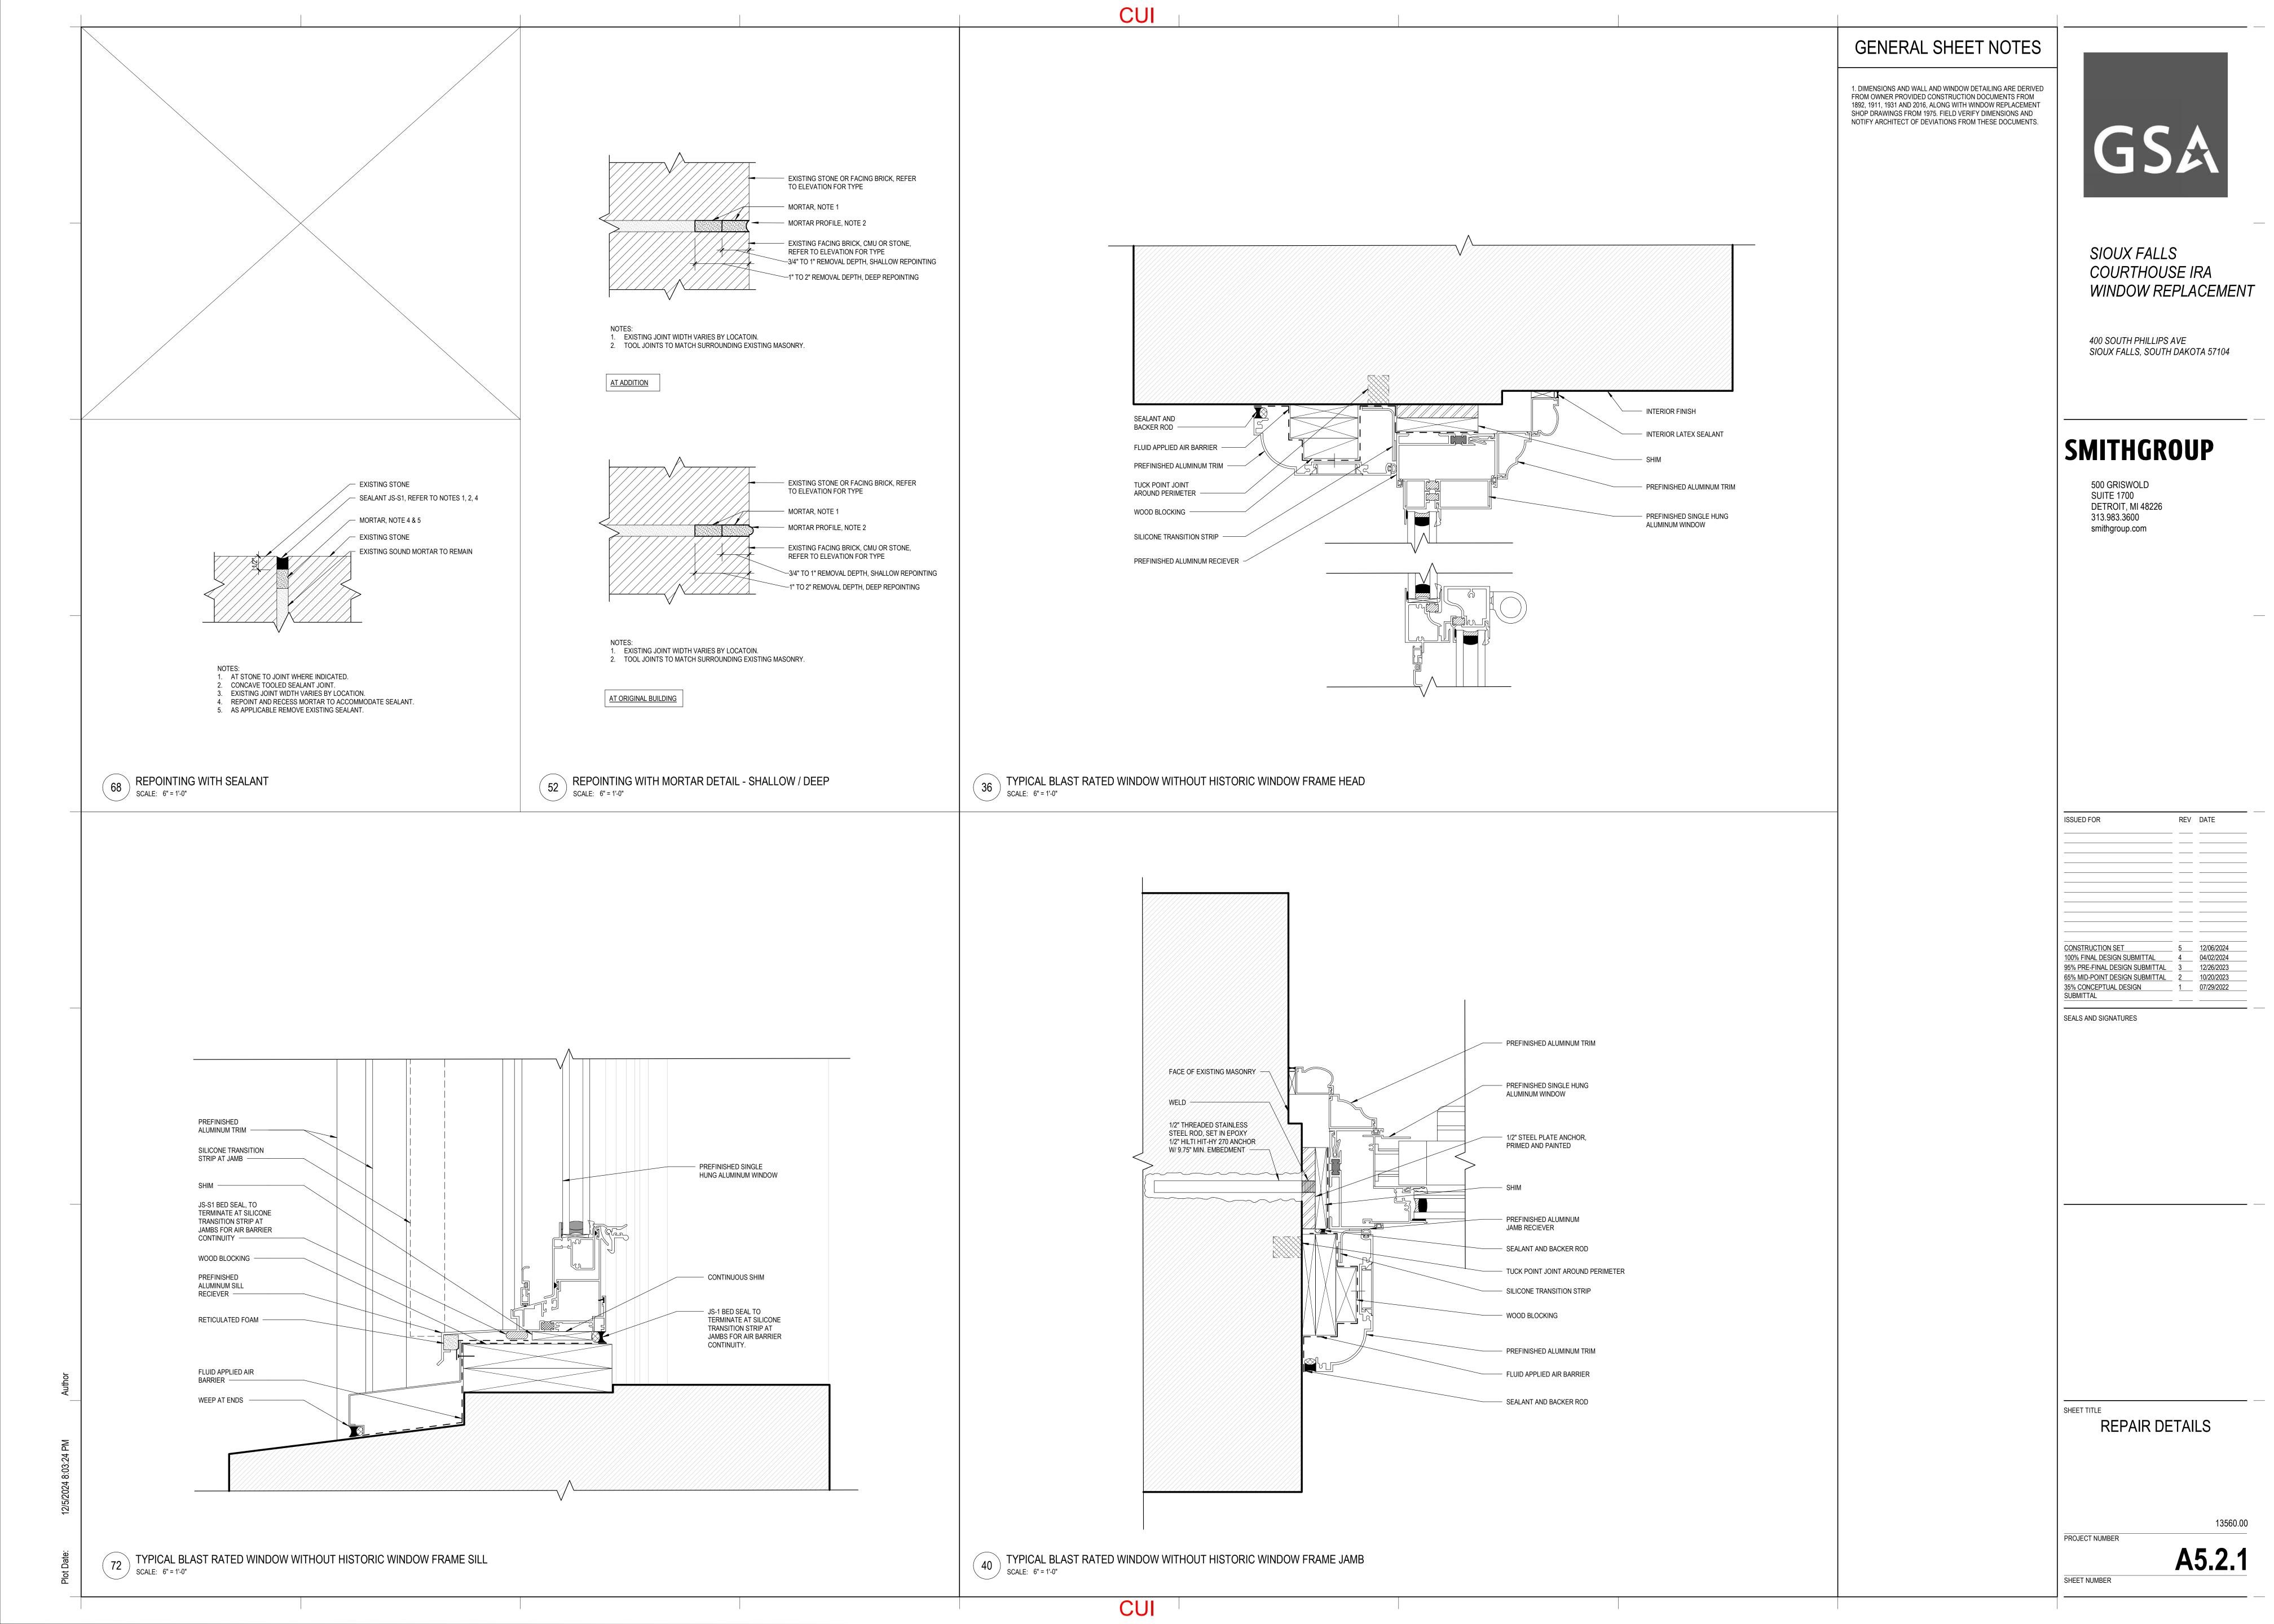

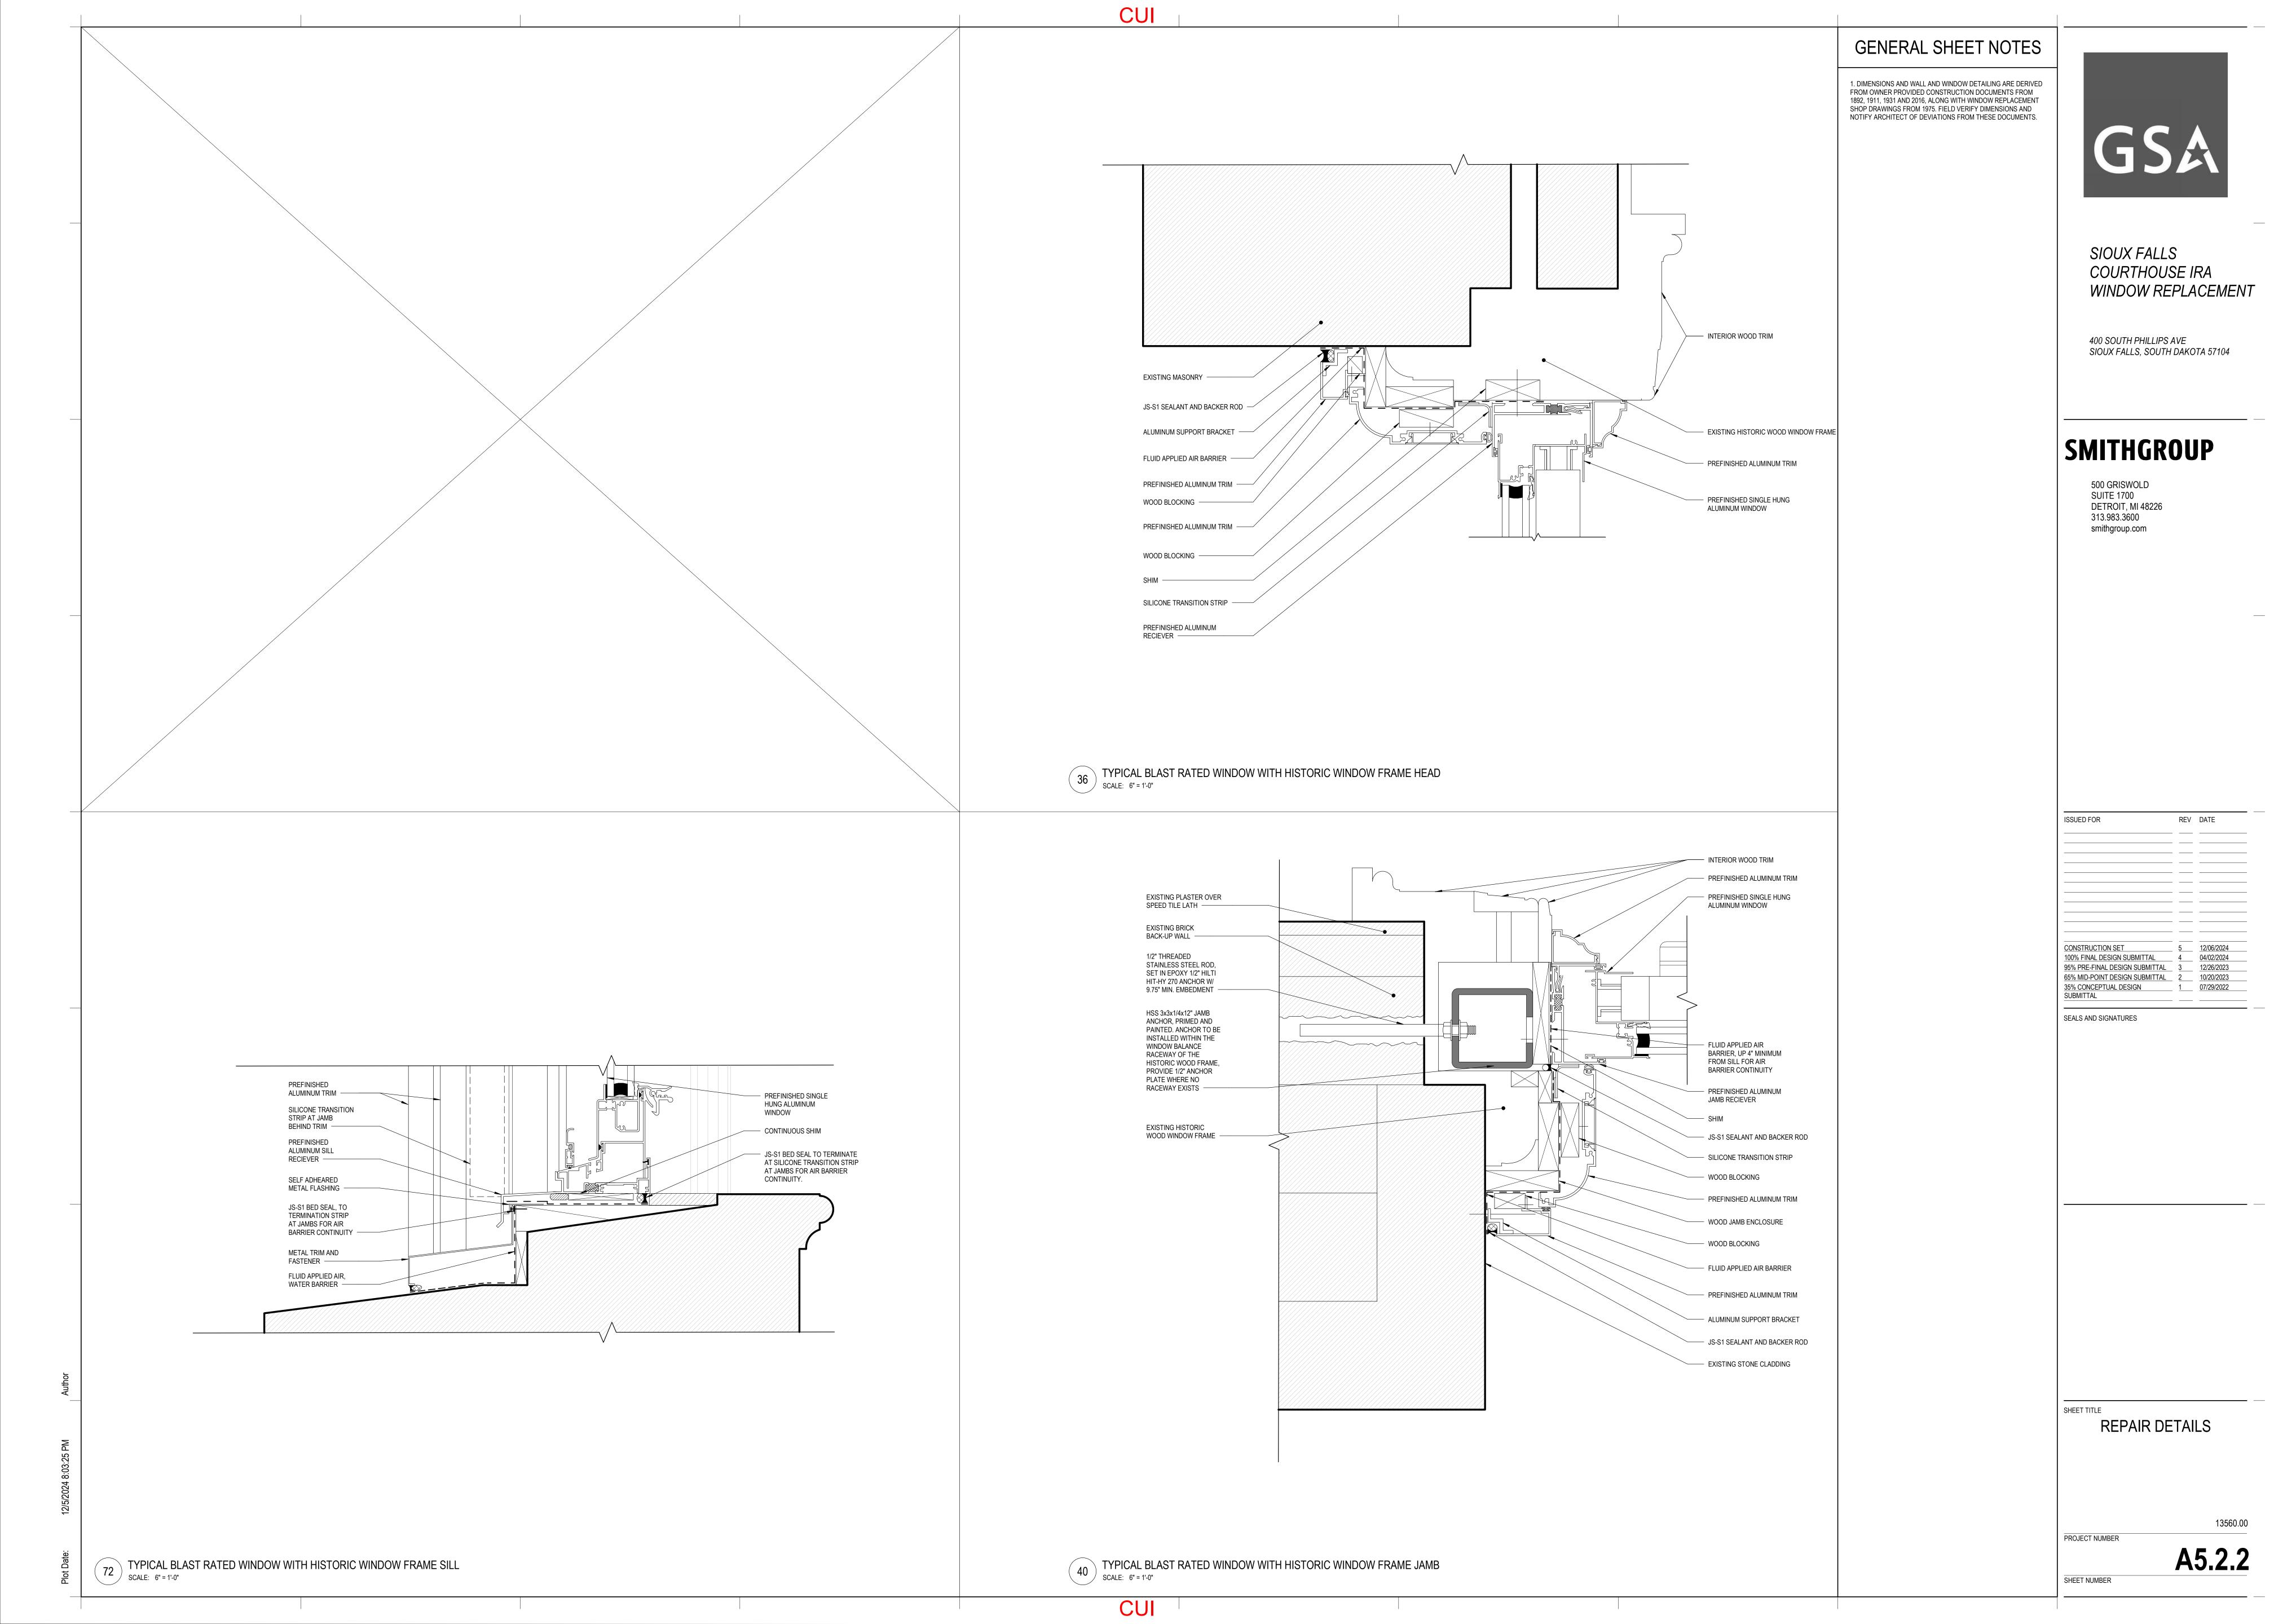

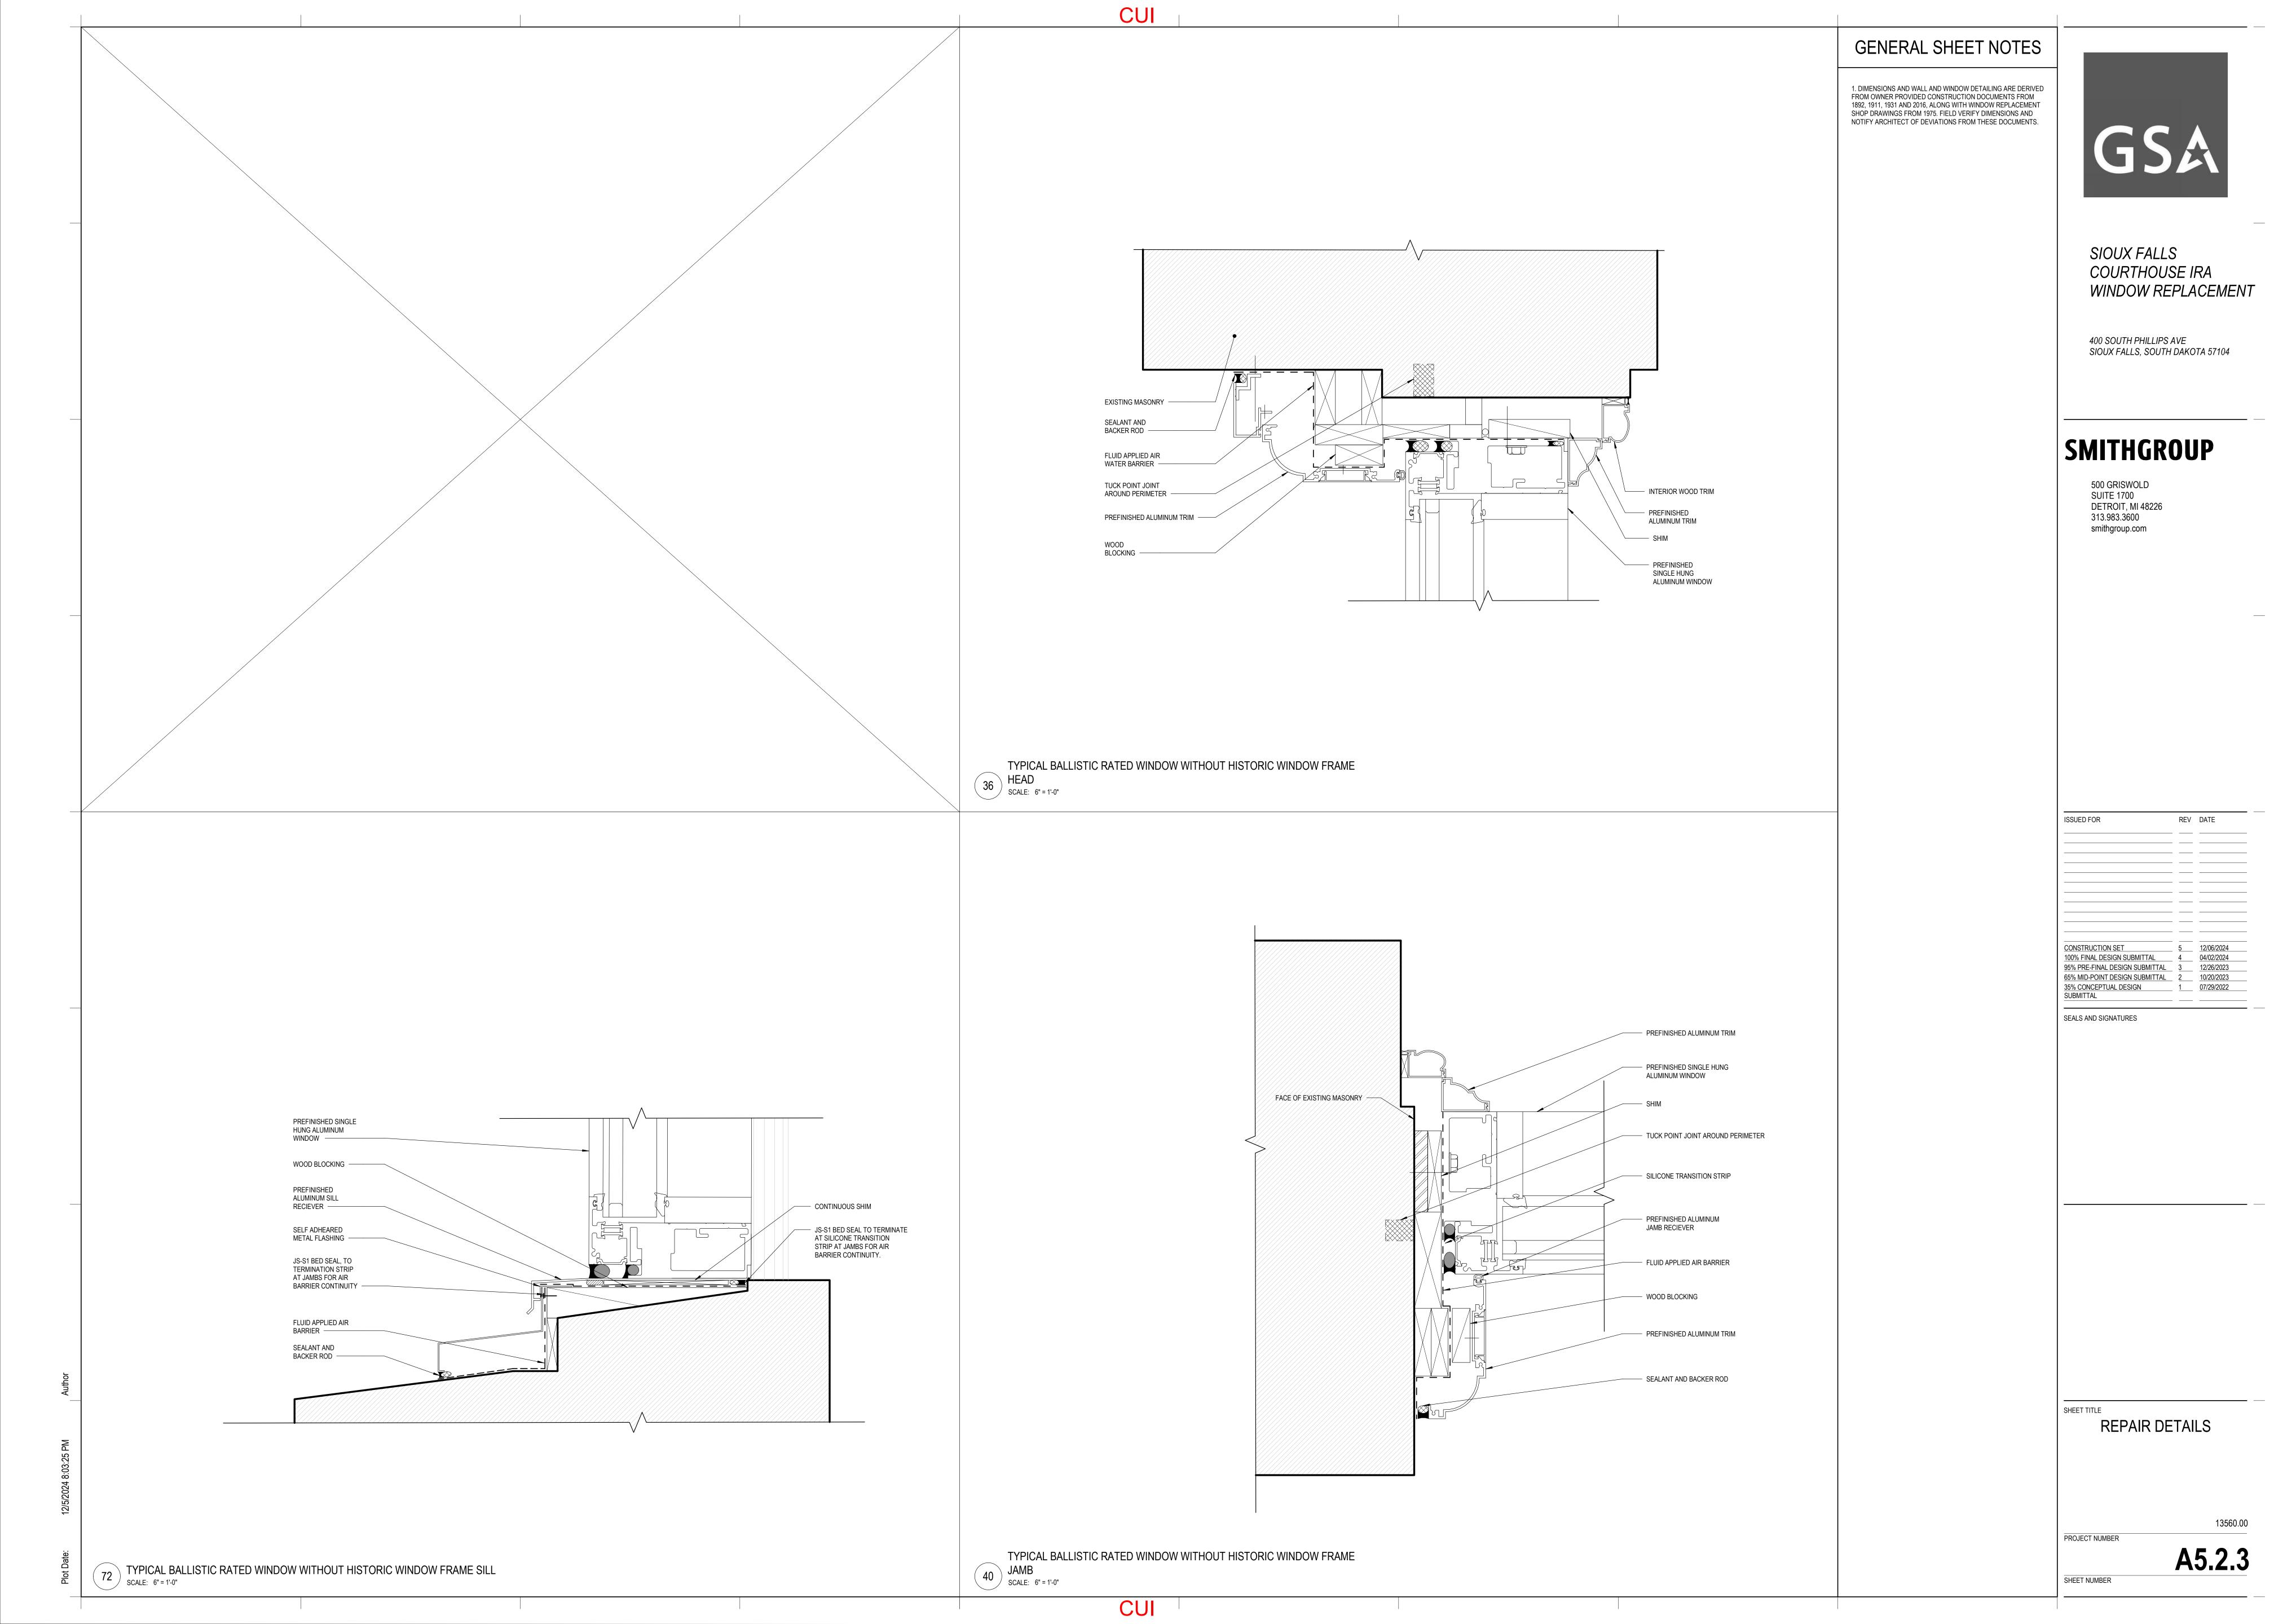

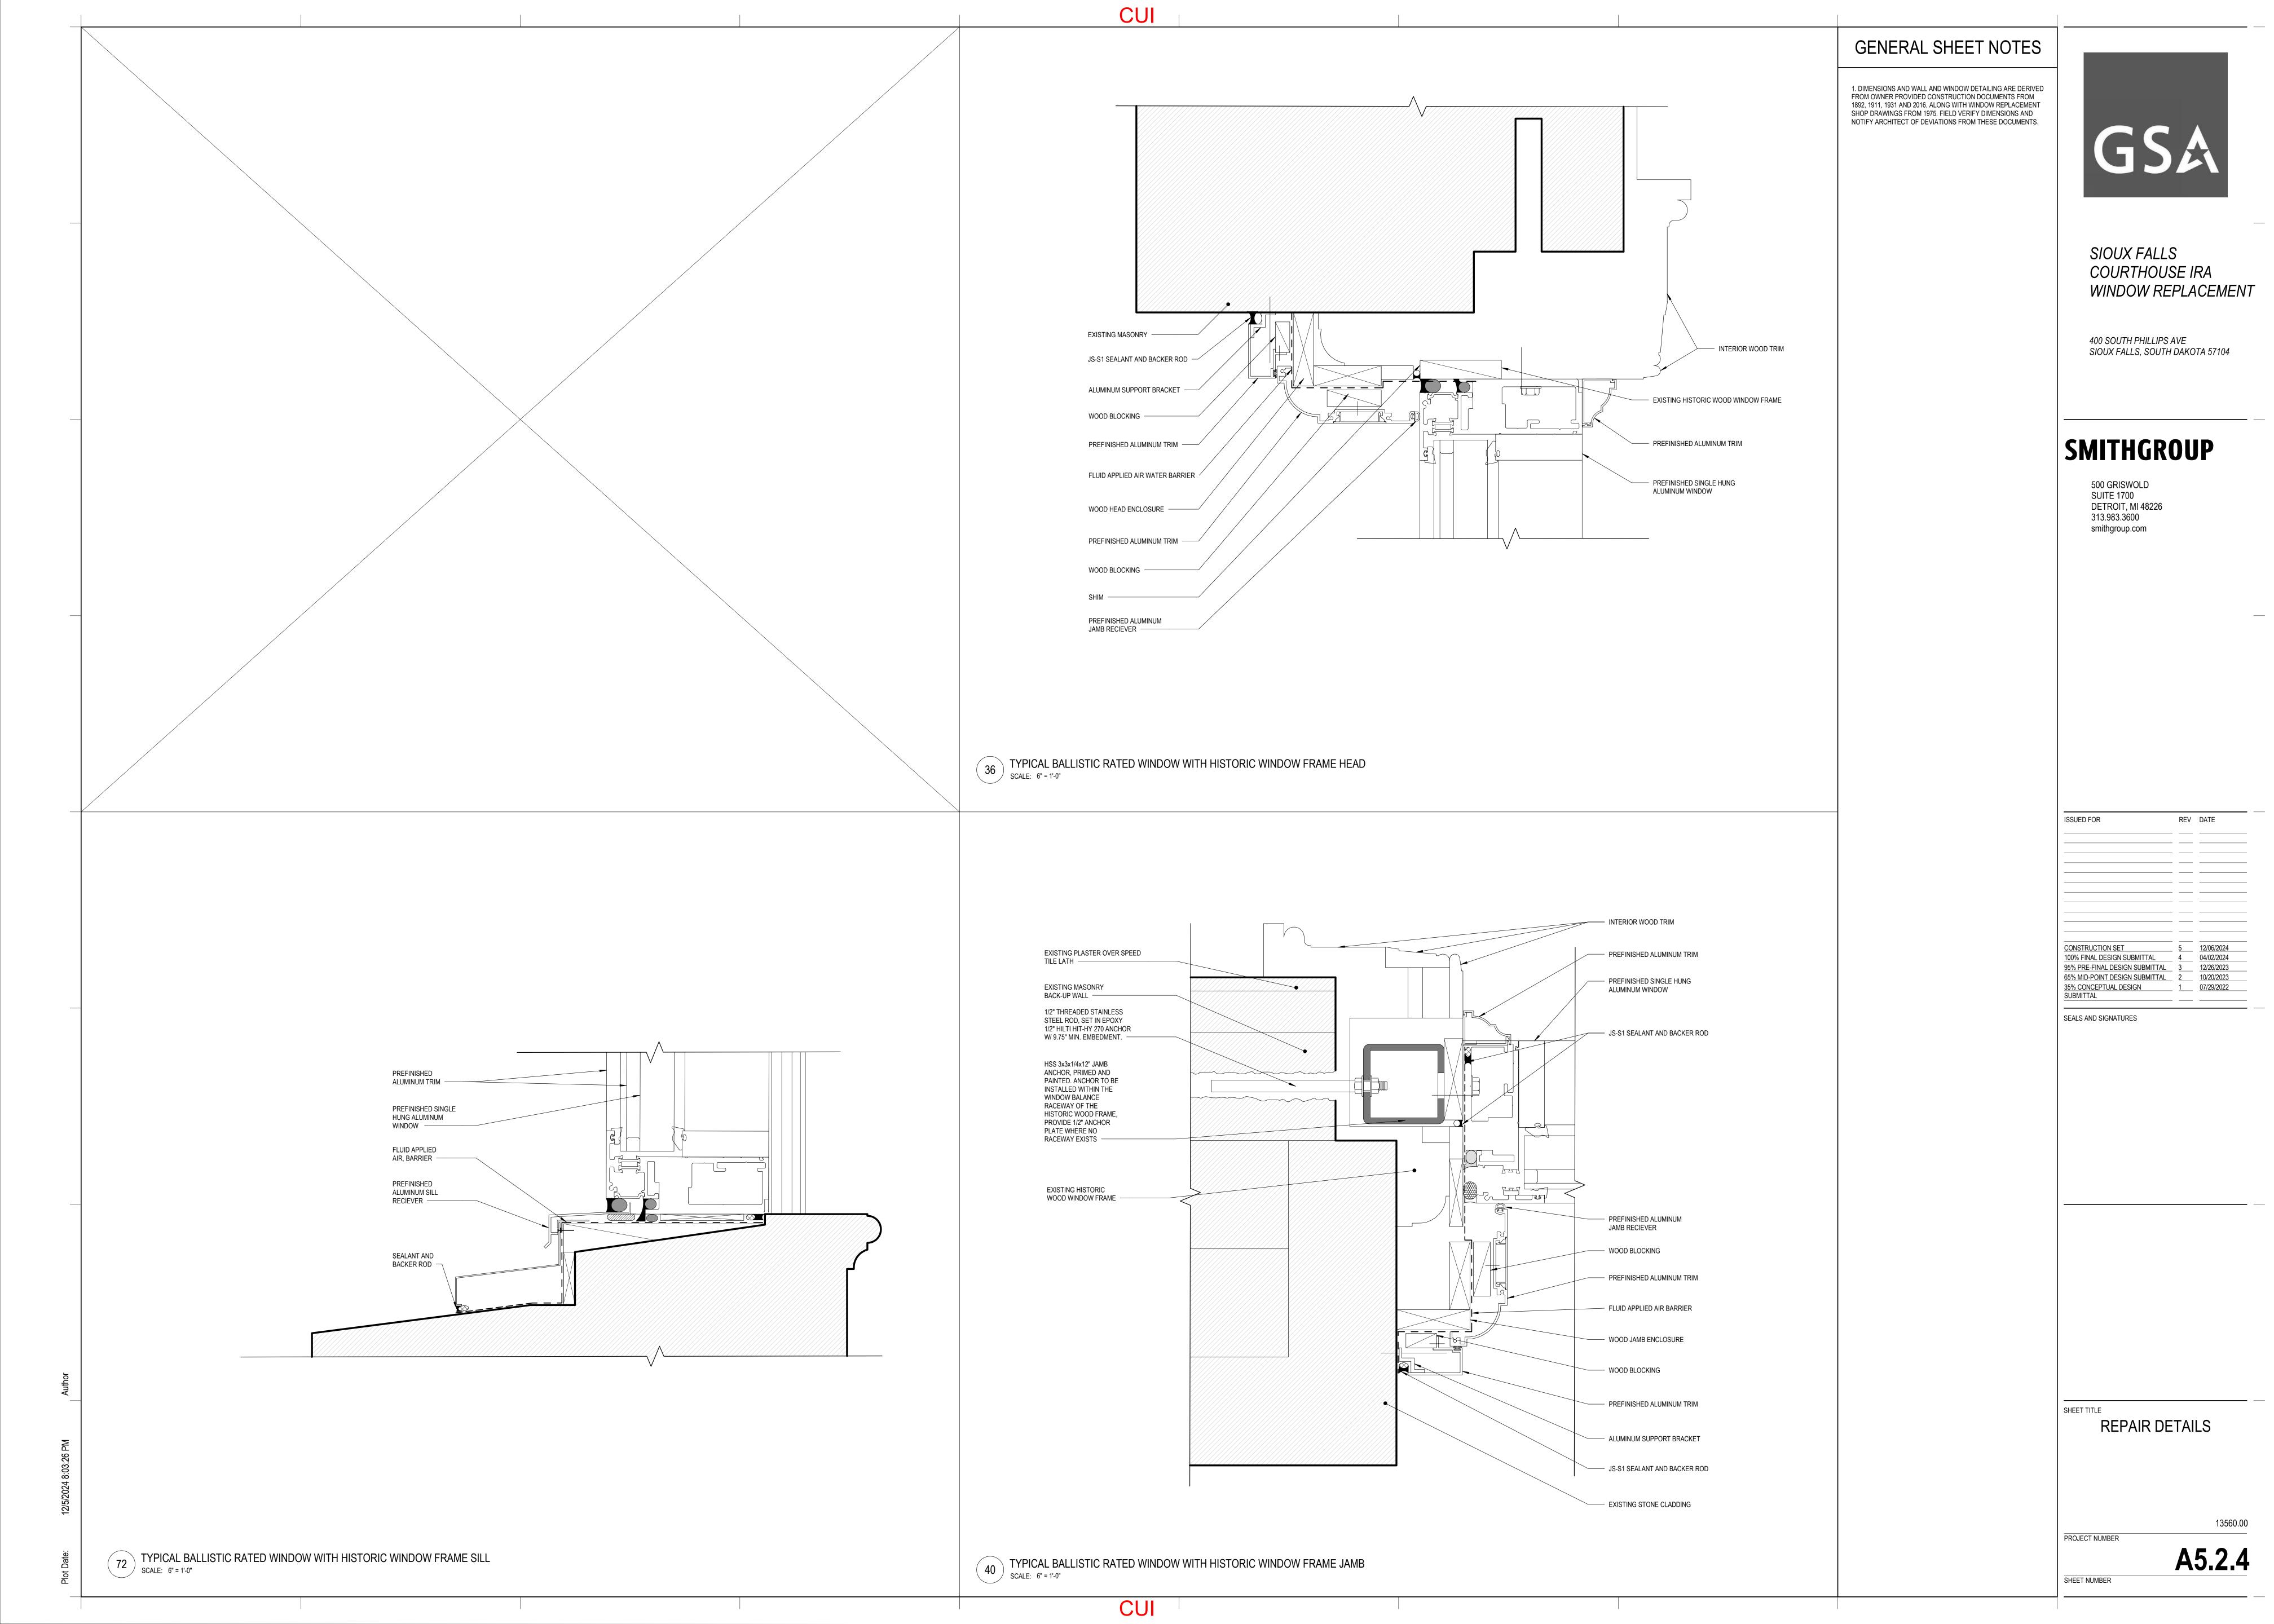



SIOUX FALLS COURTHOUSE IRA WINDOW REPLACEMENT


400 SOUTH PHILLIPS AVE SIOUX FALLS, SOUTH DAKOTA 57104

SMITHGROUP

500 GRISWOLD SUITE 1700 DETROIT, MI 48226 313.983.3600 smithgroup.com



FIRST FLOOR WINDOW DEMO HEAD CONDITION - AT WEST ELEVATION SCALE: 3" = 1'-0"

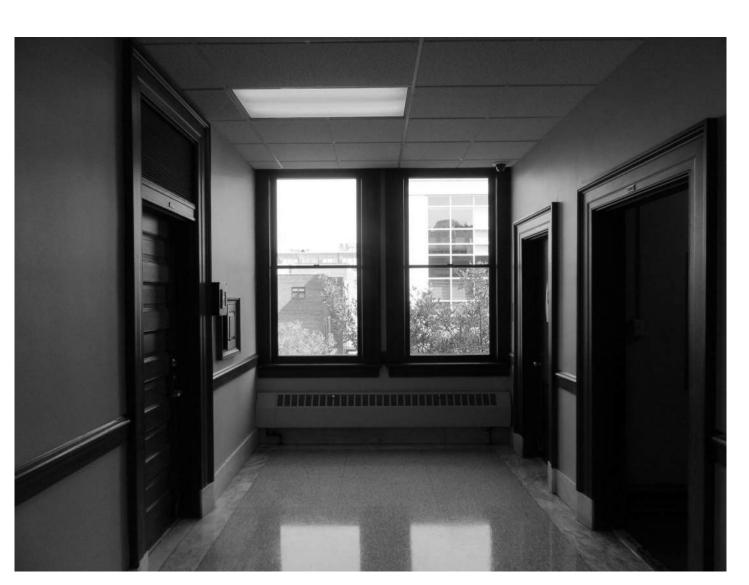


69 EXISTING WINDOW TYP J INT.

SCALE: 1 1/2" = 1'-0"



TYPICAL ARCHED WINDOW - PHOTO REFERENCE SCALE: 3" = 1'-0"

55 EXISTING WINDOW TYP. J EXT. SCALE: 1 1/2" = 1'-0"

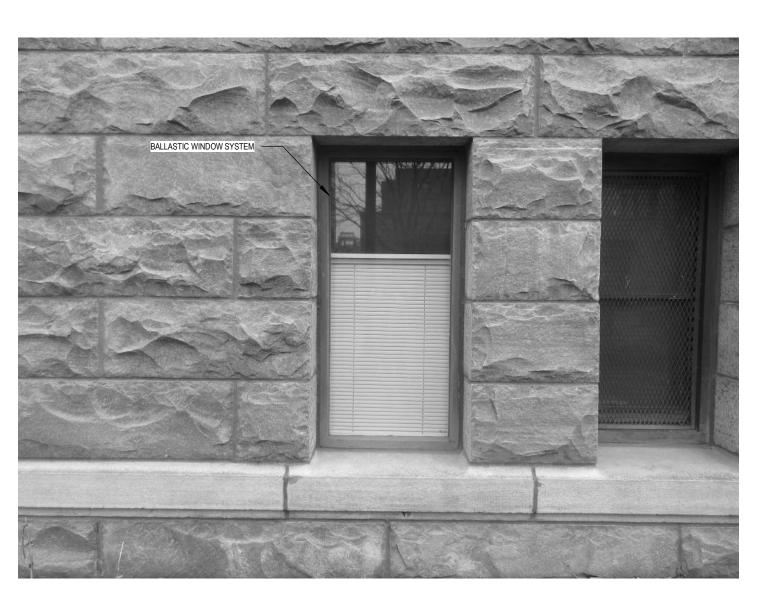

SECOND FLOOR WINDOW DEMO SILL CONDITION - AT EAST ELEVATION SCALE: 3" = 1'-0"

WINDOW WITH BALLISTIC GLASS - REFERENCE PHOTO SCALE: 3" = 1'-0"



FIRST FLOOR WINDOW DEMO SILL CONDITION - AT WEST ELEVATION SCALE: 3" = 1'-0"



72 EXISTING WINDOW TYP. G INT. SCALE: 1 1/2" = 1'-0"



56 EXISTING WINDOW TYP. G EXT. SCALE: 1 1/2" = 1'-0"



TYPICAL WINDOW WITH TRANSOM - REFERENCE PHOTO SCALE: 3" = 1'-0"



SECOND FLOOR WINDOW DEMO HEAD CONDITION - AT EAST ELEVATION SCALE: 3" = 1'-0"

ISSUED FOR	REV	DATE
		-
		-
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	-	
CONSTRUCTION SET	5	12/06/2024
100% FINAL DESIGN SUBMITTAL	4	04/02/2024
95% PRE-FINAL DESIGN SUBMITTAL	3	12/26/2023
65% MID-POINT DESIGN SUBMITTAL	2	10/20/2023
35% CONCEPTUAL DESIGN	1	07/29/2022
SUBMITTAL		

SEALS AND SIGNATU

REFERENCE PHOTOS - WINDOWS

PROJECT NUMBER

A5.2.5SHEET NUMBER



66 EXISTING WINDOW TYP. I EXT. SCALE: 1 1/2" = 1'-0"



EXISTING WINDOW TYP. I INT.

SCALE: 1 1/2" = 1'-0"



SCALE: 1 1/2" = 1'-0"



18 EXISTING WINDOW TYPE H EXT.

SCALE: 1 1/2" = 1'-0"



69 EXISTING WINDOW TYP. E EXT. SCALE: 1 1/2" = 1'-0"



EXISTING WINDOW TYP D EXT.

SCALE: 1 1/2" = 1'-0"




37 EXISTING WINDOW TYP. K EXT. SCALE: 1 1/2" = 1'-0"



EXISTING WINDOW TYP. B EXT.

SCALE: 1 1/2" = 1'-0"

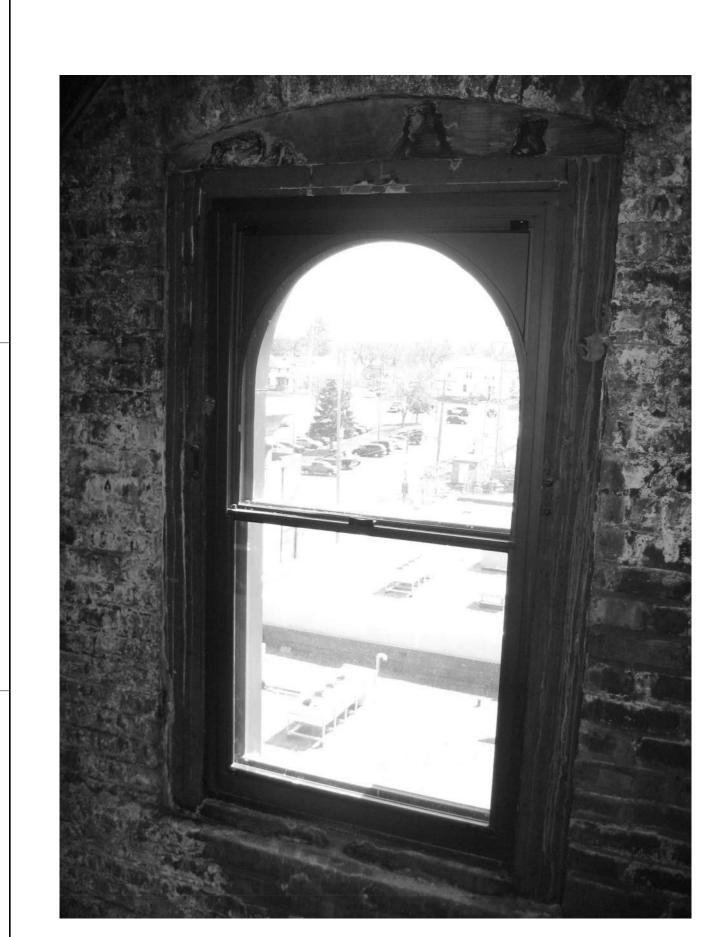

72 EXISTING WINDOW TYP E INT.

SCALE: 1 1/2" = 1'-0"



56 EXISTING WINDOW TYP. D INT.

SCALE: 1 1/2" = 1'-0"



EXISTING WINDOW TYP. B INT. SCALE: 1 1/2" = 1'-0"



SIOUX FALLS COURTHOUSE IRA WINDOW REPLACEMENT

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SSUED FOR	REV	DATE
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	- —	
	-	
CONSTRUCTION SET	5	12/06/2024
100% FINAL DESIGN SUBMITTAL	4	04/02/2024
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65% MID-POINT DESIGN SUBMITTAL	2	10/20/2023
35% CONCEPTUAL DESIGN	1	07/29/2022
SUBMITTAL		
SEALS AND SIGNATURES		

REFRENCE PHOTOS - WINDOWS

PROJECT NUMBER

A5.2.6SHEET NUMBER