



Drawing Title Project Title Project Number CONSULTANT ARCHITECT/ENGINEER OF RECORD | STAMP Office of 438-460 MOUNTING HEIGHTS CONSTRUCT NEW SPS BID DOCUMENTS Construction I hereby certify that this plan, specification or report was prepared by me or under my direct supervision and that I am a duly Licensed Architect under the laws of the State of Minnesota. Building Number and Facilities ANDERSON Drawing Number Name: Janoco Management Sioux Falls, SD. FULLY SPRINKLERED Checked Drawn 13605 1st Ave. N. #100 Plymouth, MN 55441 P 763.412.4000 | F 763.412.4090 | ae-mn.com AE640 VA U.S. Department of Veterans Affairs Date: 02/14/2025 02/14/2025 GJB License Number: 18157 Revisions: Anderson Engineering of Minnesota, LLC | Proj # 16584 VA FORM 08 - 6231

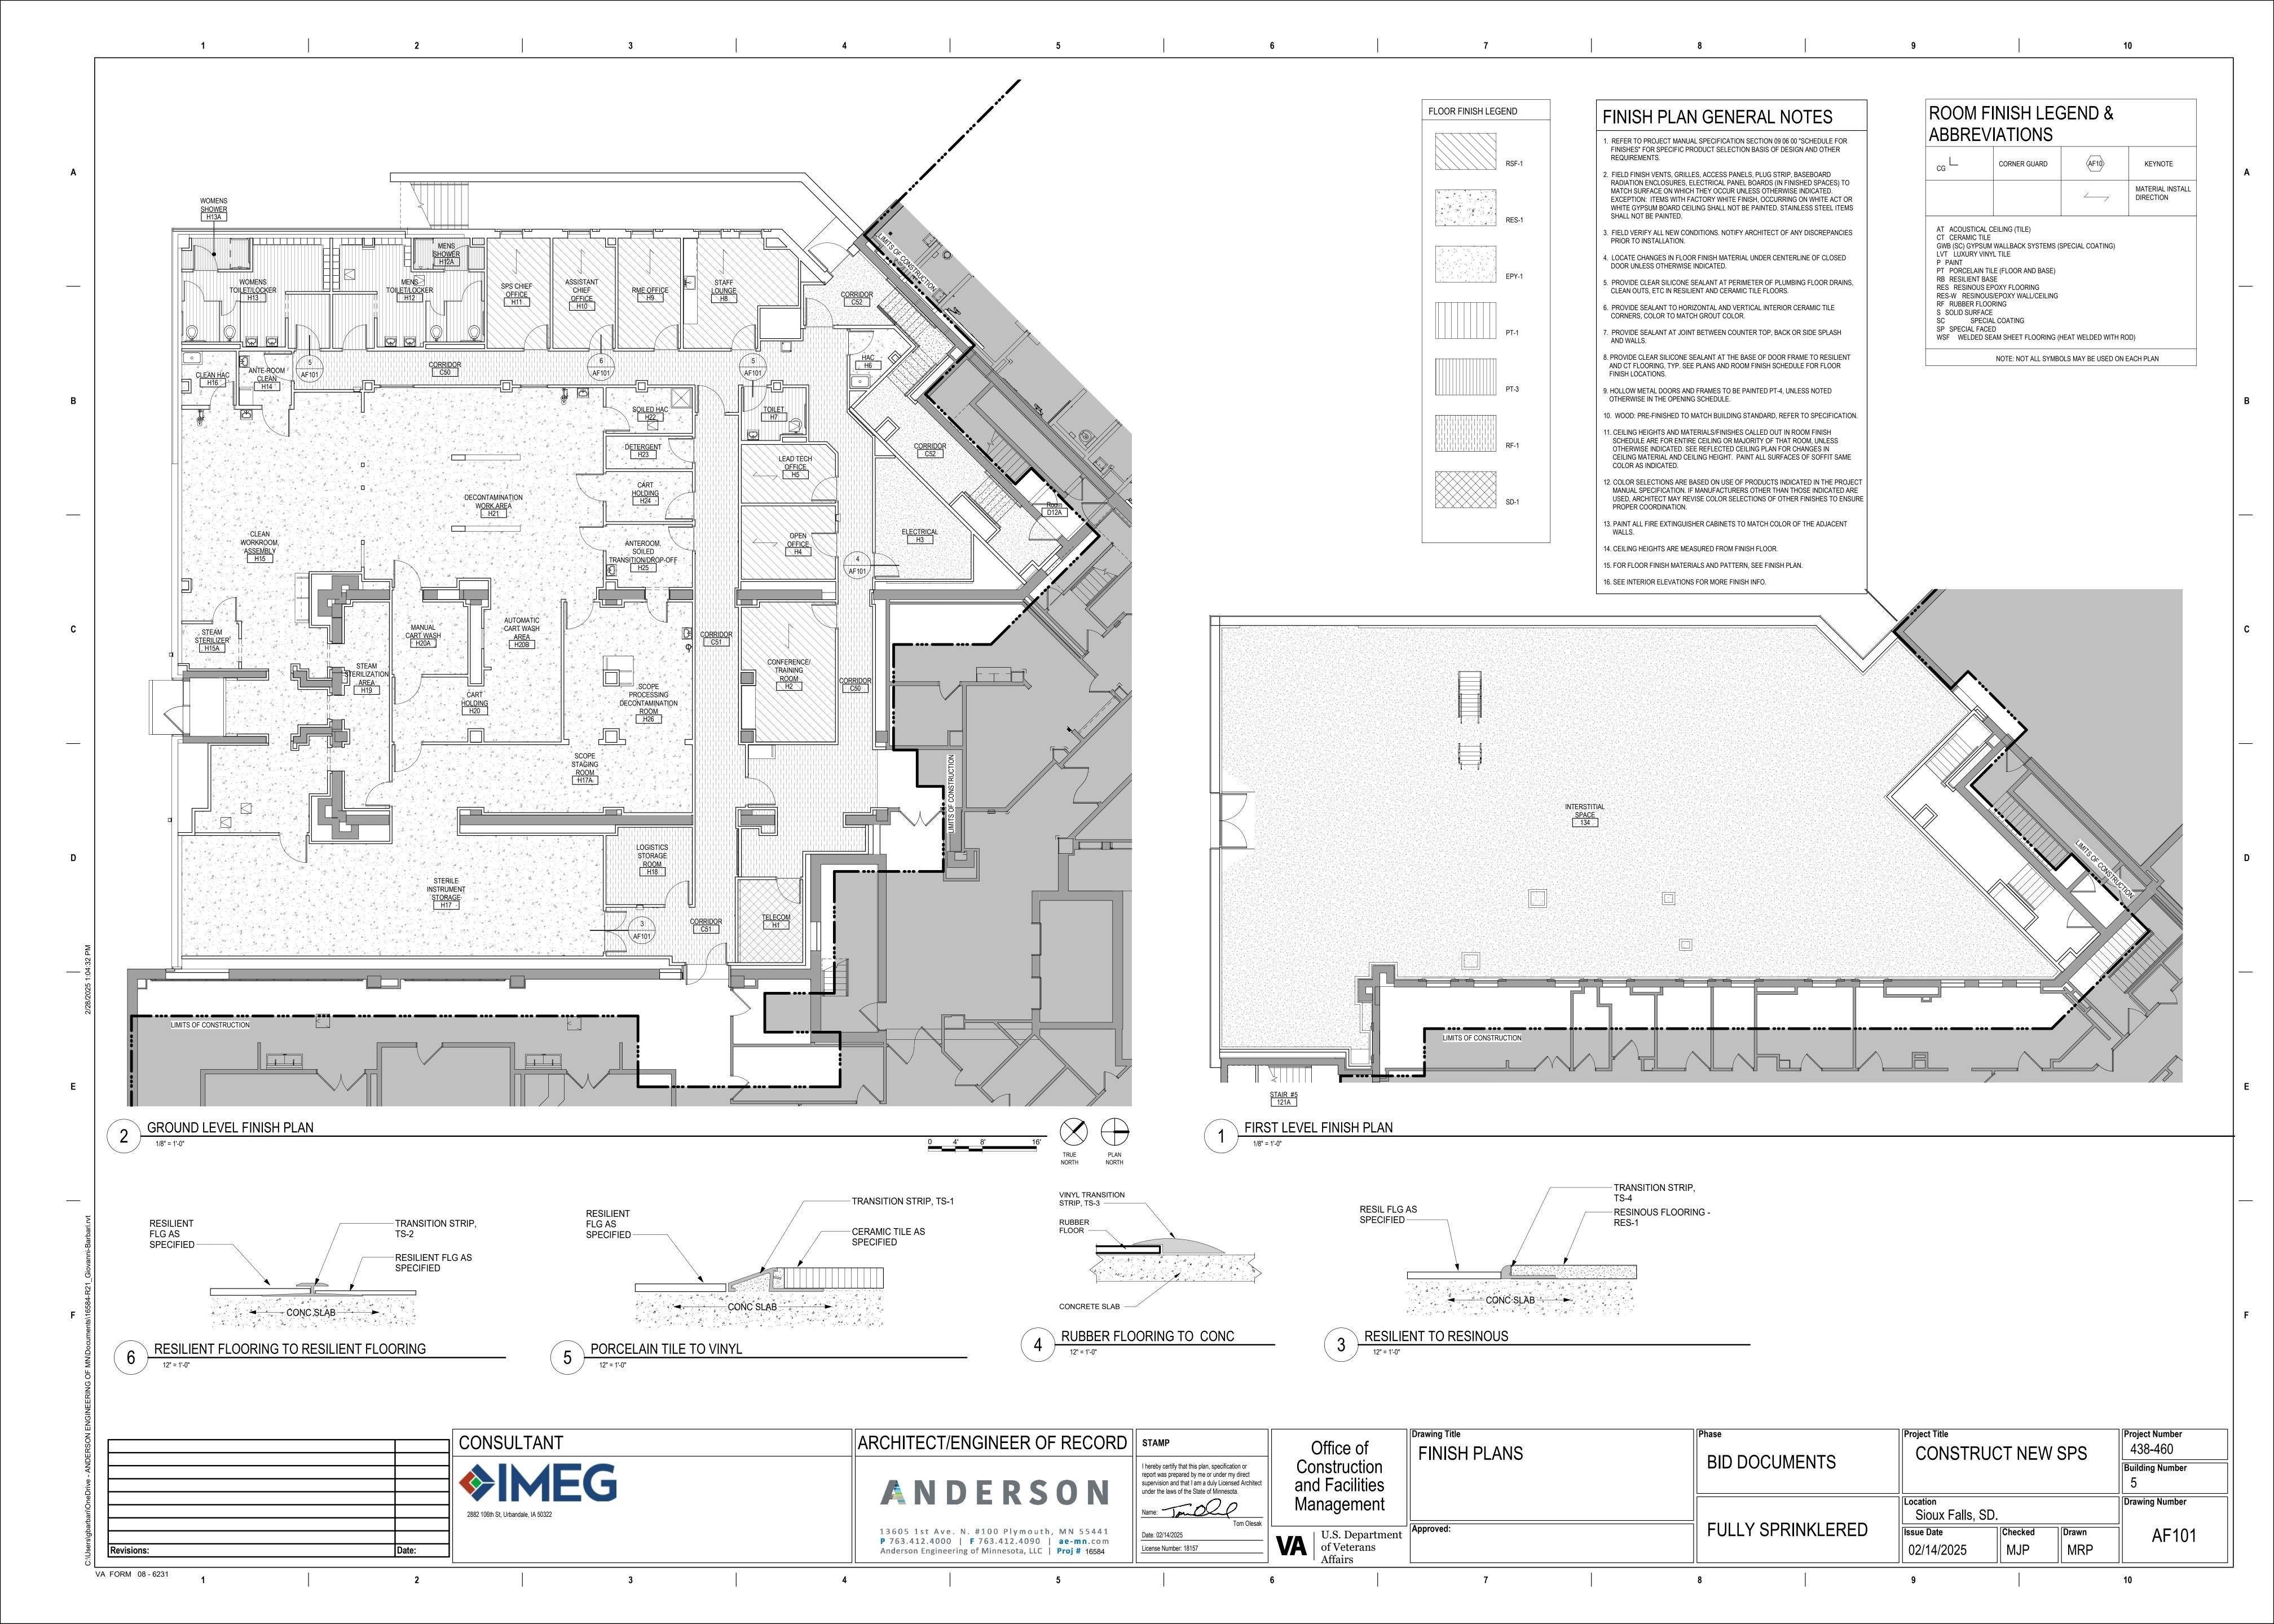

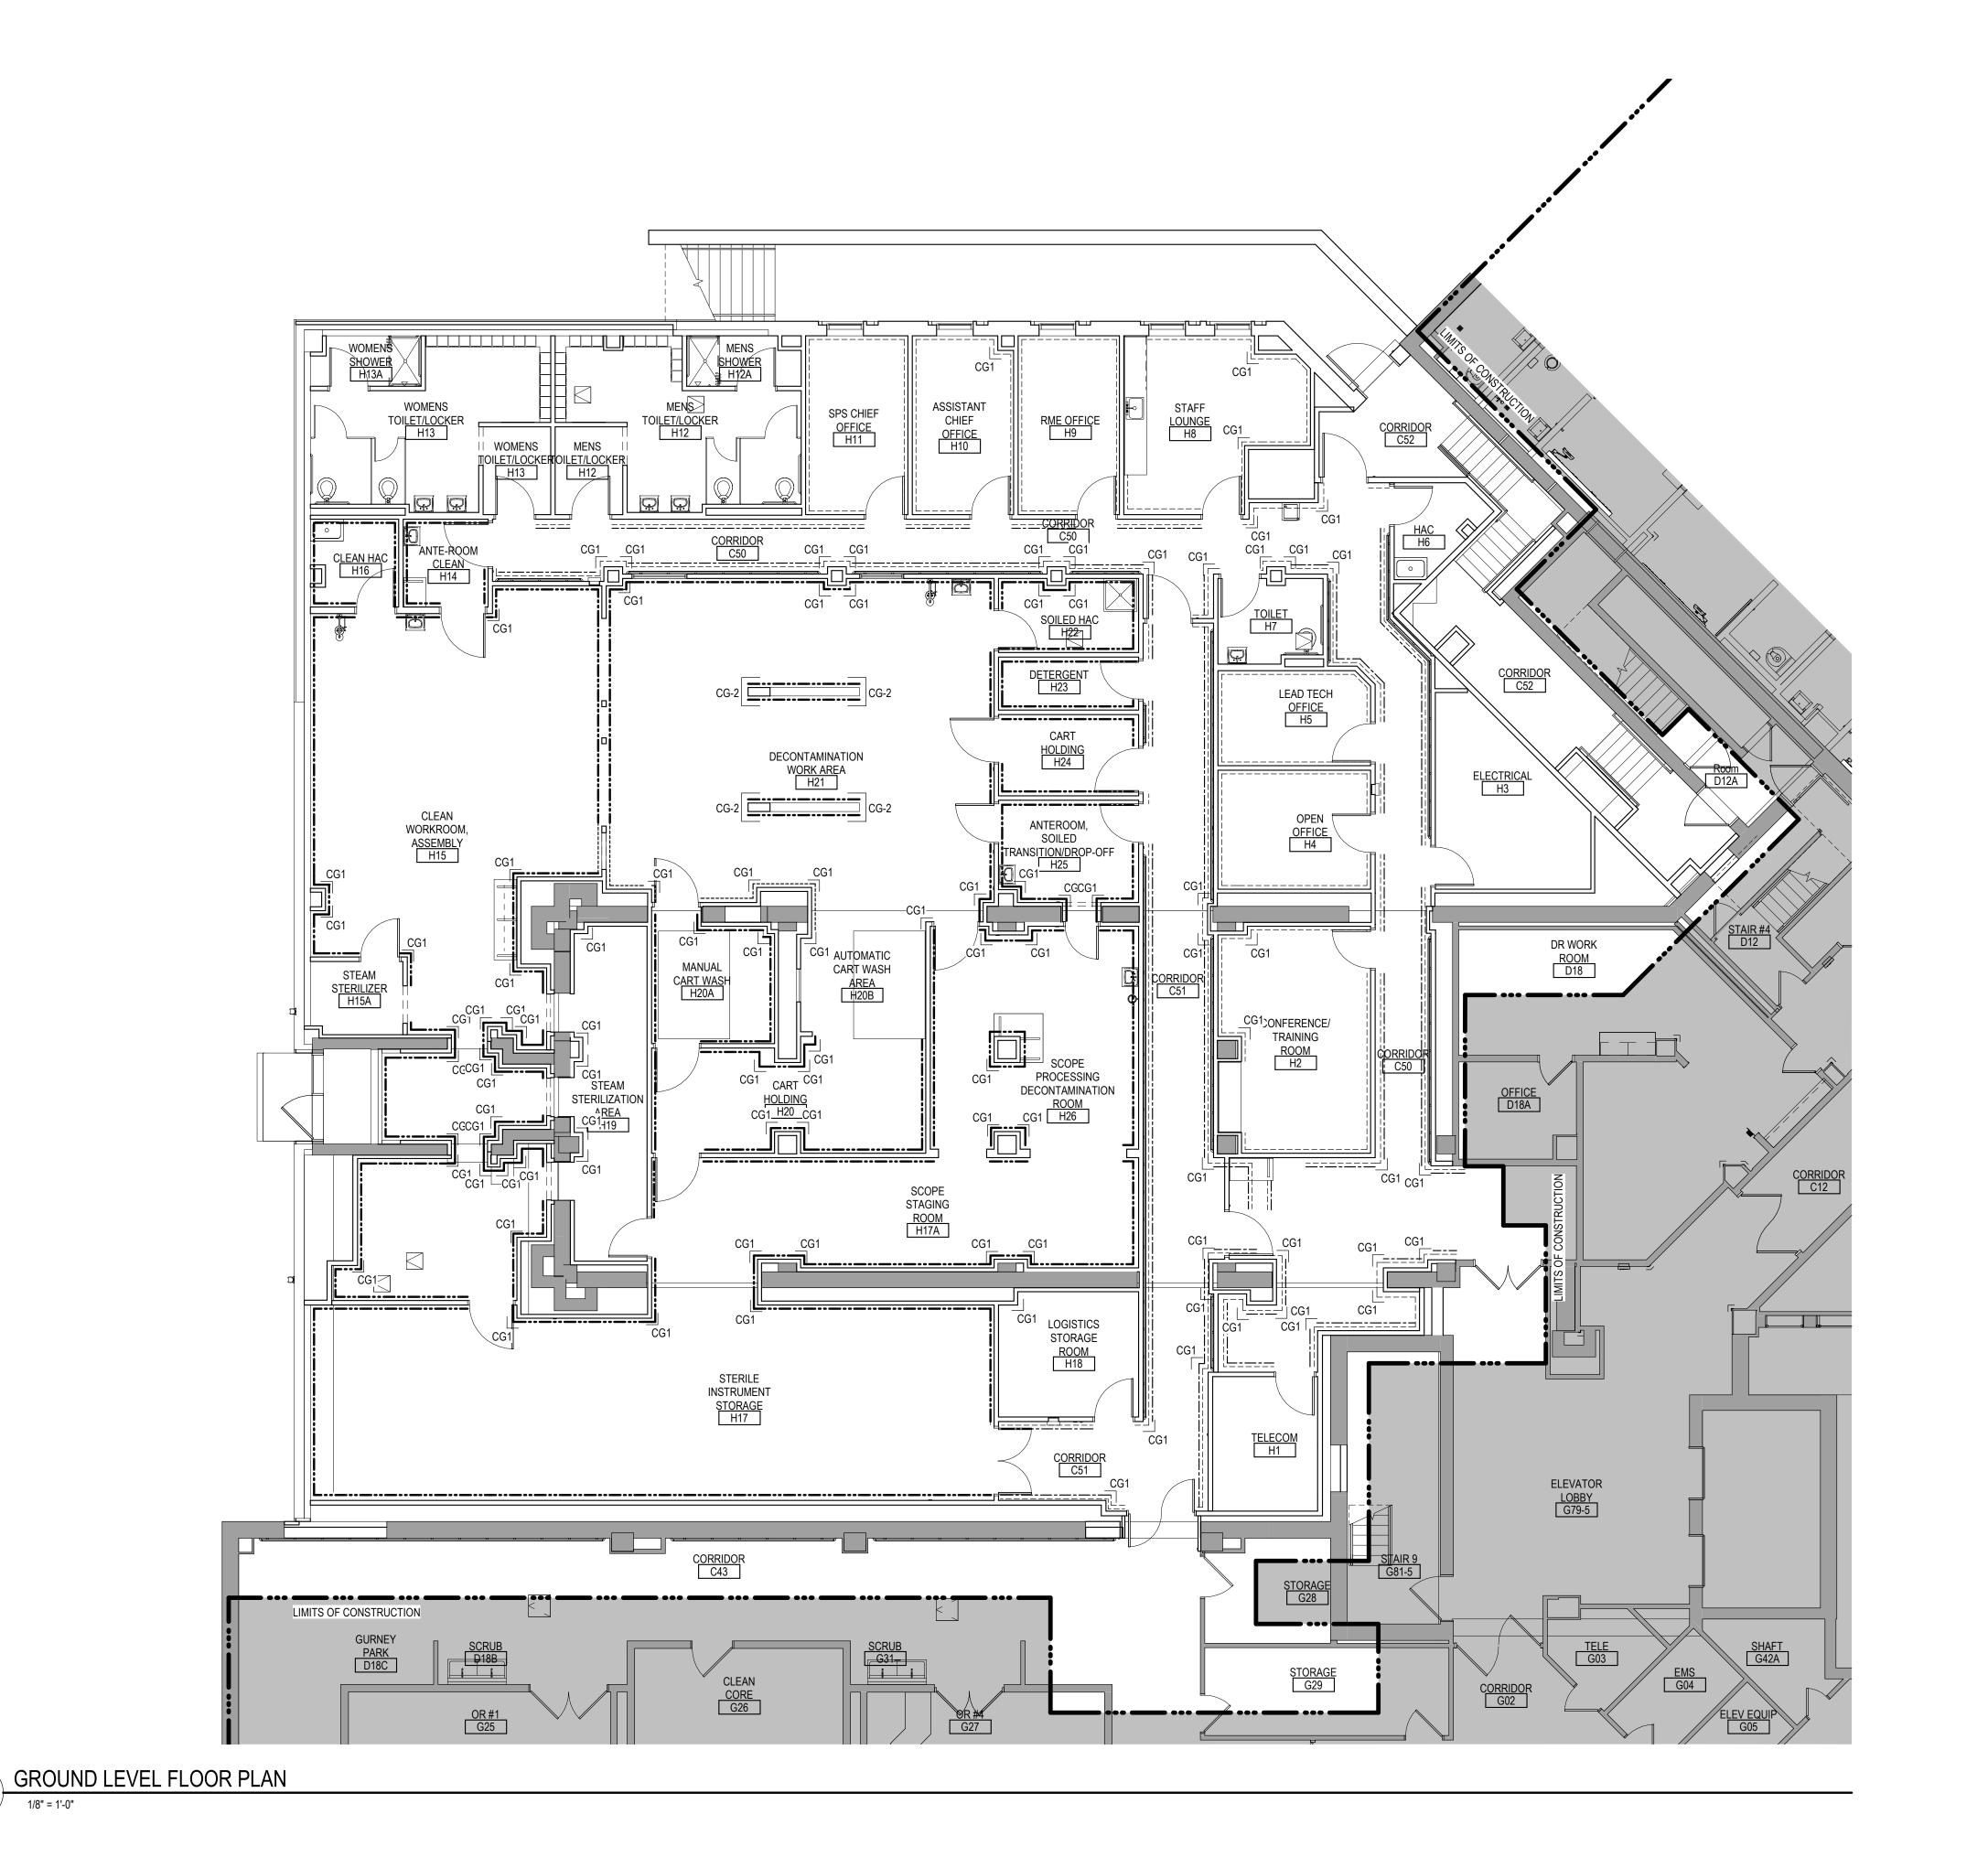

ROOM FINISH LEGEND &
ABBREVIATIONS

CG CORNER GUARD AF10 KEYNOTE

MATERIAL INSTALL DIRECTION

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MATERIAL

WALL PROTECTION LEGEND

WP-1: 48" ABOVE
BASE FINSH (1/4"
OVERLAP)
WP-2 FULL SHEET:
SEE 3 / AF600
FOR HEIGHT &
TRANSITION DETAILS

CRASH RAIL

HANDRAIL


NOTE: NOT ALL SYMBOLS MAY BE USED ON EACH PLAN


		CONSULTANT	ARCHITECT/ENGINEER OF RECORD   s	STAMP	Office of	GROUND LEVEL WALL	Phase	'	Project Title  CONSTRUCT NEW SPS	Project Numl 438-460
		<b>MEG</b>	ANDEDCON	I hereby certify that this plan, specification or report was prepared by me or under my direct supervision and that I am a duly Licensed Architect under the laws of the State of Minnesota.  Name:  Tom Olesak	Construction and Facilities Management	PROTECTION PLAN	BID DOCUMENTS			Building Nun
		2882 106th St, Urbandale, IA 50322	ANDERSON					Location Sioux Falls, S	Drawing Nun	
Revisions:	Date:	Date:	13605 1st Ave. N. #100 Plymouth, MN 55441 P 763.412.4000   F 763.412.4090   ae-mn.com Anderson Engineering of Minnesota, LLC   Proj # 16584	Date: 02/14/2025  License Number: 18157	U.S. Department of Veterans Affairs	Approved:	FULLY SPRINKLERED	Issue Date 02/14/2025	Checked D	awn MRP


					ROOM F	FINISH SC	HEDULE		
				WALL FINISH					
NO.	NAME	FLOOR FINISH	BASE FINISH	NORTH	EAST	SOUTH	WEST	CEILING FINISH	REMARKS
134	INTERSTITIAL SPACE	EPY-1	RB-1	P-2	P-2	P-2	P-2	EXPOSED	
C50	CORRIDOR	RF-1	RF-1	P-1 / WP-1	P-1 / WP-1	P-1 / WP-1	P-1 / WP-1	ACT-1	
C51	CORRIDOR	RF-1	RF-1	P-1 / WP-1	P-1 / WP-1	P-1 / WP-1	P-1 / WP-1	ACT-1	
C52	CORRIDOR	EPY-1	RB-1	P-1	P-1	P-1	P-1	ACT-1	
H1	TELECOM	SD-1	RB-1	P-2	FP-1	FP-1	FP-1	EXPOSED - P-6	PAINT UNDERSIDE OF METAL DECKING
H2	CONFERENCE/ TRAINING ROOM	RSF-1	RB-1	P-3 / WP-1	P-3 / WP-1	P-3 / WP-1	P-3 / WP-1	ACT-1	
H3	ELECTRICAL	EPY-1	RB-1	P-1	P-1	P-1	P-1	EXPOSED - P-6	PAINT UNDERSIDE OF METAL DECKING
H4	OPEN OFFICE	RSF-1	RB-1	P-1 / WP-1	P-1 / WP-1	P-1 / WP-1	P-1 / WP-1	ACT-1	
H5	LEAD TECH OFFICE	RSF-1	RB-1	P-1 / WP-1	P-1 / WP-1	P-1 / WP-1	P-1 / WP-1	ACT-1	
H6	HAC	RES-1	RES-1	P-1 / WP-1	P-1 / WP-1	P-1 / WP-1	P-1 / WP-1	ACT-1	
H7	TOILET	PT-1	PT-1 COVE	PT-2/PT-4-9/P-3	PT-2/PT-4/P-3	PT-2/P-4/P-3	PT-2/PT-4/P-3	GWB (P-2)	
H8	STAFF LOUNGE	RSF-1	RB-1	P-1 / WP-1	P-1 / WP-1	P-1 / WP-1	P-1 / WP-1 / PT-3	ACT-1	
H9	RME OFFICE	RSF-1	RB-1	P-1 / WP-1	P-1 / WP-1	P-1 / WP-1	P-1 / WP-1	ACT-1	
H10	ASSISTANT CHIEF OFFICE	RSF-1	RB-1	P-1 / WP-1	P-1 / WP-1	P-1 / WP-1	P-1 / WP-1	ACT-1	
H11	SPS CHIEF OFFICE	RSF-1	RB-1	P-1 / WP-1	P-1 / WP-1	P-1 / WP-1	P-1 / WP-1	ACT-1	
H12	MENS TOILET/LOCKER	PT-1	PT-1 COVE	PT-2/PT-4/P-3	PT-2/PT-4/P-3	PT-2/P-4/P-3	PT-2/PT-4/P-3	GWB (P-2)	
H12A	MENS SHOWER	PT-3	PT-1 COVE	PT-2	PT-2	PT-2	PT-2	GWB (P-2)	
H13	WOMENS TOILET/LOCKER	PT-1	PT-1 COVE	PT-2/PT-4-9/P-3	PT-2/PT-4/P-3	PT-2/P-4/P-3	PT-2/PT-4/P-3	GWB (P-2)	
H13A	WOMENS SHOWER	PT-3	PT-1 COVE	PT-2	PT-2	PT-2	PT-2	GWB (P-2)	
H14	ANTE-ROOM CLEAN	RES-1	RES-1	RES-W 1 / WP-2	RES-W 1 / WP-2	RES-W 1 / WP-2	RES-W 1 / WP-2	GWB (RES-W1)	
H15	CLEAN WORKROOM, ASSEMBLY	RES-1	RES-1	RES-W 1 / WP-2	RES-W 1 / WP-2	RES-W 1 / WP-2	RES-W 1 / WP-2	GWB (RES-W1)	
H15A	STEAM STERILIZER	RES-1	RES-1	RES-W 1 / WP-2	RES-W 1 / WP-2	RES-W 1 / WP-2	RES-W 1 / WP-2	EXPOSED - P-6	PAINT UNDERSIDE OF METAL DECKING
H16	CLEAN HAC	RES-1	RES-1	RES-W 1 / WP-2	RES-W 1 / WP-2	RES-W 1 / WP-2	RES-W 1 / WP-2	GWB (RES-W1)	
H17	STERILE INSTRUMENT STORAGE	RES-1	RES-1	RES-W 1 / WP-2	RES-W 1 / WP-2	RES-W 1 / WP-2	RES-W 1 / WP-2	ACT-2	
H17A	SCOPE STAGING ROOM	RES-1	RES-1	RES-W 1 / WP-2	RES-W 1 / WP-2	RES-W 1 / WP-2	RES-W 1 / WP-2	ACT-2	
H18	LOGISTICS STORAGE ROOM	RES-1	RES-1	RES-W 1 / WP-2	RES-W 1 / WP-2	RES-W 1 / WP-2	RES-W 1 / WP-2	ACT-2	
H19	STEAM STERILIZATION AREA	RES-1	RES-1	RES-W1	RES-W1	RES-W1	RES-W1	EXPOSED - P-6	PAINT UNDERSIDE OF METAL DECKING
H20	CART HOLDING	RES-1	RES-1	WP-2	WP-2	WP-2	WP-2	GWB (RES-W1)	
H20A	MANUAL CART WASH	RES-1	RES-1	WP-2	WP-2	WP-2	WP-2	GWB (RES-W1)	
H20B	AUTOMATIC CART WASH AREA	RES-1	RES-1	RES-W1	RES-W1	RES-W1	RES-W1	EXPOSED - P-6	PAINT UNDERSIDE OF METAL DECKING
H21	DECONTAMINATION WORK AREA	RES-1	RES-1	RES-W1/WP-2	RES-W1/WP-2	RES-W1/WP-2	RES-W1/WP-2	GWB (RES-W1)	
H22	SOILED HAC	RES-1	RES-1	RES-W1/WP-2	RES-W1/WP-2	RES-W1/WP-2	RES-W1/WP-2	GWB (RES-W1)	
H23	DETERGENT	RES-1	RES-1	RES-W1/WP-2	RES-W1/WP-2	RES-W1/WP-2	RES-W1/WP-2	GWB (RES-W1)	
H24	CART HOLDING	RES-1	RES-1	RES-W1/WP-2	RES-W1/WP-2	RES-W1/WP-2	RES-W1/WP-2	GWB (RES-W1)	
H25	ANTEROOM, SOILED TRANSITION/DROP-OFF	RES-1	RES-1	RES-W1/WP-2	RES-W1/WP-2	RES-W1/WP-2	RES-W1/WP-2	GWB (RES-W1)	
H26	SCOPE PROCESSING DECONTAMINATION ROOM	RES-1	RES-1	RES-W1/WP-2	RES-W1/WP-2	RES-W1/WP-2	RES-W1/WP-2	GWB (RES-W1)	

NOTE: WP-2 TO BE APPLIED AS FULL SHEET (96"). INSTALL ABOVE BASE TO 8'6" WITH RES-W1 ABOVE AT 9'0" CEILING HEIGHT. INSTALL ABOVE BASE TO CEILING AT 8'6" CEILING

HEIGHT. SEE 3/AF600 FOR TRANSITION DETAILS.

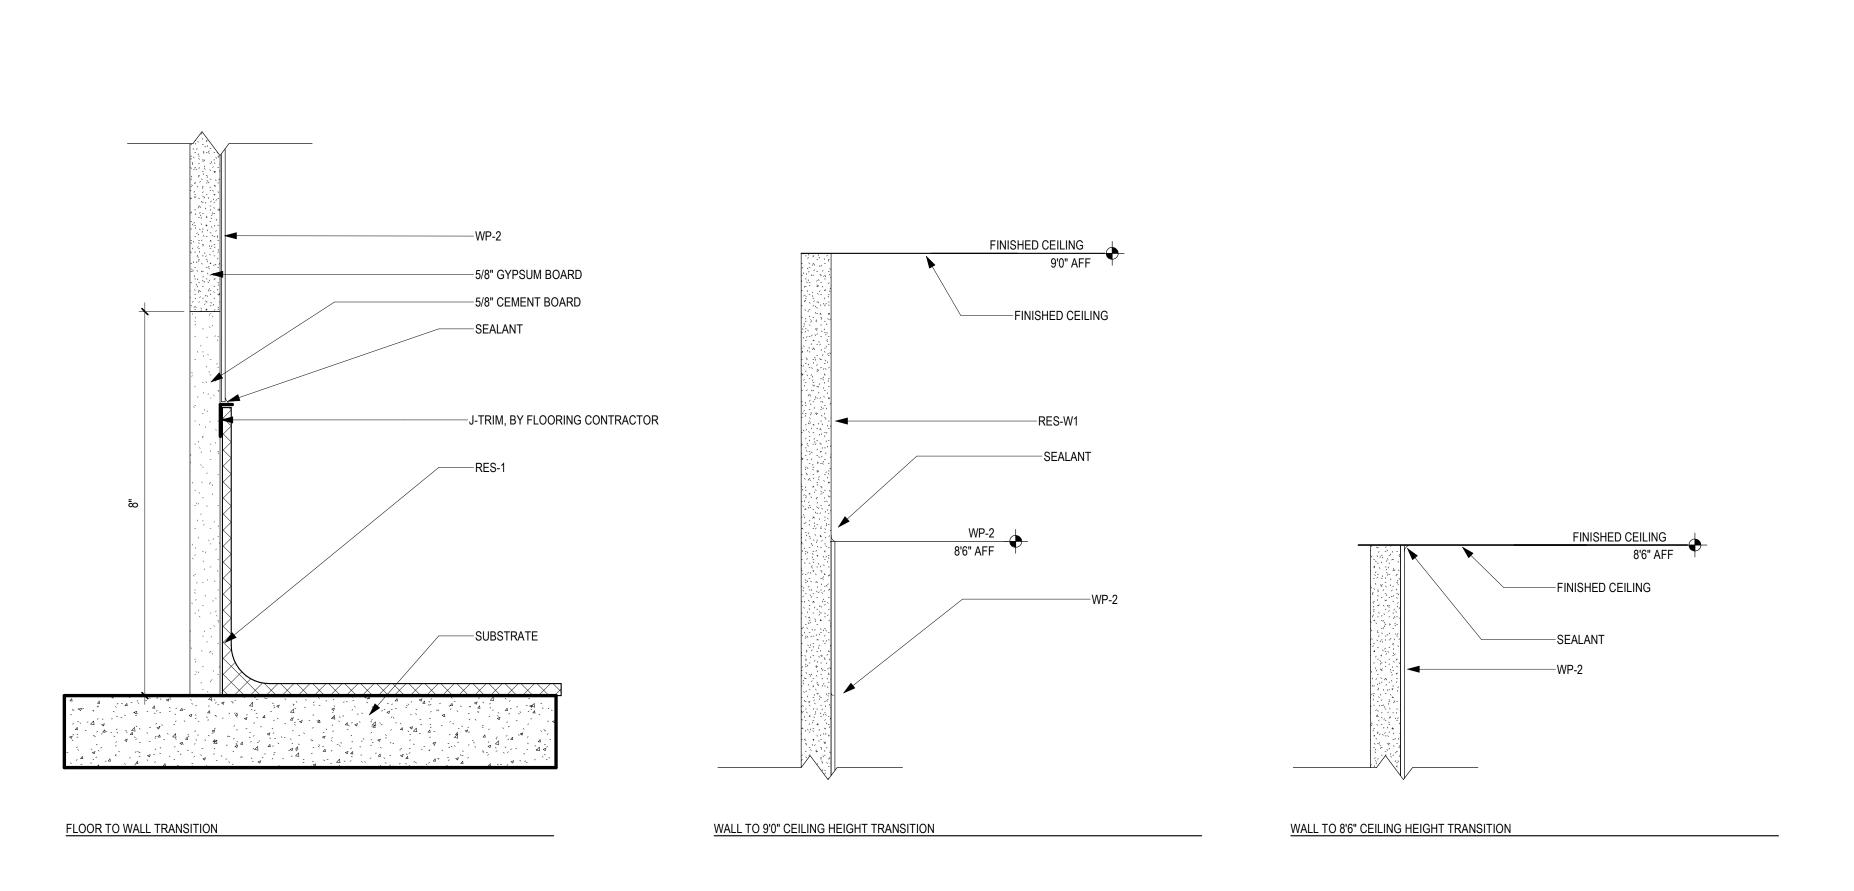

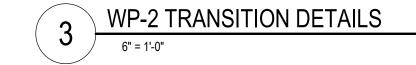

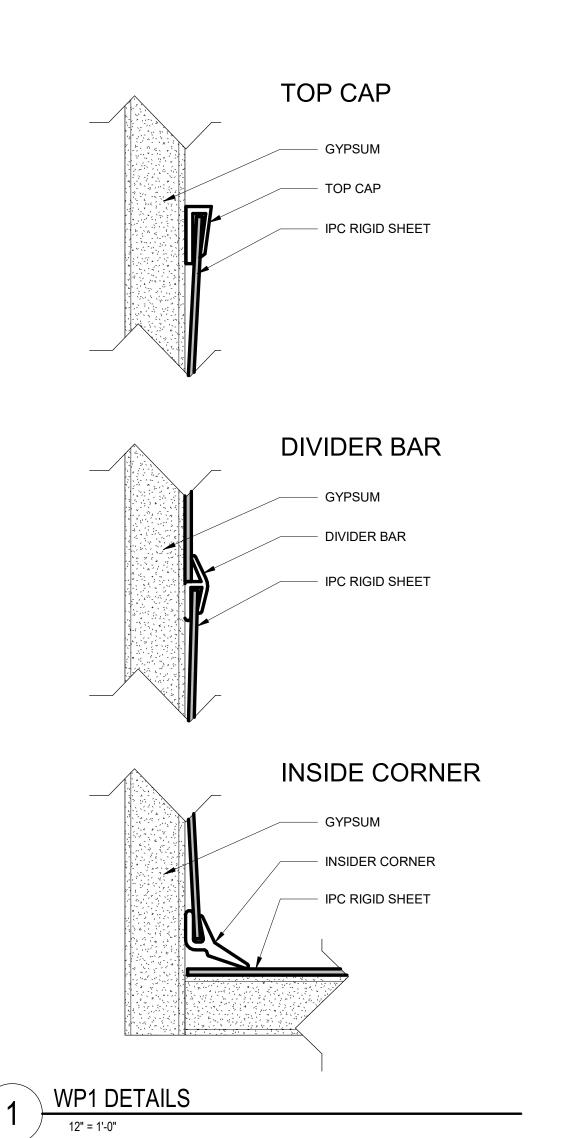

## ROOM FINISH LEGEND & ABBREVIATIONS

CG CORNER GUARD

AF10 KEYNOTE

MATERIAL INSTALL DIRECTION

- AT ACOUSTICAL CEILING (TILE)
- CT CERAMIC TILE

  GWB (SC) GYPSUM WALLBACK SYSTEMS (SPECIAL COATING)
- P PAINT
  PT PORCELAIN TILE (FLOOR AND BASE)
- RB RESILIENT BASE
  RES RESINOUS EPOXY FLOORING
  RES-W RESINOUS/EPOXY WALL/CEILING

LVT LUXURY VINYL TILE

RF RUBBER FLOORING
S SOLID SURFACE

SHALL NOT BE PAINTED.

COLOR AS INDICATED.


- SC SPECIAL COATING
  SP SPECIAL FACED
  WSF WELDED SEAM SHEET FLOORING (HEAT WELDED WITH ROD)
  - NOTE: NOT ALL SYMBOLS MAY BE USED ON EACH PLAN


## FINISH PLAN GENERAL NOTES


- 1. REFER TO PROJECT MANUAL SPECIFICATION SECTION 09 06 00 "SCHEDULE FOR FINISHES" FOR SPECIFIC PRODUCT SELECTION BASIS OF DESIGN AND OTHER REQUIREMENTS.
- 2. FIELD FINISH VENTS, GRILLES, ACCESS PANELS, PLUG STRIP, BASEBOARD RADIATION ENCLOSURES, ELECTRICAL PANEL BOARDS (IN FINISHED SPACES) TO MATCH SURFACE ON WHICH THEY OCCUR UNLESS OTHERWISE INDICATED. EXCEPTION: ITEMS WITH FACTORY WHITE FINISH, OCCURRING ON WHITE ACT OR WHITE GYPSUM BOARD CEILING SHALL NOT BE PAINTED. STAINLESS STEEL ITEMS
- 3. FIELD VERIFY ALL NEW CONDITIONS. NOTIFY ARCHITECT OF ANY DISCREPANCIES PRIOR TO INSTALLATION.
- 4. LOCATE CHANGES IN FLOOR FINISH MATERIAL UNDER CENTERLINE OF CLOSED DOOR UNLESS OTHERWISE INDICATED.
- 5. PROVIDE CLEAR SILICONE SEALANT AT PERIMETER OF PLUMBING FLOOR DRAINS, CLEAN OUTS, ETC IN RESILIENT AND CERAMIC TILE FLOORS.
- 6. PROVIDE SEALANT TO HORIZONTAL AND VERTICAL INTERIOR CERAMIC TILE CORNERS, COLOR TO MATCH GROUT COLOR.
- 7. PROVIDE SEALANT AT JOINT BETWEEN COUNTER TOP, BACK OR SIDE SPLASH
- 8. PROVIDE CLEAR SILICONE SEALANT AT THE BASE OF DOOR FRAME TO RESILIENT AND CT FLOORING, TYP. SEE PLANS AND ROOM FINISH SCHEDULE FOR FLOOR
- FINISH LOCATIONS.
- 9. HOLLOW METAL DOORS AND FRAMES TO BE PAINTED PT-4, UNLESS NOTED OTHERWISE IN THE OPENING SCHEDULE.
- 10. WOOD: PRE-FINISHED TO MATCH BUILDING STANDARD, REFER TO SPECIFICATION.
   11. CEILING HEIGHTS AND MATERIALS/FINISHES CALLED OUT IN ROOM FINISH SCHEDULE ARE FOR ENTIRE CEILING OR MAJORITY OF THAT ROOM, UNLESS OTHERWISE INDICATED. SEE REFLECTED CEILING PLAN FOR CHANGES IN
- 12. COLOR SELECTIONS ARE BASED ON USE OF PRODUCTS INDICATED IN THE PROJECT MANUAL SPECIFICATION. IF MANUFACTURERS OTHER THAN THOSE INDICATED ARE USED, ARCHITECT MAY REVISE COLOR SELECTIONS OF OTHER FINISHES TO ENSURE PROPER COORDINATION.

CEILING MATERIAL AND CEILING HEIGHT. PAINT ALL SURFACES OF SOFFIT SAME

- 13. PAINT ALL FIRE EXTINGUISHER CABINETS TO MATCH COLOR OF THE ADJACENT
- 14. CEILING HEIGHTS ARE MEASURED FROM FINISH FLOOR.
- 15. FOR FLOOR FINISH MATERIALS AND PATTERN, SEE FINISH PLAN.
- 16. SEE INTERIOR ELEVATIONS FOR MORE FINISH INFO.

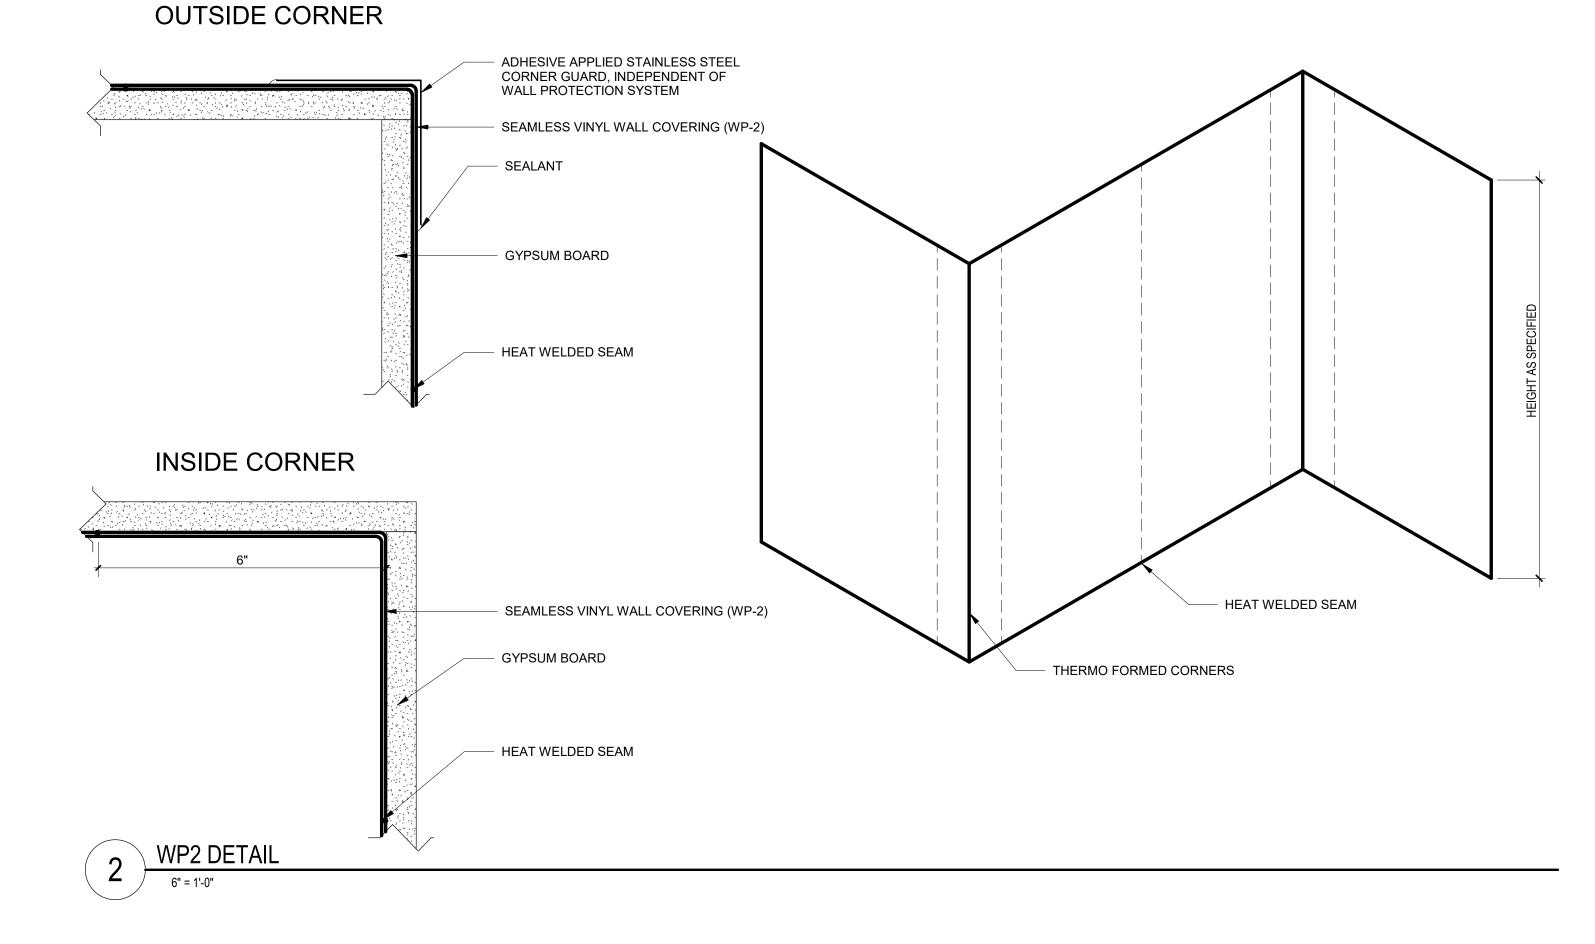

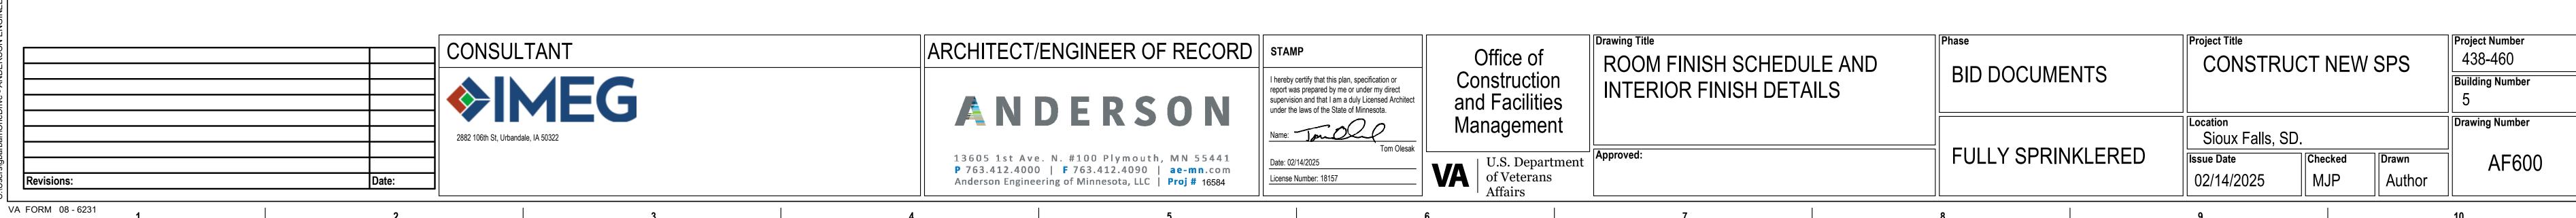

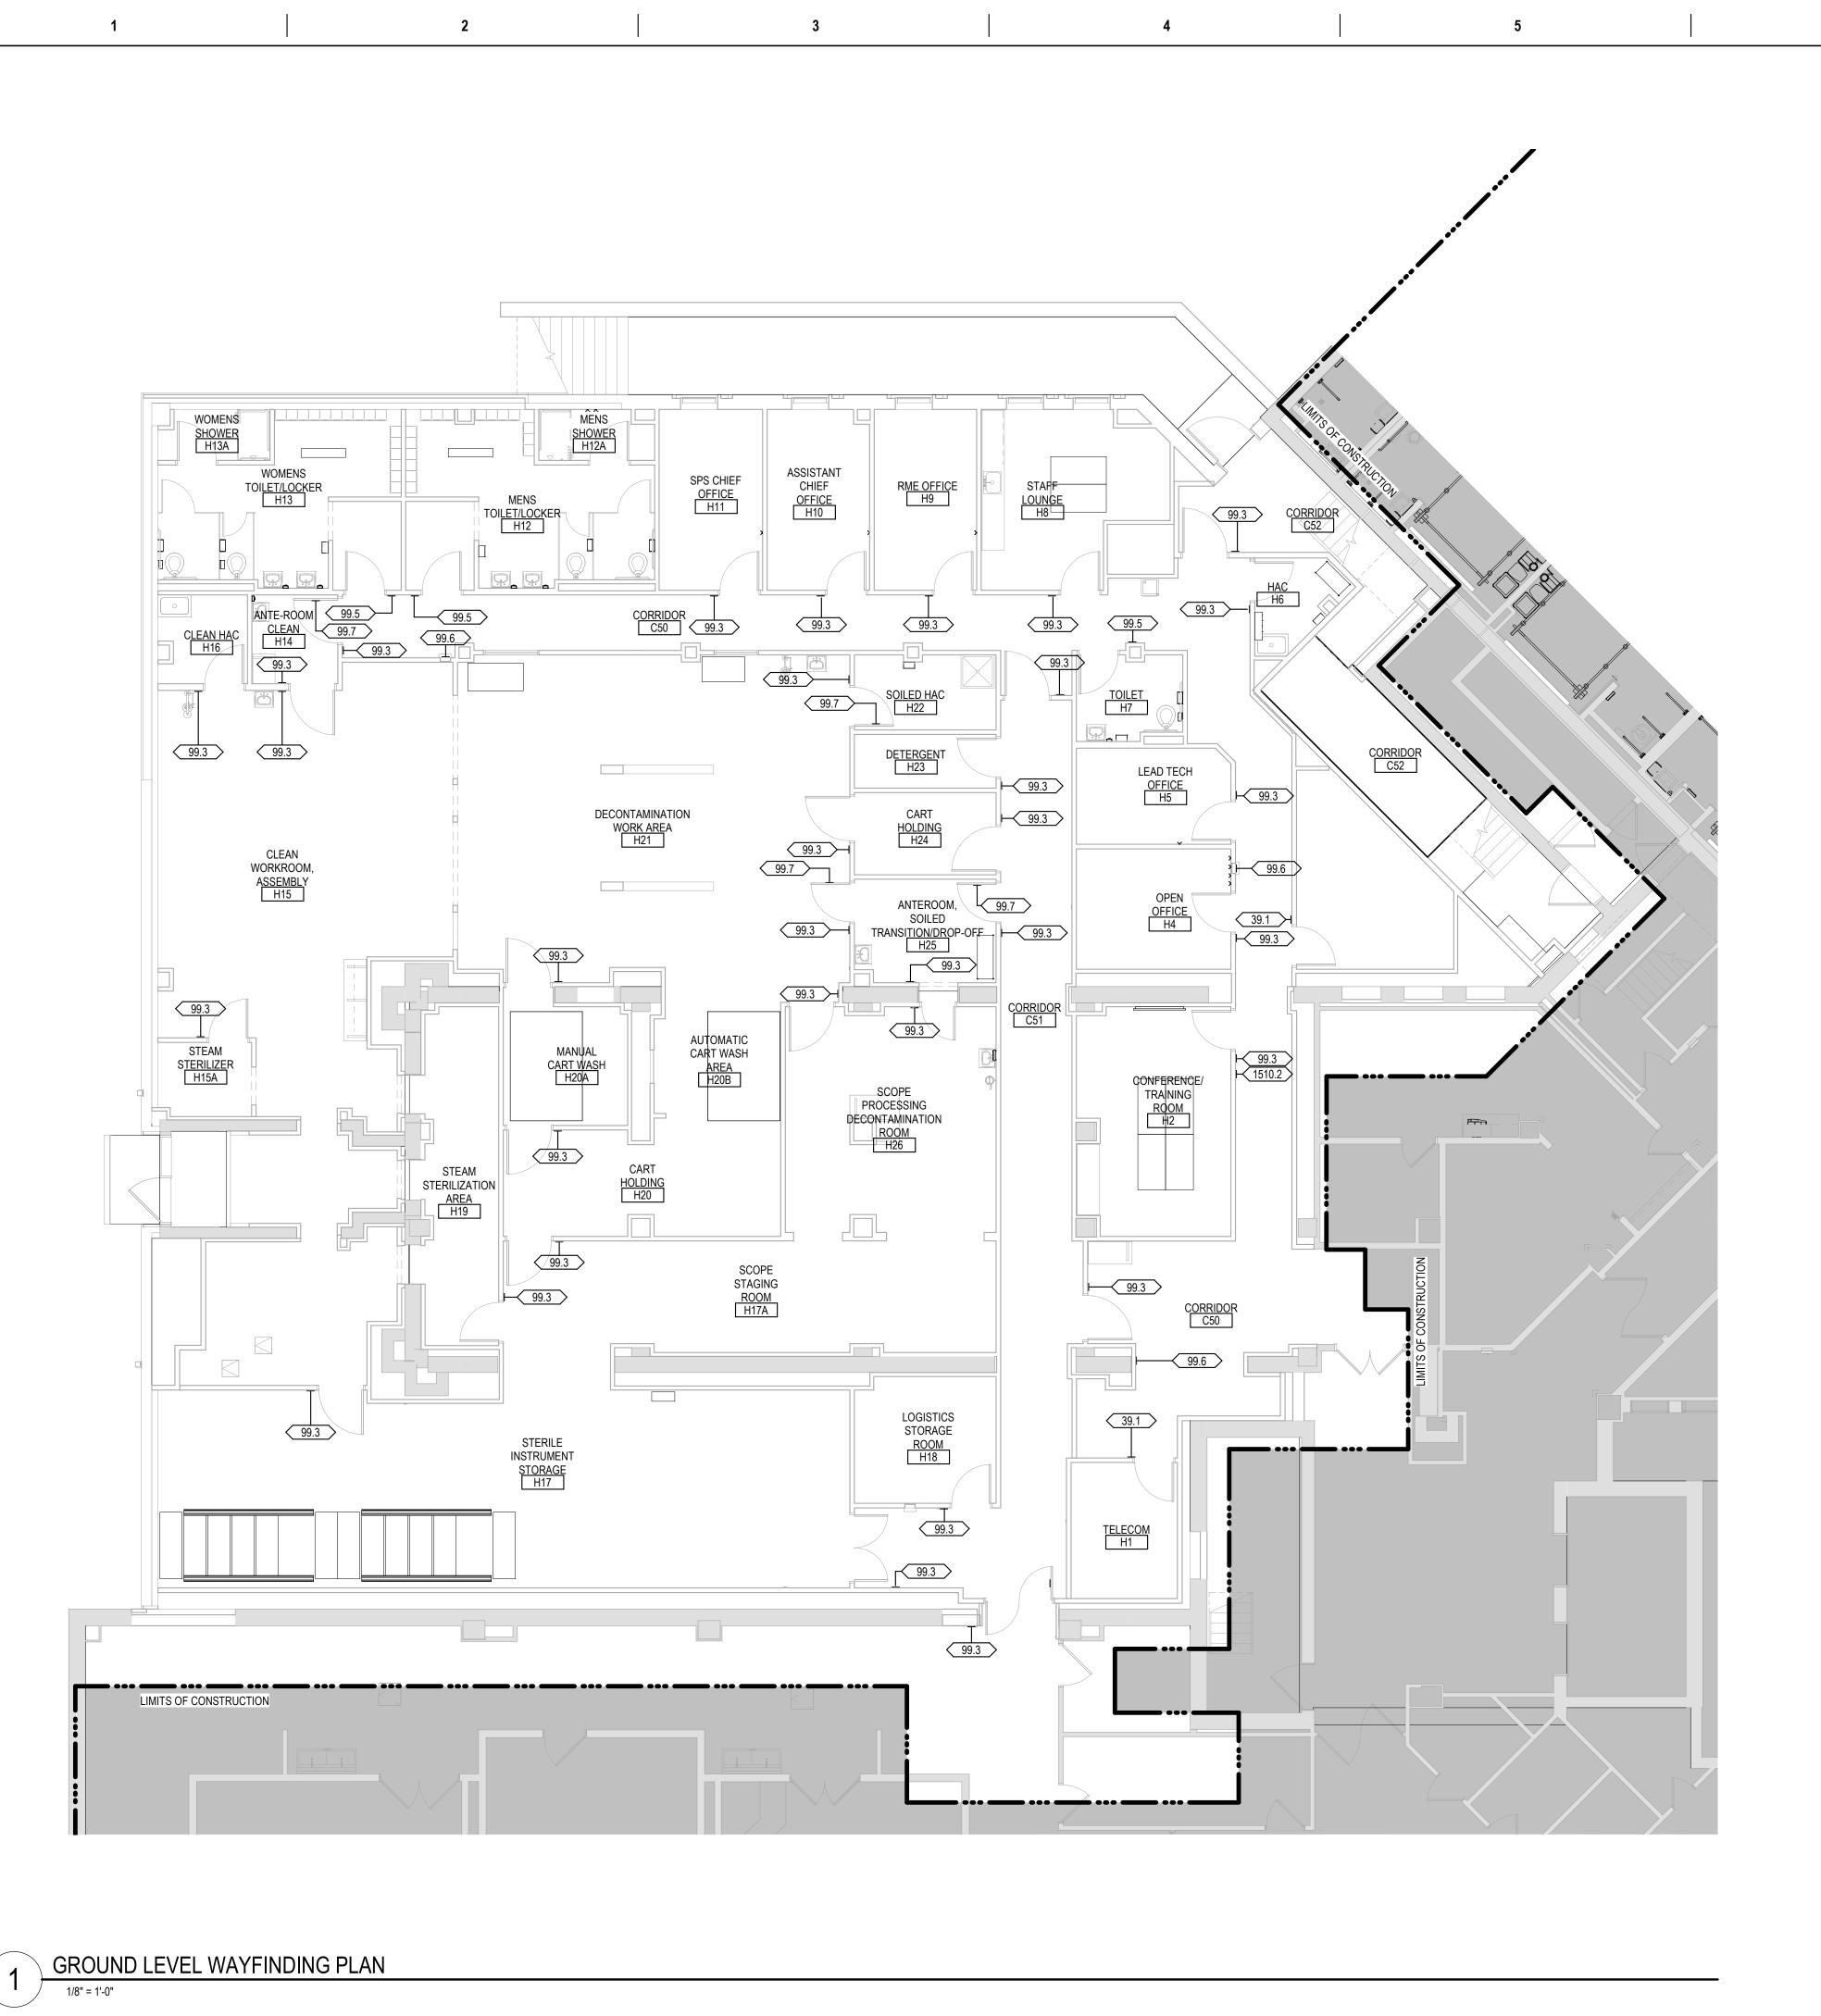

ARCHITECT/ENGINEER OF RECORD | STAMP

ANDERSON

13605 1st Ave. N. #100 Plymouth, MN 55441 P 763.412.4000 | F 763.412.4090 | ae-mn.com

Anderson Engineering of Minnesota, LLC | Proj # 16584

Office of

Construction and Facilities

Management

I hereby certify that this plan, specification or report was prepared by me or under my direct

Name: Janoco

Date: 02/14/2025

License Number: 18157

supervision and that I am a duly Licensed Architect under the laws of the State of Minnesota.

CONSULTANT

Revisions:

VA FORM 08 - 6231

SIGNAGE GENERAL NOTES

1. ALL SIGNAGE IDENTIFYING PERMANENT ROOMS SHALL COMPLY WITH 2010 STANDARD FOR ACCESSIBLE DESIGN.

2. ALL PERMANENT ROOM SIGNAGE TO HAVE TOP SECTION RAISED TEXT AND LOWER SECTION BRAILLE. BRAILLE TO BE GRADE 2.

3. ALL SIGNS TO BE MOUNTED ON LATCH SIDE OF DOOR UNLESS NOTED OTHERWISE. IF NO SPACE EXISTS ON LATCH SIDE MOUNT SIGN TO THE NEAREST ADJACENT

4. SIGNS MUST BE 2" FROM DOOR JAMB WITH 18" CLEAR FLOOR SPACE FROM CENTER OF SIGN.


5. ALL SIGN TEXT AND NUMBERING SUBJECT TO FINAL APPROVAL BY OWNER.

6. ALL SIGNS MOUNTED TO GLASS TO HAVE GLASS BACKER.

7. SIGNS TO BE MOUNTED ACCORDING TO MANUFACTURERS INSTALLATION INSTRUCTIONS AND MATERIALS.

8. SIGN DRAWINGS AND DETAILS ARE FOR REFERENCE ONLY. SIGNAGE TO BE OWNER PROVIDED UNDER SEPARATE CONTRACT.

Drawing Title Project Title Project Number 438-460 GROUND LEVEL WAYFINDING CONSTRUCT NEW SPS BID DOCUMENTS Building Number PLAN Drawing Number Sioux Falls, SD. FULLY SPRINKLERED Drawn Checked VA U.S. Department of Veterans Affairs AW101 MRP 02/14/2025 MJP

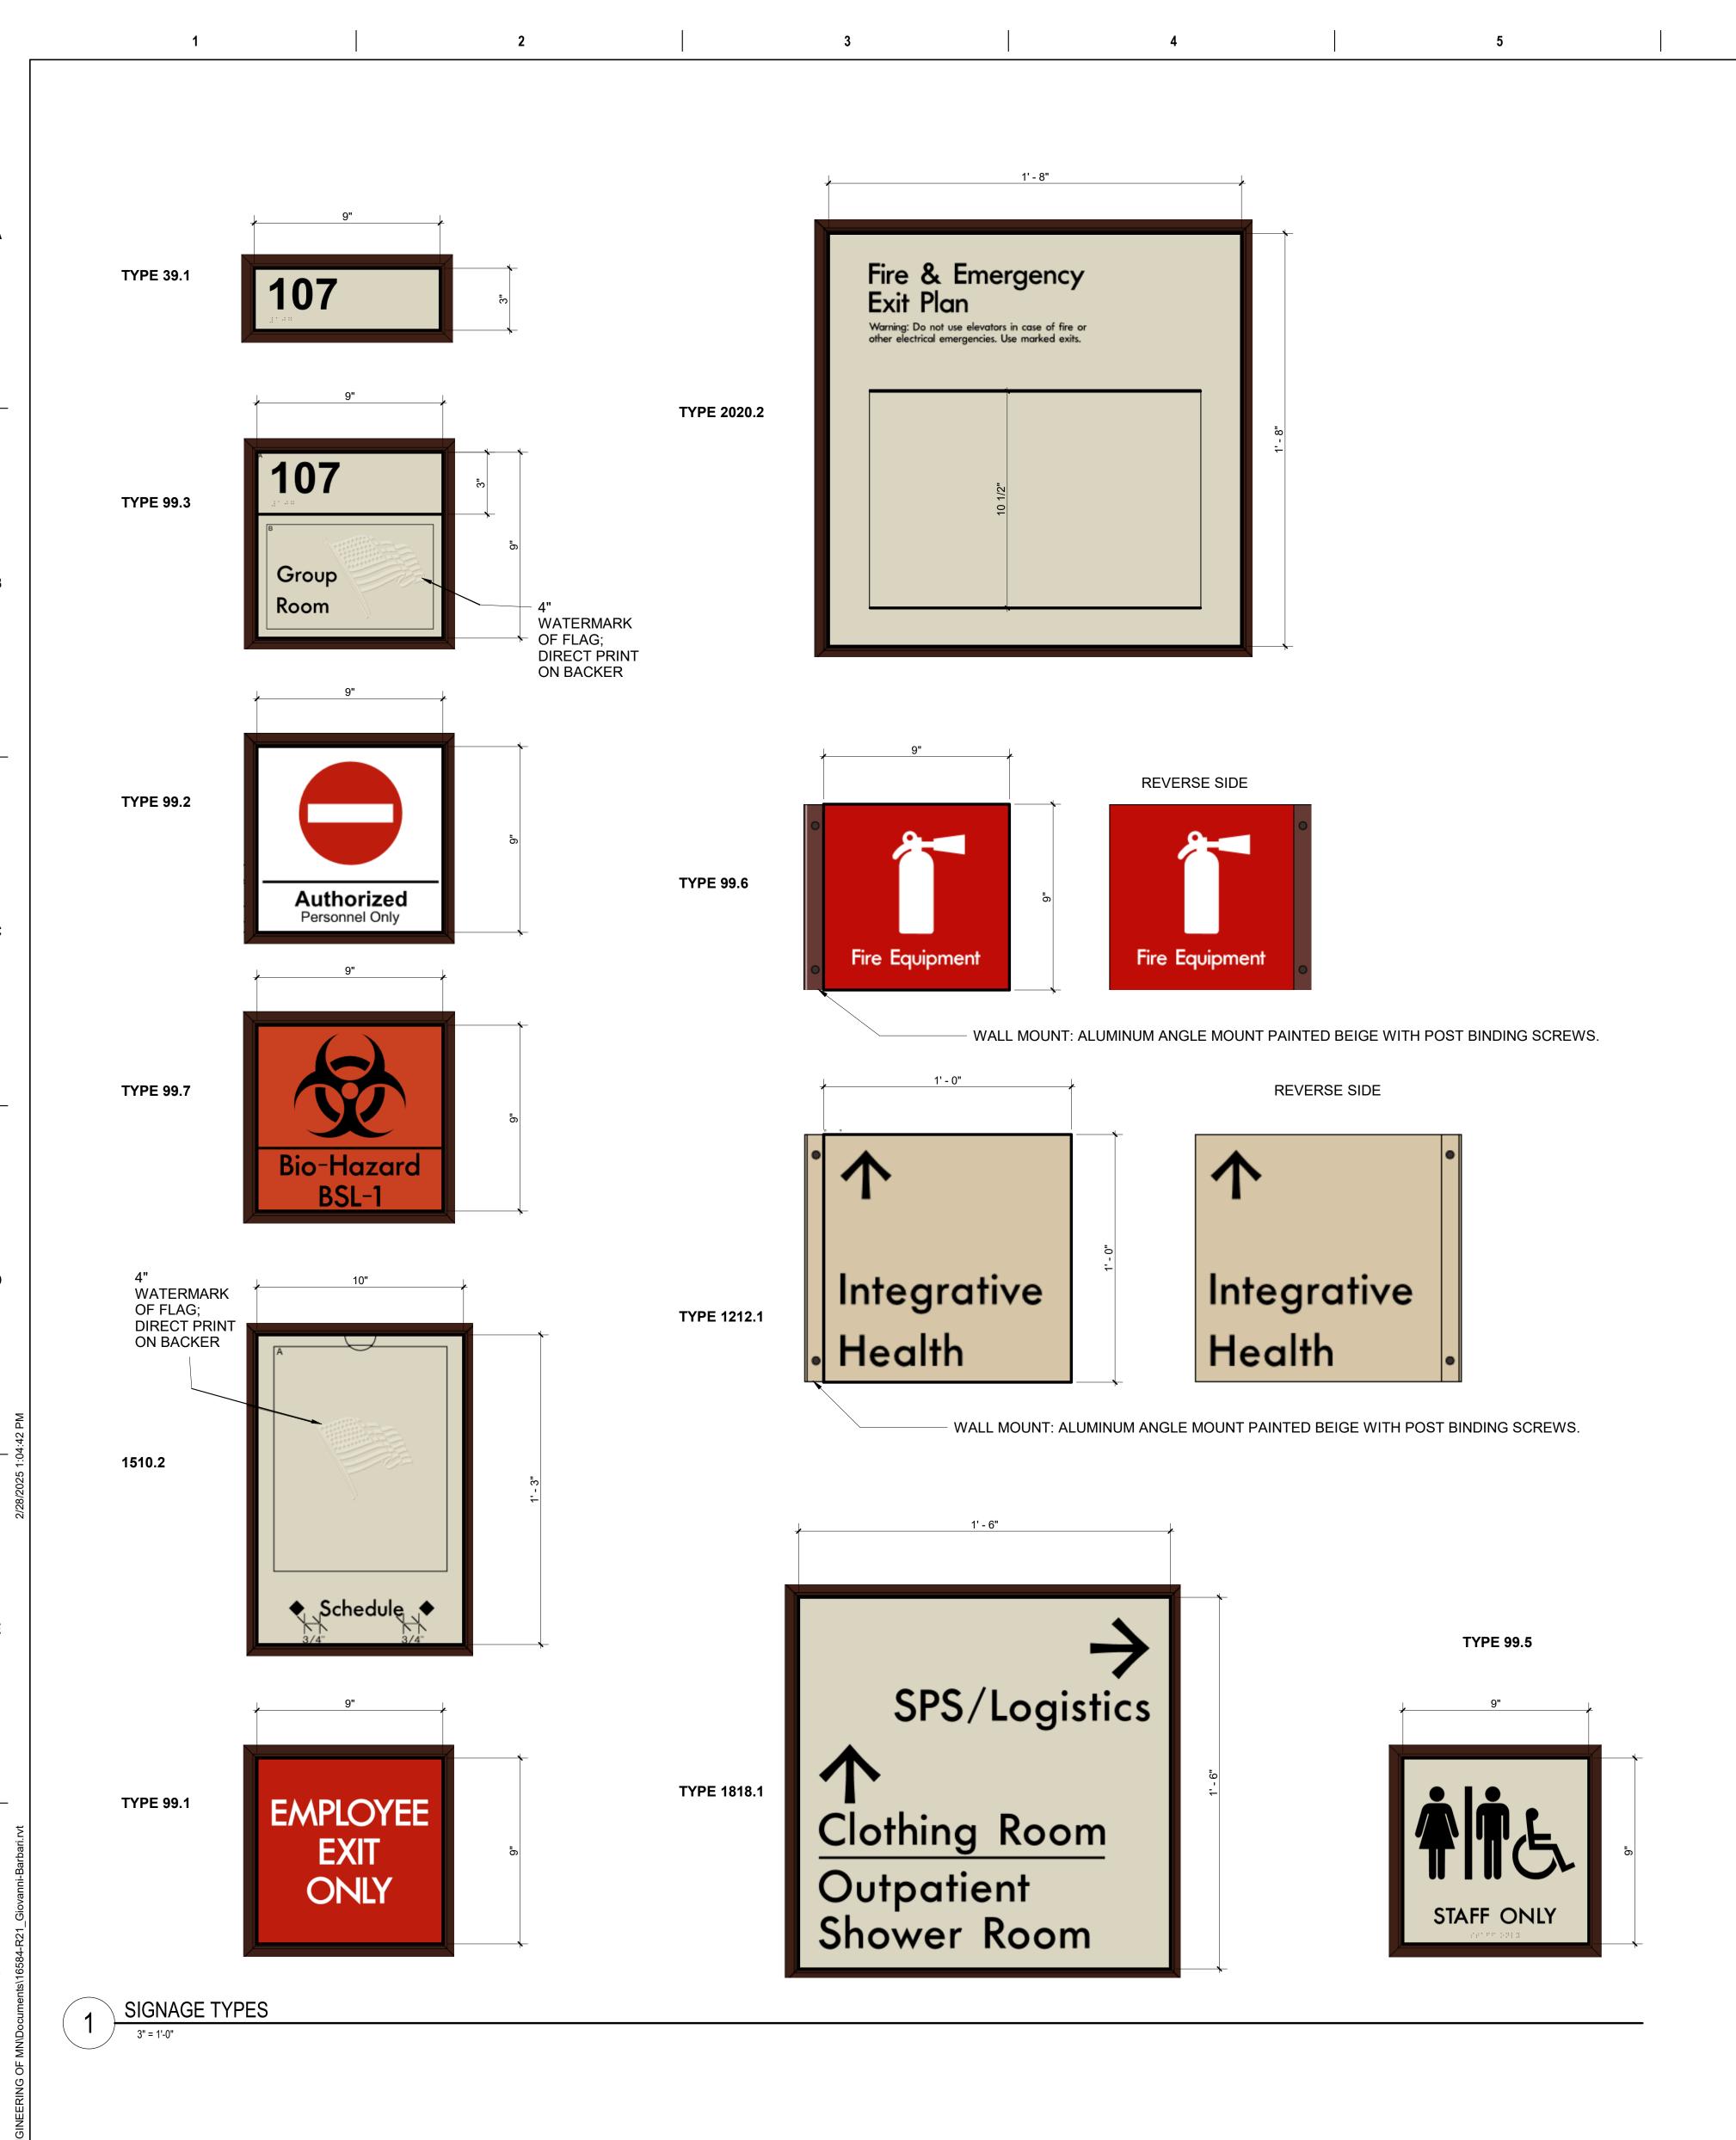

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Revisions:

VA FORM 08 - 6231

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I hereby certify that this plan, specification or report was prepared by me or under my direct

Date: 02/14/2025 License Number: 18157

supervision and that I am a duly Licensed Architect under the laws of the State of Minnesota.

LOCATION	SIGN MESSAGE	SIGN TYPE	REMARKS
	DIOUAZADO	00.7	
OF0	BIOHAZARD	99.7	
C50	STERILE PROCESSING SERVICES	99.3	
C50	FIRE EQUIPMENT	99.6	
C50	FIRE EQUIPMENT	99.6	
C50	FIRE EQUIPMENT	99.6	
C51	STERILE PROCESSING SERVICES	99.3	
C51	CORRIDOR	99.3	
C51	STERILE PROCESSING SERVICES	99.3	
H1	N/A	39.1	
H2	CONFERENCE/ TRAINING ROOM	99.3	
H2	SCHEDULE	1510.2	
H3	N/A	39.1	
H4	OPEN OFFICE	99.3	
H5	LEAD TECH OFFICE	99.3	
H6	HAC	99.3	
H7	TOILET	99.5	
H8	STAFF LOUNGE	99.3	
H8	STAFF LOUNGE	99.3	
H9	RME OFFICE	99.3	
H10	ASSISTANT CHIEF OFFICE	99.3	
<del>-</del> 111	SPS CHIEF OFFICE	99.3	
<del>-</del> 112	MENS TOILET/LOCKER	99.5	
H13	WOMEN'S TOILET/LOCKER	99.5	
H14	ANTE-ROOM CLEAN	99.3	
H14	ANTEROOM, CLEAN	99.3	
H14	ANTE-ROOM CLEAN	99.3	
H14	ANTEROOM, CLEAN	99.7	
H15	CLEAN WORKROOM, ASSEMBLY	99.3	
H15A	STEAM STERILIZER	99.3	
H16	CLEAN HAC	99.3	
H17	STERILE INSTRUMENT STORAGE	99.3	
H18	LOGISTICS STORAGE ROOM	99.3	
H19	STEAM STERILIZATION AREA	99.3	
H20	CART HOLDING	99.3	
H20A	CART WASH	99.3	
H20A	MANUAL CART WASH	99.3	
H22	SOLIED HAC	99.3	
H22	BIOHAZARD	99.7	
H23	DETERGENT	99.7	
n23 H24	CART HOLDING	99.3	
п <u>24                                    </u>	CART HOLDING  CART HOLDING	99.3	
		99.3	
H25	ANTEROOM, SOILED TRANSITION/DROP-OFF		
H25	ANTEROOM, SOLIED TRANSITION/DROP OFF	99.3	
H25	ANTEROOM, SOILED TRANSITION/DROP-OFF	99.3	
H25	ANTEROOM, SOILED TRANSITION/DROP-OFF	99.3	
H25	BIOHAZARD	99.7	

SCOPE PROCESSING DECONTAMINATION ROOM 99.3

SIGN MESSAGE SCHEDULE


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- 6. ALL SIGNS MOUNTED TO GLASS TO HAVE GLASS BACKER.
- 7. SIGNS TO BE MOUNTED ACCORDING TO MANUFACTURERS INSTALLATION INSTRUCTIONS AND MATERIALS.
- 8. SIGN DRAWINGS AND DETAILS ARE FOR REFERENCE ONLY. SIGNAGE TO BE OWNER PROVIDED UNDER SEPARATE CONTRACT.

Office of onstruction of Facilities	Drawing Title WAYFINDING MESSAGE SCHEDULES & SIGNAGE DETAILS	Phase BID DOCUMENTS	Project Title CONSTRUCT NEW SPS			Project Number 438-460  Building Number 5
anagement    U.S. Department	Approved:	FULLY SPRINKLERED	Location Sioux Falls, SD.  Issue Date		Drawn	Drawing Number  AW601
of Veterans Affairs			02/14/2025	MJP	MRP	AVVOUT

VA ACQUISITION CODE LEGEND CONTRACTOR FURNISHED AND INSTALLED VA FURNISHED - CONTRACTOR INSTALLED VA FURNISHED AND INSTALLED VA FURNISHED - CONTRACTOR INSTALLED WITH CONSTRUCTION FUNDS VC(CF) VA FURNISHED - VA INSTALLED WITH CONSTRUCTION FUNDS RELOCATED SEE DRAWINGS AND SPECIFICATIONS FOR ADDITIONAL CONTRACTOR FURNISHED AND CONTRACTOR INSTALLED (CC) EQUIPMENT NOT INDICATED ON EQUIPMENT

QUIPMENT # EQUIPMENT NAME	MANUFACTURER	DESCRIPTION	ACQUISITION CODE	QTY	ROOM#	ROOM NAME
A0018 RENNCO HEAT SEALER	RENCO	RENNCO HEAT SEALER	VV	QIY 1	H15	CLEAN WORKROOM, ASSEMBLY
A1014 TELEPHONE, WALL MOUNTED	RENOO	NEWWOOTEAT GEALER	VV	7	1110	OLLAN WONTHOOM, AGGLINDET
A1015 TELEPHONE, DESK			VV	8		
A1195 AMSCO 50 STAINLESS STEEL 3 COMPARTMENT SINK 120"	STERIS Corporation	Amsco 50 Reprocessing Sink - 3 Bay/120" Long/Height Adjustable/Left to Right Work Flow (Delivery may be restricted by hallway width. STERIS installation and	VC	4	H21	DECONTAMINATION WORK AREA
A1195A AMSCO 50 STAINLESS STEEL 3 COMPARTMENT REPROCESSING SINK 97.5"	STERIS Corporation	delivery teams to verify prior to shipping.)  Amsco 50 Reprocessing Sink - 3 Bay/97.5" Long/Height Adjustable/Left to Right Work Flow	VC	2	H26	SCOPE PROCESSING DECONTAMINATION ROOM
A5020 BENCH, FLOOR MOUNTED	Scranton Products	Lockers as Specified in 10 51 00	VC	2		
A5075 SOAP DISPENSER			VV	11		
A5077 HAND SANITIZER DISPENSER			VV	8		
A5082 HANDS FREE PAPER TOWEL DISPENSER			VV	12		
A5090 SANITARY NAPKIN DISPOSAL			VV	3	1100	COOPE PROCESSING RECONTAMINATI
A5107 GLOVE DISPNSER (3 BOX)			VV	1	H26	SCOPE PROCESSING DECONTAMINATION ROOM
A5108 SHARPS		A container for collecting and transporting syringes and other sharps for decontamination and disposal. Available in 2 gallon and 8 gallon with locking rotor. Complies with OSHA regulations for handling sharps.		1	H26	SCOPE PROCESSING DECONTAMINATION ROOM
A5135 MOP HOLDER WITH SHELF	Bradley	Utility Shelf w/2 Hooks 3 Holders & 1 Drying Rod - 30" W	V C	3		
	Corporation	, , ,				
A5145 HOOK, GARMENT, DOUBLE		A SURFACE MOUNTED, SATIN FINISH STAINLESS STEEL, GARMENT HOOK, WITH A CONCEALED MOUNTING BRACKET THAT IS SECURED TO A CONCEALED WALL PLATE. FOR GENERAL PURPOSE	VC	12		
A5202 TOILET PAPER HOLDER 2 ROLL WITH SHELF			VV	5		
E2624 SCOPE BLOCK HOLDER				1	H26	SCOPE PROCESSING DECONTAMINATION
F0048 TRANSFER CART	STERIS	Reliance Transfer Cart	VV	9		ROOM
FUU40   INAINOFER CART	Corporation	Indiance Hansier Call	V V	9		
F0860 STAINLESS STEEL TABLE	parament			7		
F2000 TRASH CAN 16" DIA		Wastepaper basket, fire resistant, approximately 40 quart capacity. This unit is used to collect and temporarily store small quantities of paper refuse in patient rooms, administrative areas and nursing stations. Size and shape varies depending on the app	VV	6		
F2010 BASKET, WASTE PAPER, STEP-ON		STEP ON TRASH CAN	VV	1	H7	TOILET
F2015 TRASH CAN 18"x18"		METAL OR PLASTIC WASTEPAPER BASKET WITH SWING DOORS AND	V V	7	1117	TOILLI
12010 110101107110 110		REMOVABLE LID, 18" X 18"	• •	,		
F2700 BAR CODE READER			VV	9		
F3200 CLOCK, BATTERY, 12IN DIA			VV	1	H8	STAFF LOUNGE
M0512 FLAT SCREEN MONITOR 60" WITH WALL BRACKET			VV	4		
M1801 COMPUTER WITH FLAT PANEL MONITOR			VV	14		
M1803 WALL MOUNTED COMPUTER WORKSTATION			VV	8		
M2055 WIRE SHELVING 48"X 18"		STROAGE RACK		10		
M2055A WIRE SHELVING 36"x18"		STROAGE RACK	V C	5	1147	OTEDILE INOTELIMENT OTODACE
M2056 HIGH DENSITY SHELVING SYSTEM M3160 MEDIVATOR ADVANATAGE PLUS AER SCOPE DRYING	CANTEL MEDICAL	78"H X 108"D X 156"W TOTAL ADVANTAGE PLUS AER - Single-side	V V V C	2	H17 H17A	STERILE INSTRUMENT STORAGE SCOPE STAGING ROOM
CABINET	CANTEL WEDICAL	ADVANTAGE FLOS AER - Silligie-side	V C	4	ППА	SCOPE STAGING ROOM
R7250 REFRIGERATOR		REFRIGERATOR	VV	1	H8	STAFF LOUNGE
S0002 3M ATTEST AUTO READER 390		3M ATTEST AUTO READER 390	VV	1	H15	CLEAN WORKROOM, ASSEMBLY
S0003 CENSATRAC SCANNER CHARGING STATION		CENSATRAC SCANNER CHARGING STATION	VV	1	H15	CLEAN WORKROOM, ASSEMBLY
S0004 INCUBATOR, BIOLOGICAL INDICATOR		INCUBATOR, BIOLOGICAL INDICATOR	VV	1	H15	CLEAN WORKROOM, ASSEMBLY
S0005 STRYKER BATTERY CHARGING STATION		STRYKER BATTERY CHARGING STATION	VV	2	H15	CLEAN WORKROOM, ASSEMBLY
S0006 TEE PROBE STORAGE CABINET		TEE PROBE STORAGE CABINET	VC	1	H17	STERILE INSTRUMENT STORAGE
S0007 COUNTERTOP ULTRASONIC CLEANER		COUNTERTOP ULTRASONIC CLEANER	VV	1	H21	DECONTAMINATION WORK AREA
S0046 STERIS AMSCO DRYING CABINET	STERIS Corporation	Amsco Drying Cabinet - 38"/Single Door (110-120 Volt/20 Amp Dedicated Wall Plug)	VC	1	H15	CLEAN WORKROOM, ASSEMBLY
S0442 AMSCO 600 STEAM STERLISER - 26.5x26.5x63"	STERIS Corporation	Amsco 600 Medium Steam Sterilizer - 26.5x26.5x63" (673x673x1600mm)/Single Sliding Door/Recessed/Steam Heat	VC	2	H19	STEAM STERILIZATION AREA
S0442R AMSCO 600 STEAM STERLISER - 26.5x26.5x63"	STERIS	Amsco 600 Medium Steam Sterilizer - 26.5x26.5x63" (673x673x1600mm)/Single	VCR	2		
S0495 STERIS AMSCO 600 LOADING / TRANSFER CART	Corporation STERIS Corporation	Sliding Door/Recessed/Steam Heat  Amsco 600 Loading Car and Transfer Carriage - 26.5x26.5x63"/Fixed Height	VV	4	H15	CLEAN WORKROOM, ASSEMBLY
S0940 STERIS AMSCO 7052HP WASHER / DISINFECTOR	STERIS	AMSCO 7052HP SINGLE-CHAMBER WASHER/DISINFECTOR - DOUBLE	VC	4	H21	DECONTAMINATION WORK AREA
	CORPORATION STERIS CORPORATION	DOOR/STEAM HEAT/VENTED/FLUSH MOUNTED	VC	2	H21	DECONTAMINATION WORK AREA
S0941 STERIS WASHER / DISINFECTOR CONVEYOR SYSTEM	STERIS Corporation	SCS Load/Unload Conveyor System - Single Load/Single Unload	VC	4	H21	DECONTAMINATION WORK AREA
DOOR	STERIS Corporation	SCS-L Motorized Return Conveyor System - 3 Module/Return Door/Flush Mounted	VC	1	H21	DECONTAMINATION WORK AREA
	STERIS Corporation	STERIS Automated Pass-Through Window - Endoscopy Application (40x45" Window)	VC	1	H15	CLEAN WORKROOM, ASSEMBLY
	CANTEL MEDICAL STERIS	ADVANTAGE PLUS Pass-Thru Reprocessor, 230V (with air compressor)  Acu-Hold System - Wall Mounted/ 3 Container	V C	3	H26 H23	SCOPE PROCESSING DECONTAMINATION ROOM  DETERGENT
CONTAINER	Corporation	. See . 18th Cyclotti William Contained	٧٥	-	1.120	JETEROLITI
	STERIS Corporation	InnoWave Unity Ultrasonic Irrigator - 15 Gallon	VC	4	H21	DECONTAMINATION WORK AREA
	STERIS Corporation STERIS	Vision 1327 Cart and Utensil Washer/Disinfector - Standard Orientation/Double Door/Pit Mounted  Amsco V-PRO Max Low Temperature Sterilization System - Single Door/Cabinet	V C	1	H20B H15	AUTOMATIC CART WASH AREA  CLEAN WORKROOM, ASSEMBLY
	Corporation STERIS	Amsco V-PRO Max Low Temperature Sterilization System - Single Door/Cabinet  Amsco Deluxe Prep and Pack Workstation - 36x72"/Electric	VC	6	H15	CLEAN WORKROOM, ASSEMBLY  CLEAN WORKROOM, ASSEMBLY
(ELECTRIC)	Corporation		. 0			The state of the s

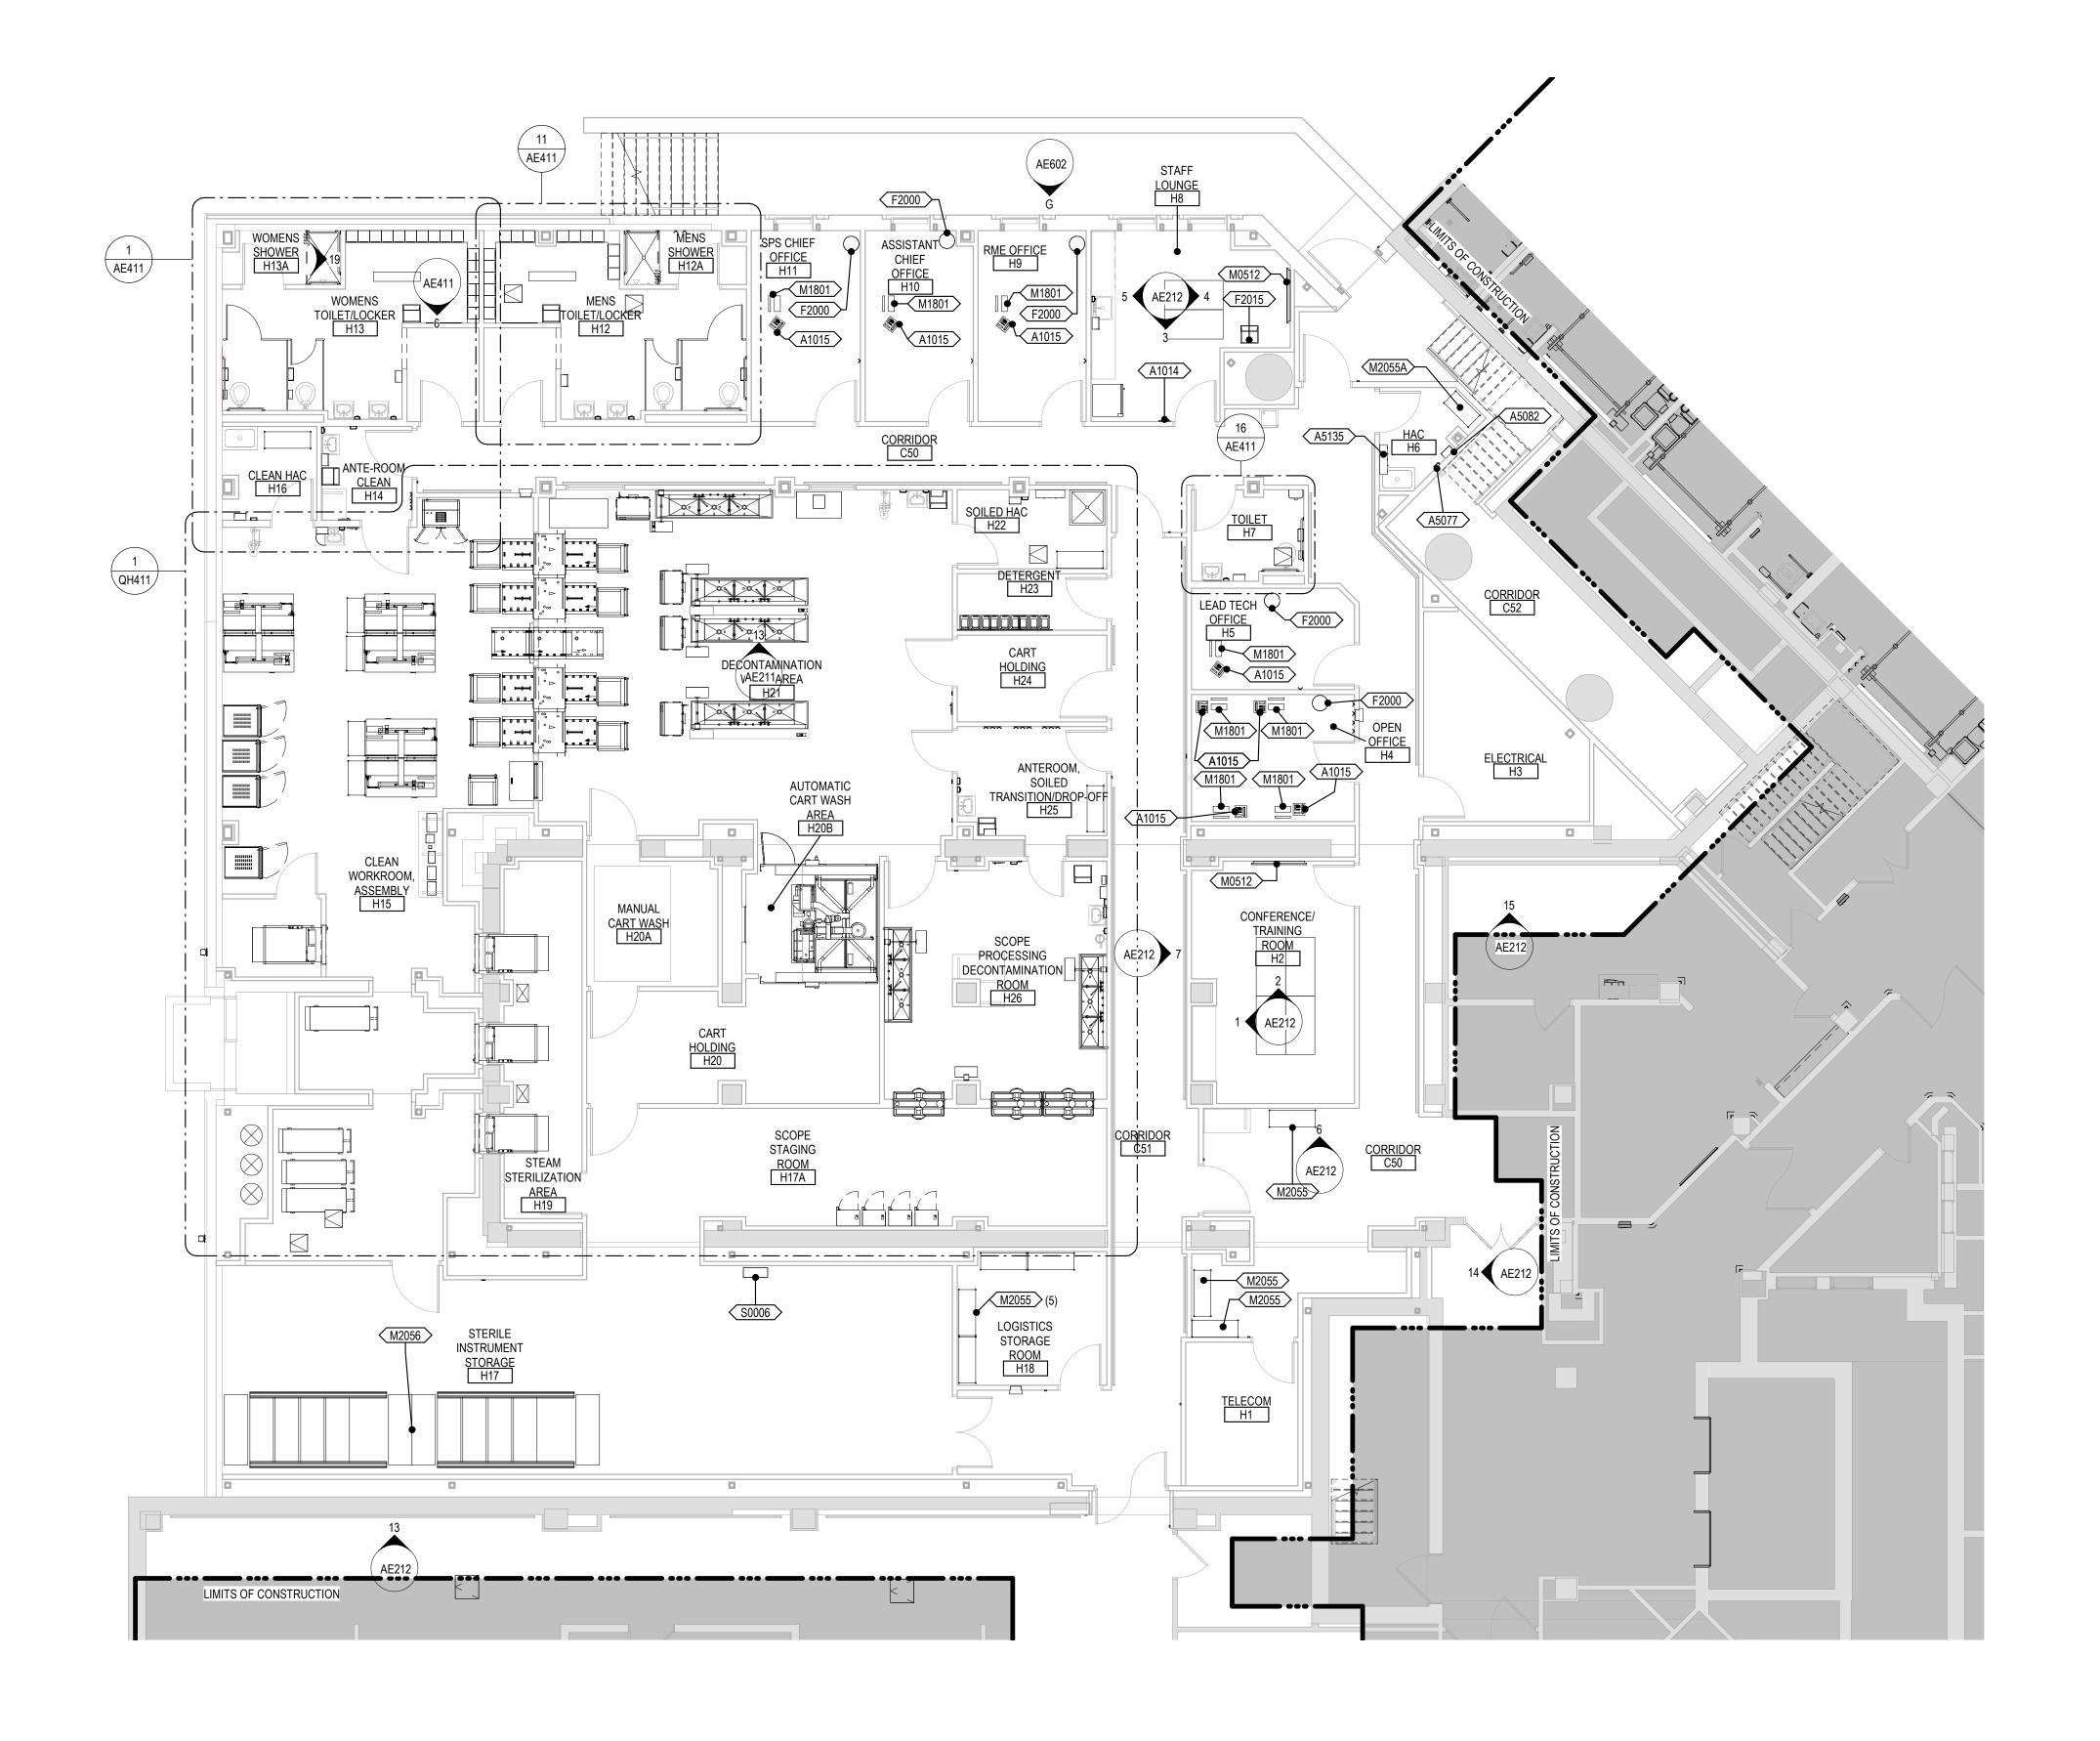

GROUND FLOOR EQUIPMENT PLAN

1/8" = 1'-0"

Revisions:

CONSULTANT

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ARCHITECT/ENGINEER OF RECORD | STAMP I hereby certify that this plan, specification or report was prepared by me or under my direct supervision and that I am a duly Licensed Architect under the laws of the State of Minnesota. Name: Janoco Date: 02/14/2025 License Number: 18157

Office of Construction and Facilities Management

Drawing Title GROUND LEVEL EQUIPMENT PLAN & SCHEDULE

**BID DOCUMENTS** FULLY SPRINKLERED

Project Title Project Number 438-460 CONSTRUCT NEW SPS Building Number Drawing Number Sioux Falls, SD. Checked Drawn QH101

VA FORM 08 - 6231

VA U.S. Department of Veterans Affairs

02/14/2025 GJB